
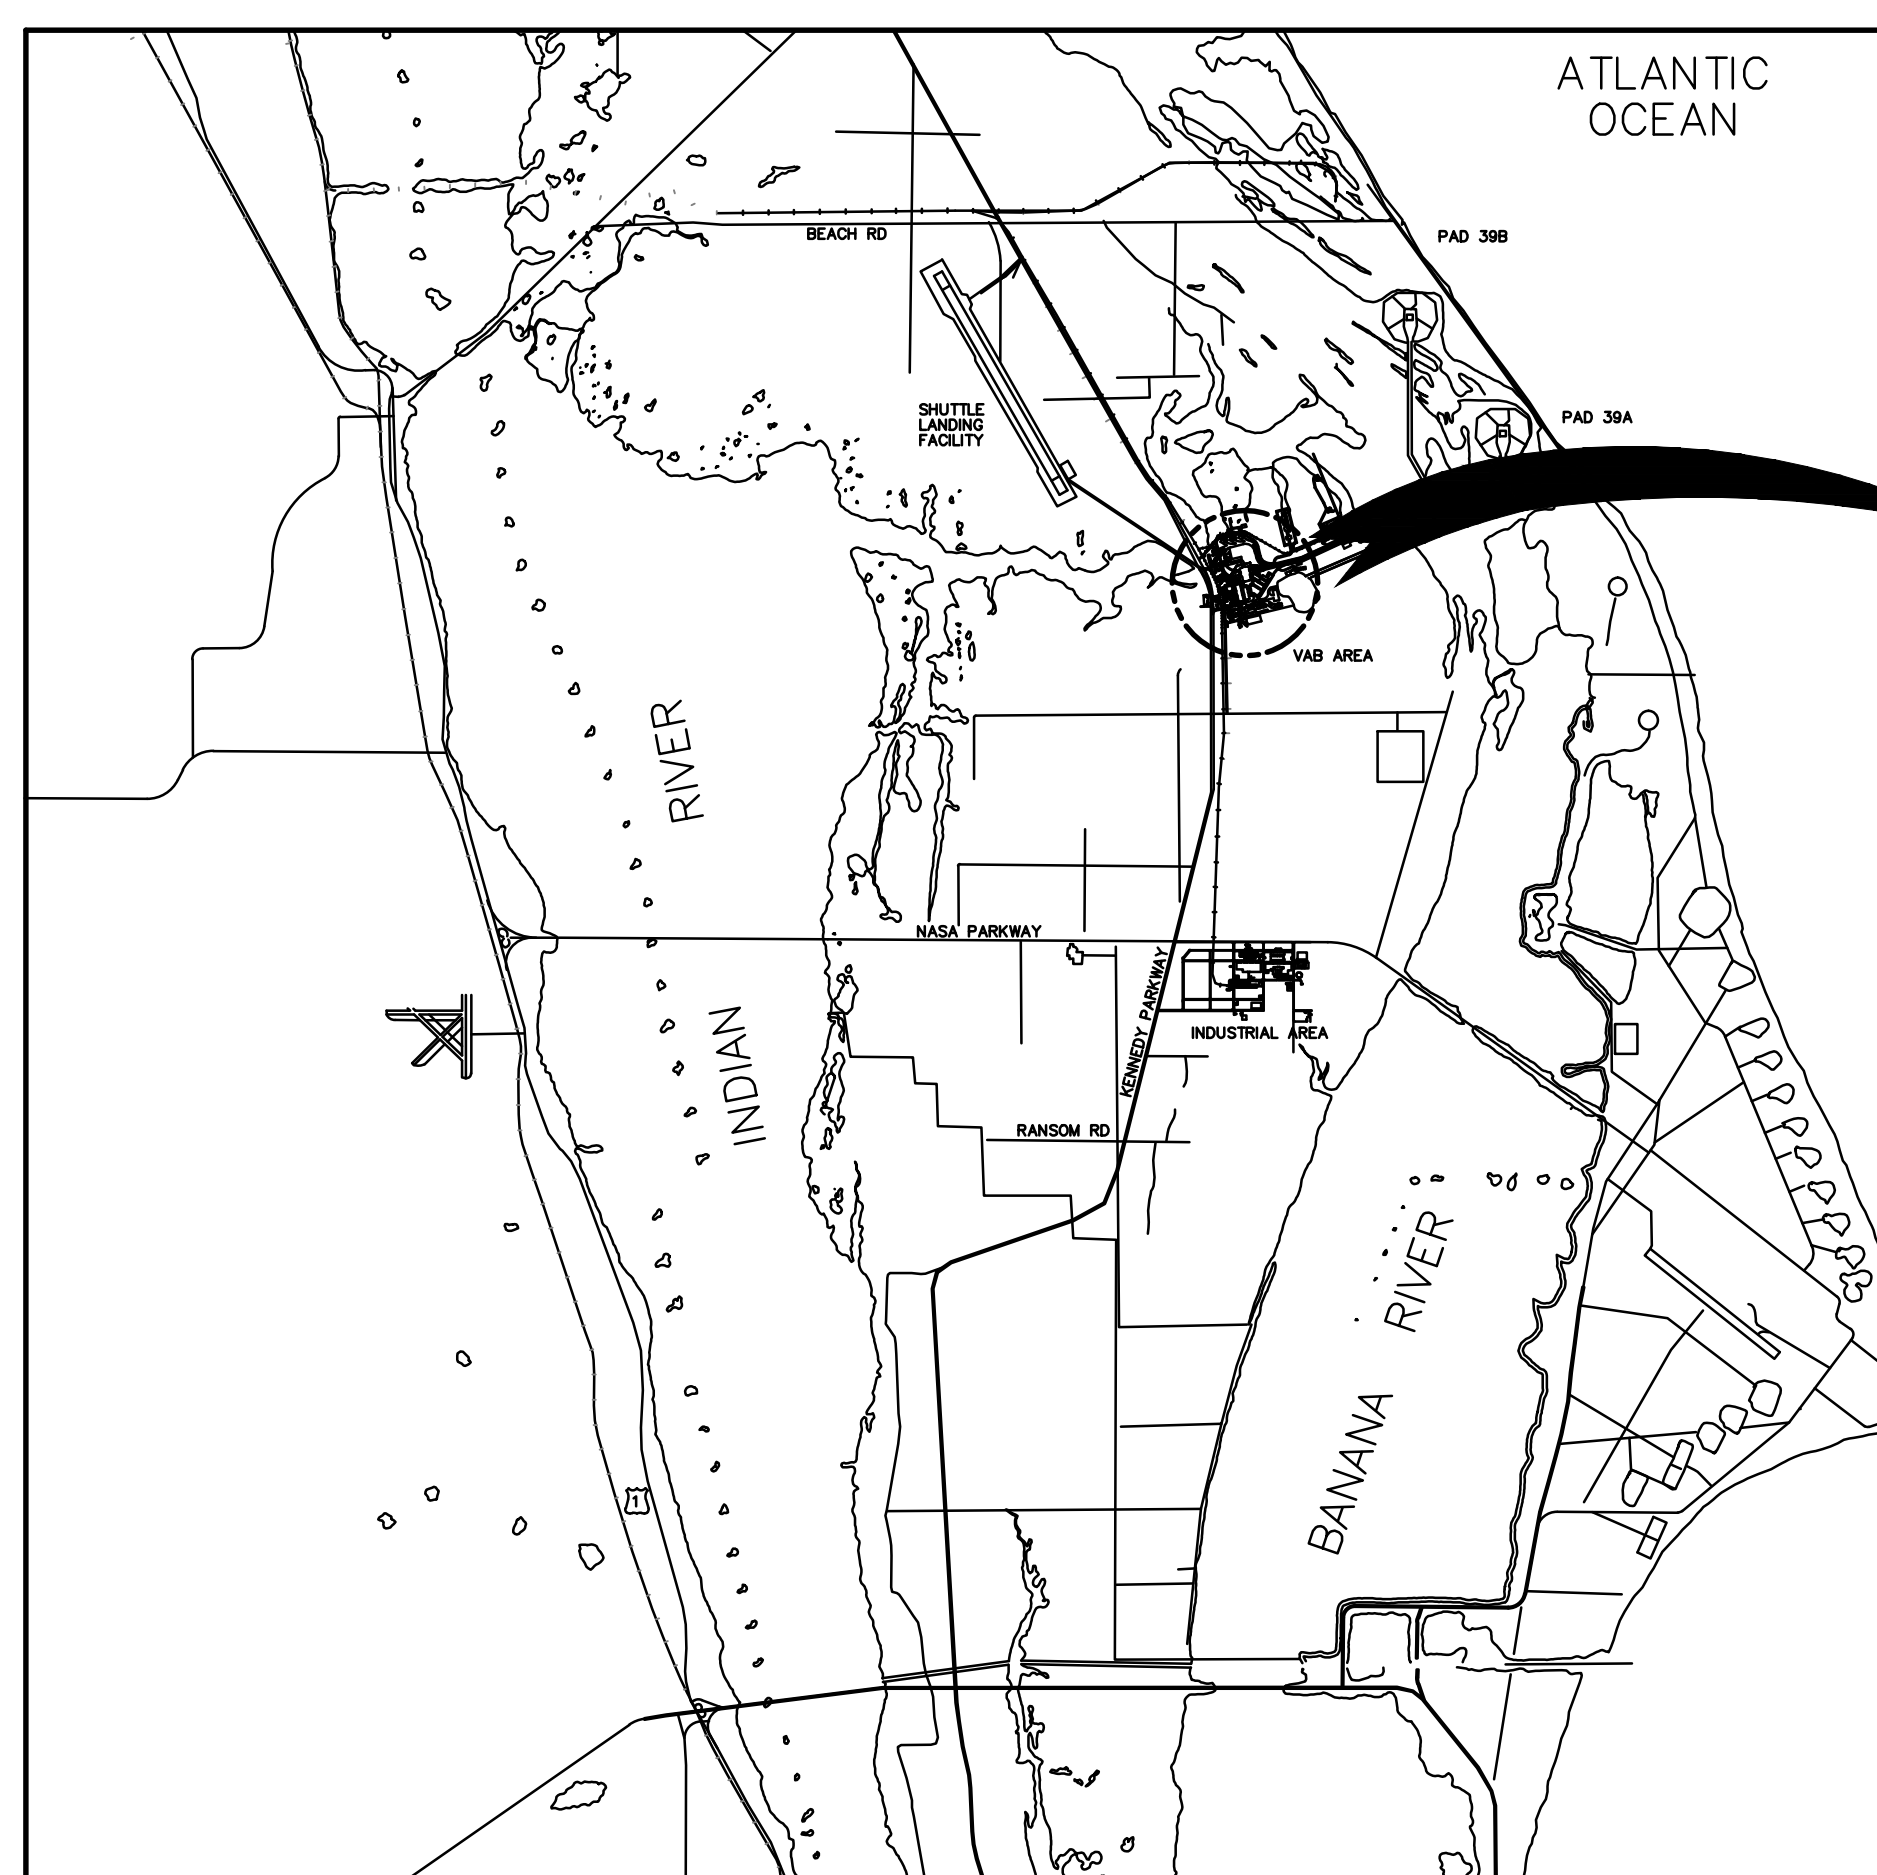



LAUNCH COMPLEX 39
VEHICLE ASSEMBLY BUILDING
MODIFY VEHICLE ASSEMBLY BUILDING
HIGH BAY 3 FOR SLS - HOISTS

NATIONAL AERONAUTICS AND
SPACE ADMINISTRATION

John F. Kennedy Space Center
Kennedy Space Center, Florida 32899

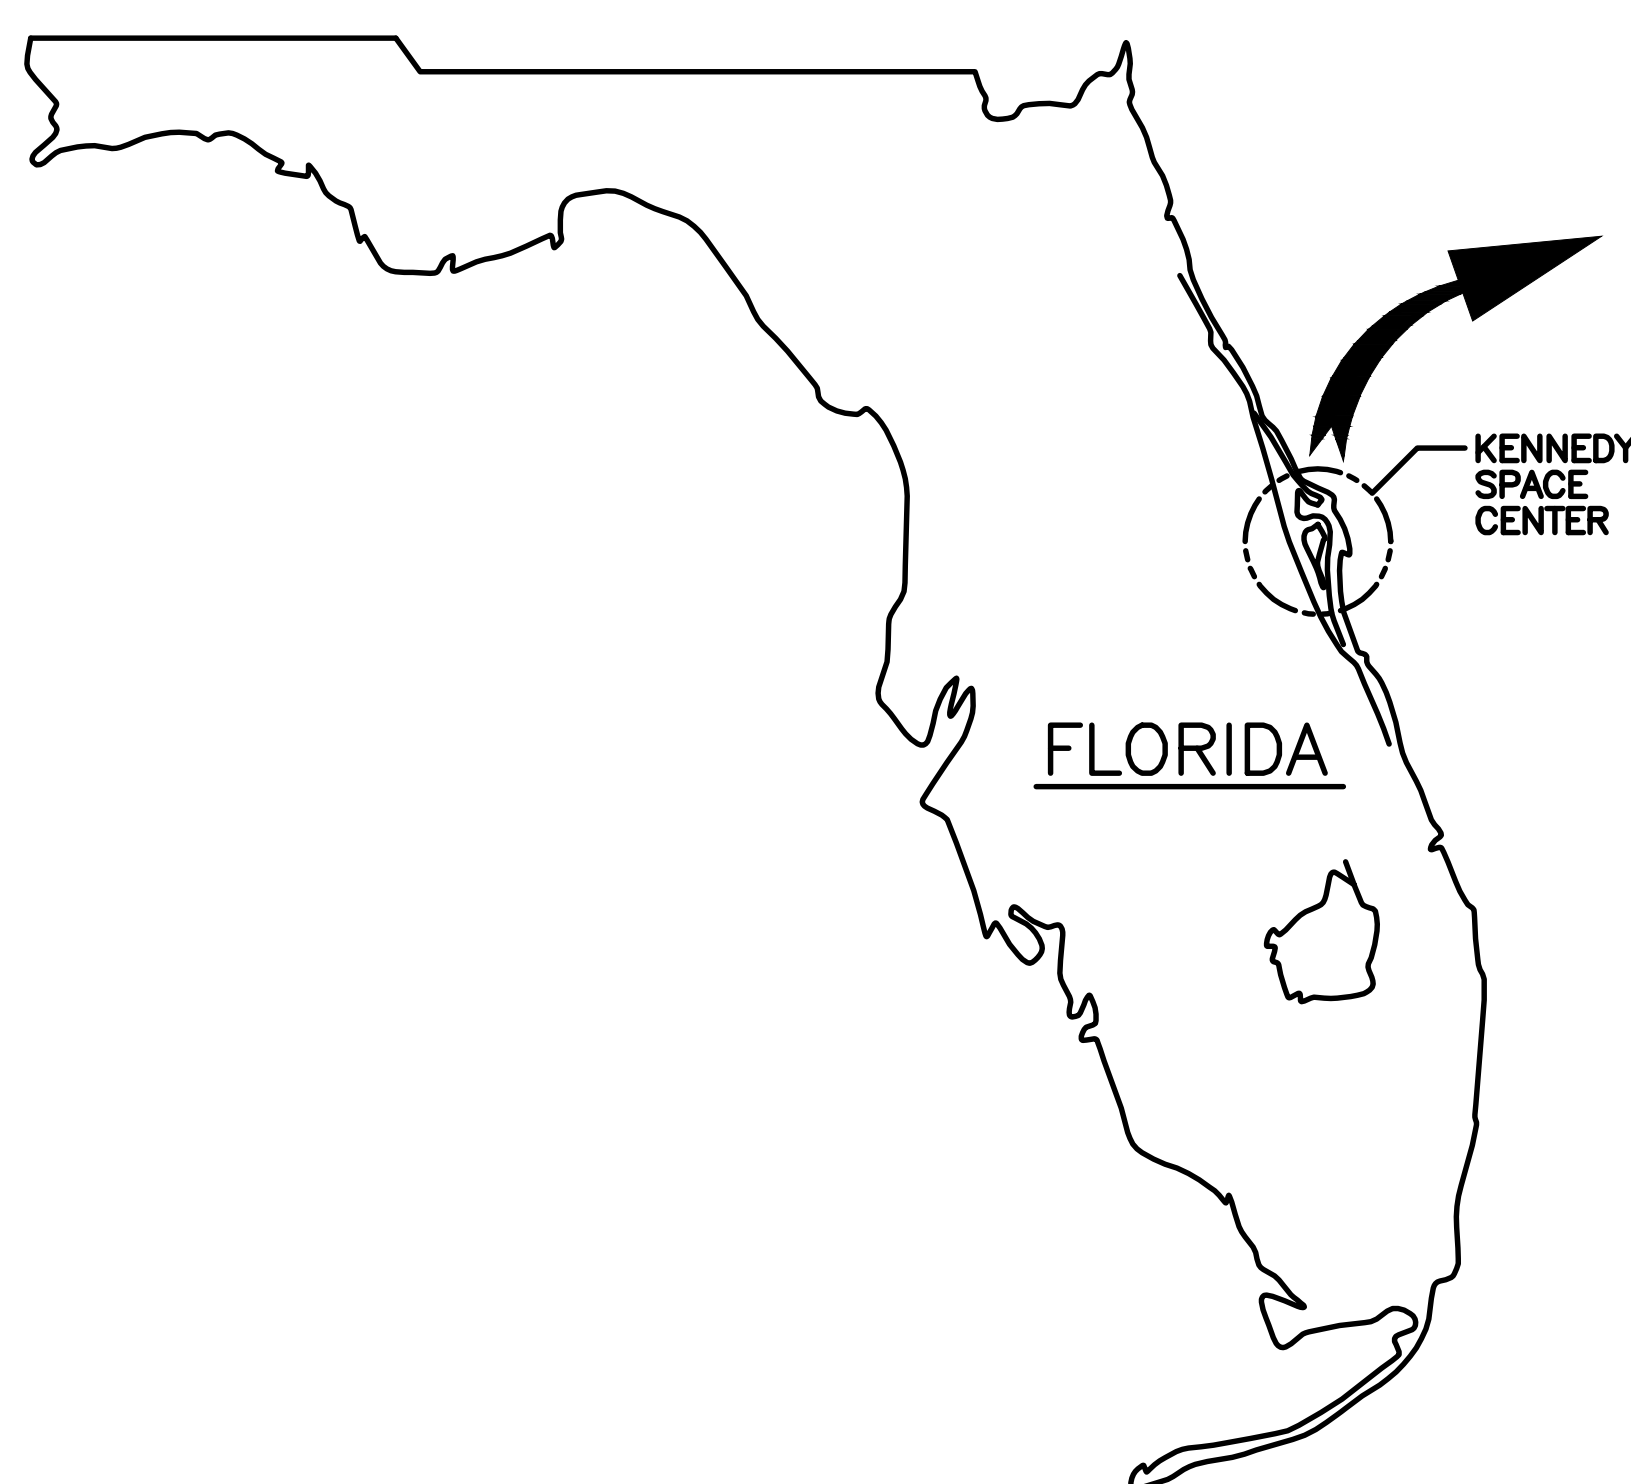


AREA MAP
 NO SCALE

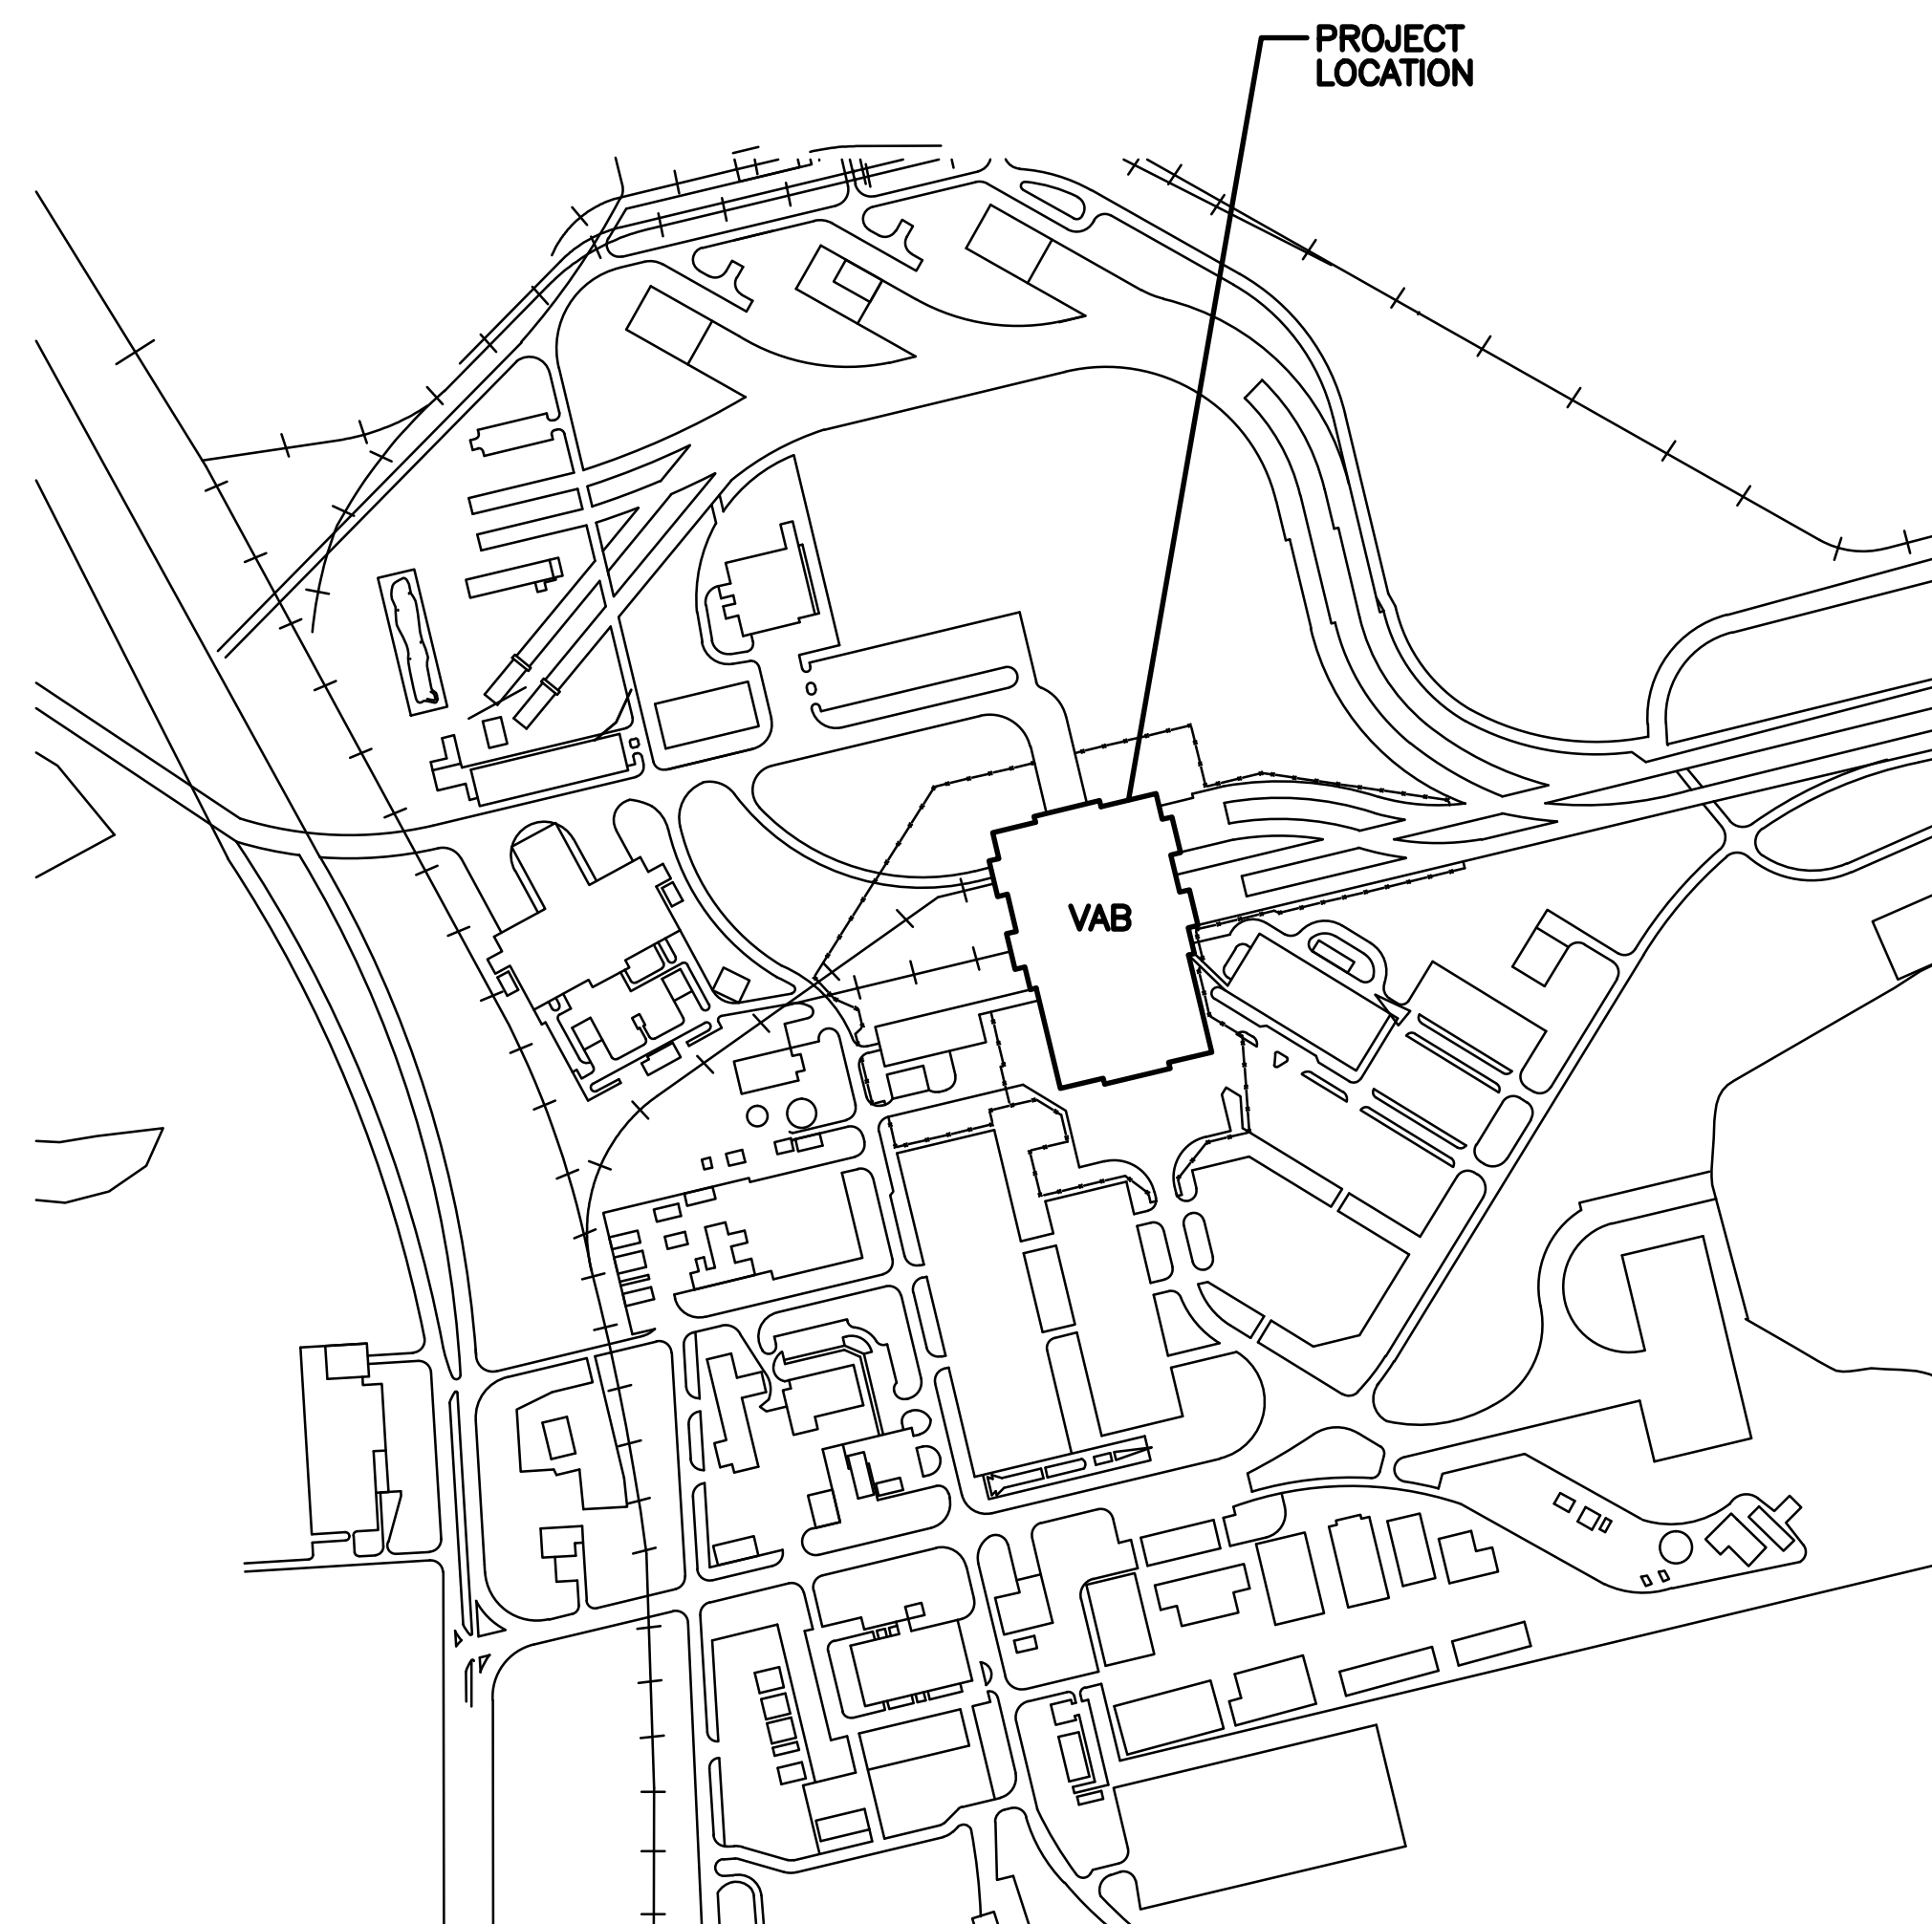

 **LOCATION MAP**
NO SCALE

TECHNICAL SPECIFICATION No. 79K39668


DATA MANUAL: KSC-TA-12243

DATE: AUGUST 20, 2013

<div style="border: 1px solid black; padding: 10px; text-align: center;"> <h3>ASBESTOS IDENTIFIED</h3> </div>	
<input checked="" type="checkbox"/> YES	<input type="checkbox"/> NO
<p>IF THE CONTRACTOR SUSPECTS THE PRESENCE OF ANY ASBESTOS CONTAMINATED MATERIAL NOT IDENTIFIED ON THESE DRAWINGS, BUT IS REQUIRED TO BE DISTURBED TO PERFORM THE CONTRACT WORK, INFORM THE CONTRACTING OFFICER AT ONCE.</p>	

<div style="border: 1px solid black; padding: 10px; text-align: center;"> <h3>HEAVY METALS IDENTIFIED</h3> </div>	
<input checked="" type="checkbox"/> YES	<input type="checkbox"/> NO
<p>IF THE CONTRACTOR SUSPECTS THE PRESENCE OF ANY HEAVY METAL COATING MATERIAL NOT IDENTIFIED ON THESE DRAWINGS, BUT IS REQUIRED TO BE DISTURBED TO PERFORM THE CONTRACT WORK, INFORM THE CONTRACTING OFFICER AT ONCE.</p>	

DOCUMENT INFORMATION: (TITLE, NUMBER, REV. DATE)																
<div style="text-align: center; font-weight: bold; font-size: 1.2em;">MODIFY VEHICLE ASSEMBLY BUILDING HIGH BAY 3 FOR SLS – HOISTS, PCN 9000.5, REV BASIC, AUGUST 20, 2013</div>																
Sensitive But Unclassified (SBU) INSTRUCTIONS: This item must be reviewed under the requirements for "Sensitive But Unclassified Information" as described in NPR 1600.1, Chapter 5.																
http://hrods-dms.gsfc.nasa.gov/																
Document contains SBU?	Yes	No	SBU Reviewer's signature	Date												
	<input type="checkbox"/>	<input checked="" type="checkbox"/>		Company / Org												
Export Control (EC) Instructions: Attach the document requiring an export determination. Contact the KSC ECO Help Desk (867-92009) for help in completing this form.																
http://exportcontrol.ksc.nasa.gov/																
Contractor EC Reviewer's Name and Organization			Contractor EC Reviewer's signature													
NASA ECO Reviewer's Name and Organization			NASA ECO Reviewer's signature													
<table border="1" style="width: 100%; border-collapse: collapse;"> <thead> <tr> <th style="width: 15%;"></th> <th style="width: 15%;">EXPORT DETERMINATION (Check one box only)</th> <th style="width: 70%;"></th> </tr> </thead> <tbody> <tr> <td style="text-align: center; vertical-align: top; padding: 5px;">EAR 99</td> <td style="text-align: center; vertical-align: top; padding: 5px;"><input type="checkbox"/> NLR</td> <td style="padding: 5px;"> <p>The information contained in the document is technical in nature, is not technical data as defined by the FAR or by EAR, and therefore is EAR 99 NLR (no export license required). [General Prohibition Six (EIS) applies to all items subject to the FAR, items on the CCL and by EAR 99 NLR.] You may not release an export or re-export control to the provisions of part 768 (Embargoes and Other Special Controls) of the EAR and EC CFR part 125.1 of the ITAR.]</p> </td> </tr> <tr> <td style="text-align: center; vertical-align: top; padding: 5px;">EAR Controlled</td> <td style="text-align: center; vertical-align: top; padding: 5px;"><input type="checkbox"/></td> <td style="padding: 5px;"> <p>This document is within the purview of the Export Administration Regulations (EAR), 15 CFR 730-774, and is export controlled. It may not be transferred to foreign nationals in the U.S. or abroad without specific approval of a knowledgeable NASA export control official and/or an export license or license exception is obtainable from the Bureau of Industry and Security, United States Department of Commerce. Violations of these regulations are punishable by fine, imprisonment, or both.</p> </td> </tr> <tr> <td style="text-align: center; vertical-align: top; padding: 5px;">ITAR Controlled</td> <td style="text-align: center; vertical-align: top; padding: 5px;"><input type="checkbox"/></td> <td style="padding: 5px;"> <p>This document contains information which falls under the purview of the U.S. Munitions List (USML), as defined in the International Traffic in Arms Regulations (ITAR), 22 CFR 120-130, and is export controlled. It shall not be transferred to foreign nationals in the U.S. or abroad, without specific approval of a knowledgeable NASA export control official, and/or an export license or license exemption is obtainable from the United States Department of State. Violations of these regulations are punishable by fine, imprisonment, or both.</p> </td> </tr> </tbody> </table>						EXPORT DETERMINATION (Check one box only)		EAR 99	<input type="checkbox"/> NLR	<p>The information contained in the document is technical in nature, is not technical data as defined by the FAR or by EAR, and therefore is EAR 99 NLR (no export license required). [General Prohibition Six (EIS) applies to all items subject to the FAR, items on the CCL and by EAR 99 NLR.] You may not release an export or re-export control to the provisions of part 768 (Embargoes and Other Special Controls) of the EAR and EC CFR part 125.1 of the ITAR.]</p>	EAR Controlled	<input type="checkbox"/>	<p>This document is within the purview of the Export Administration Regulations (EAR), 15 CFR 730-774, and is export controlled. It may not be transferred to foreign nationals in the U.S. or abroad without specific approval of a knowledgeable NASA export control official and/or an export license or license exception is obtainable from the Bureau of Industry and Security, United States Department of Commerce. Violations of these regulations are punishable by fine, imprisonment, or both.</p>	ITAR Controlled	<input type="checkbox"/>	<p>This document contains information which falls under the purview of the U.S. Munitions List (USML), as defined in the International Traffic in Arms Regulations (ITAR), 22 CFR 120-130, and is export controlled. It shall not be transferred to foreign nationals in the U.S. or abroad, without specific approval of a knowledgeable NASA export control official, and/or an export license or license exemption is obtainable from the United States Department of State. Violations of these regulations are punishable by fine, imprisonment, or both.</p>
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<div style="text-align: center;">  </div>			Reynolds, Smith and Hills, Inc. 115 Alma Blvd, Suite 101 Merritt Island, Florida 32953-4101 (321) 459-0212 / (321) 459-0223 FAX www.rshand.com	
			NATIONAL AERONAUTICS AND SPACE ADMINISTRATION JOHN F. KENNEDY SPACE CENTER, NASA KENNEDY SPACE CENTER, FLORIDA	
			LAUNCH COMPLEX 39 VEHICLE ASSEMBLY BUILDING MODIFY VEHICLE ASSEMBLY BUILDING HIGH BAY 3 FOR SLS - HOISTS	
			COVER SHEET	
			FILE NO. 302-6058-043 SIZE DWG. NO. 79K39667 REV	
SIGNATURES	DATE			
DRAWN: JOSEPH HAUER	08-19-2013			
CHECKED: RICHARD PRUSS	08-19-2013			
SUBMITTED:				
ROBERT PRUSS				
APPROVED:				
JOHN KERCSMAR				
SONIA MILLER				
WALLACE SCHROEDER				
1		PROJ. NO. PCN 99000.5	SHEET 1 OF 43	

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FILED UNDER THE DRAWING NUMBER

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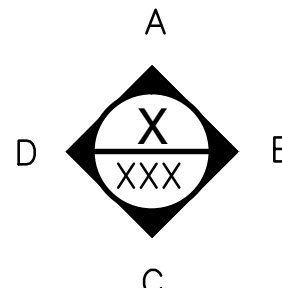







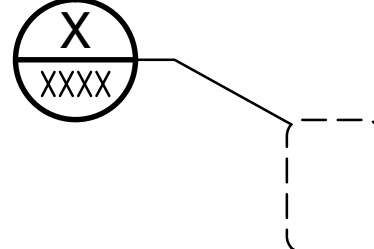
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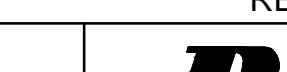
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SHEET NUMBER	FUNCTION CODE	REVISION STATUS	SHEET TITLE
			GENERAL
1	V-001		COVER SHEET
2	V-002		DRAWING INDEX, GENERAL SYMBOLS AND ABBREVIATIONS
3	V-003		WORK LAYDOWN LOCATIONS
			ENVIRONMENTAL
4	EN-001		METALS AND PCB SCHEDULES AND NOTES
			ARCHITECTURAL
5	A-001		ARCHITECTURAL ABBREVIATIONS, SYMBOLS AND GENERAL NOTES
6	AD-136		LEVEL 36 – DEMOLITION PLAN
7	A-135		LEVEL 35 PLAN
8	A-136		LEVEL 36 PLAN
9	A-500		ENLARGED PLATFORM PLANS, LEVEL 35
10	A-501		ENLARGED PLATFORM PLANS, LEVEL 36
11	A-502		GUARDRAIL ELEVATIONS AND DETAILS
12	A-503		GUARDRAIL ELEVATIONS AND DETAILS
13	A-504		GUARDRAIL ELEVATIONS
14	A-505		LADDER DETAILS
15	A-506		SECURITY FENCE PLAN LEVELS 32 AND 34
			STRUCTURAL
16	S-001		STRUCTURAL GENERAL NOTES
17	S-135		PLAN LEVEL 35
18	S-136		PLAN LEVEL 36
19	S-137		PLAN LEVEL 37
20	S-401		ENLARGED FRAMING PLAN LEVEL 35
21	S-402		ENLARGED FRAMING PLAN AND ELEVATIONS LEVEL 36
22	S-501		STRUCTURAL DETAILS – 1
23	S-502		STRUCTURAL DETAILS – 2
24	S-503		REMOVABLE GUARDRAIL BASE DETAIL
			MECHANICAL
25	M-810		ELEVATOR LANDINGS HOISTS AT FLOOR LEVEL 36 PLAN
26	M-811		EXTENSIBLE PLATFORMS HOISTS AT FLOOR LEVEL 32 PLAN
27	M-812		EXTENSIBLE PLATFORMS HOISTS AT FLOOR LEVEL 34 PLAN
28	M-813		EXTENSIBLE PLATFORMS HOISTS ELEVATION
29	M-814		ELEVATOR LANDINGS HOISTS ELEVATION
30	M-815		EXTENSIBLE PLATFORMS HOISTS SLING SCHEDULE
31	M-816		ELEVATOR PLATFORMS HOISTS SLING SCHEDULE
32	M-817		ELEVATOR PLATFORMS HOIST HOIST CART
			ELECTRICAL
33	E-001		ELECTRICAL GENERAL NOTES, LEGEND AND ABBREVIATIONS
34	ED-136		LEVEL 36 – ELECTRICAL DEMOLITION PLANS
35	E-132		LEVEL 32 – ELECTRICAL PLAN
36	E-134		LEVEL 34 – ELECTRICAL PLAN
37	E-135		LEVEL 35 – ELECTRICAL PLAN
38	E-136		LEVEL 36 – ELECTRICAL PLAN
39	E-580		ELECTRICAL DETAILS
40	E-600		POWER ONE-LINE – DIAGRAM 1
41	E-601		POWER ONE-LINE – DIAGRAM 2
42	E-602		ELECTRICAL SCHEDULES
43	E-641		HOIST CONTROLLER ELEVATION AND BLOCK DIAGRAM

ABBREVIATIONS

A	AT
AC	AMPERES
ACI	ALTERNATING CURRENT
AISC	AMERICAN CONCRETE INSTITUTE
ASCE	AMERICAN INSTITUTE OF STEEL CONSTRUCTION
ASD	ALLOWABLE STRENGTH DESIGN
ASTM	AMERICAN SOCIETY for TESTING and MATERIALS
CJP	COMPLETE JOINT PENETRATION
CONC	COLUMN
CONC	CONCRETE
DIA	DIAMETER
EL	ELEVATION
EQ	EQUAL
F	FAHRENHEIT
FAC	FACTORY
FL	FLOOR
FT	FOOT
HDG	HOT DIP GALVANIZED
HMD	HOMOGENEOUS MATERIAL DESCRIPTION
HMP	HOMOGENEOUS MATERIAL PAINT
HP	HORSEPOWER
HSS	HOLLOW STRUCTURAL SQUARE AND RECTANGULAR SECTIONS
HT	HEIGHT
KG	KILOGRAM
LB	POUND
LBS	POUNDS
MAX	MAXIMUM
MG	MILLIGRAM
MM	MILLIMETER
MIN	MINIMUM
NEC	NATIONAL ELECTRIC CODE
NEMA	NATIONAL ELECTRICAL MANUFACTURERS ASSOCIATION
NFPA	NATIONAL FIRE PROTECTION ASSOCIATION
NIC	NOT IN CONTRACT
NO	NUMBER
NTS	NOT TO SCALE
OAE	OR APPROVED EQUAL
OC	ON CENTER
OPP	OPPOSITE
OSHA	OCCUPATIONAL SAFETY AND HEALTH ADMINISTRATION
PCB	POLYCHLORINATED BIPHENOLS
PH	PHASE
PL	PLATE
P/N	PART NUMBER
QTY	QUANTITY
REF	REFERENCE
RGC	RIGID GALVANIZED CONDUIT
RPM	REVOLUTIONS PER MINUTE
SCH	SCHEDULE
SIM	SIMILAR
SLS	SPACE LAUNCH SYSTEM
SP	SPACES
SS	STAINLESS STEEL
SYMM	SYMMETRIC
TOS	TOP OF STEEL
TYP	TYPICAL
UG	MICROGRAM
UON	UNLESS OTHERWISE NOTED
V	VOLT
VAB	VEHICLE ASSEMBLY BUILDING
VAC	VOLTS, AC
VIF	VERIFY IN FIELD
VRC	VERTICAL RATED CAPACITY
W	WATT
WD	WIDTH
W/	WITH
WP	WORK POINT
WP	WOOD POST
"	INCH(ES)
'	FOOT(FEET)

DRAWING SYMBOLS

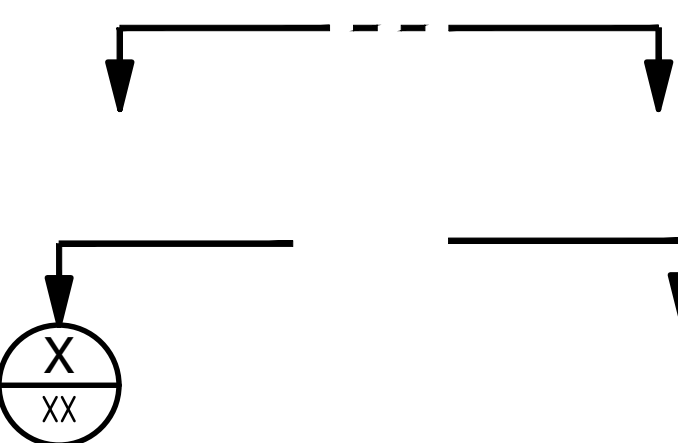XXX	ROOM DESIGNATION	MIP - XXX	MANDATORY INSPECTION POINT
	ELEVATION INDICATOR	ø	DIAMETER
	VIEW DIRECTION INDICATOR		FLAG NOTE INDICATOR
	SECTION CUT		ITEM INDICATOR
C	CENTER LINE	REVISION INDICATOR	
	NORTH ARROW		
<u>DRAWING TITLE</u>			
SCALE: NTS	SECTION OR DETAIL LETTER		
<u>HOSE CARRIER SECTION</u>		SHEET WHERE TAKEN OR CUT	
SCALE: NTS		DOOR SYMBOL	
	REFERENCE SYMBOL		

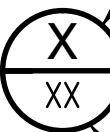SYM	ZONE	DESCRIPTION	DATE	APPROVAL
REVISONS				
		 <div style="float: right; text-align: right;"> Reynolds, Smith and Hills, Inc. 115 Alma Blvd. Suite 511 Merritt Island, Florida 32953-4101 (321) 425-0212 (321) 425-0223 FAX www.rsandh.com </div>		
SIGNATURES		DATE	NATIONAL AERONAUTICS AND SPACE ADMINISTRATION	
DRAWN:	BRIAN CURTIS	08-20-2013	JOHN F. KENNEDY SPACE CENTER, NASA KENNEDY SPACE CENTER, FLORIDA	
CHECKED:	TONY MAZZA	08-20-2013	LAUNCH COMPLEX 39 VEHICLE ASSEMBLY BUILDING	
SUBMITTED: ARCHIVING OF RECORD			MODIFY VEHICLE ASSEMBLY BUILDING	
ROBERT PRUSS			HIGH BAY 3 FOR SLS - HOISTS	
ST. OF LICENSURE: FL			DRAWING INDEX, GENERAL	
LICENSE NO:			SYMBOLS AND ABBREVIATIONS	
APPROVED:				
JOHN KERSCMAR			FILE NO. 302-6058-043	SIZE E
			DWG. NO. 79K39667	REV
MIKE HARTNETT			PROD. NO. PCN 99000.5	SHEET 2 OF

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V-002

HEAVY METALS AND PCBS

- | | | | | | | | |
|--------|-------------------|--|----------------------------------|------|----------|-------|------|
| X44" | ROBERT BRUSS | | MODIFY VEHICLE ASSEMBLY BUILDING | | | | |
| | ST OF LICENSE: FL | | HIGH BAY 3 FOR SLS - HOISTS | | | | |
| | LICENSE NO: | | METALS AND PCB | | | | |
| | APPROVED: | | SCHEDULES AND NOTES | | | | |
| | JOHN KERCSMAR | | FILE NO. | SIZE | DWG. NO. | | REV |
| | | | 302-6058-043 | E | 79K39667 | | |
| EN-001 | MIKE HARTNETT | | PROJ. NO. | PCN | 99900.5 | SHEET | 4 OF |

Hoist Package

HMP03	Vertical Beam Coatings	White Paint Gray Paint White/Gray Paint Layers	M3718, M3749, M3769, M3781	Yes	Yes	<96	<96	150	210	6.4	1,500	920	<96	<19	4,200
HMP04	Horizontal Beam Coatings	Gray Paint	M3735, M3748, M3754, M3772, M3773	Yes	Yes	<99	160	180	400	870	2,000	8,900	<99	<20	5,800
HMP05	Cross Beam Coating	Gray Paint	M3722, M3725, M3744, M3759, M3770	Yes	Yes	<100	350	320	450	1.9	1,500	660	<100	<20	4,500

Heavy Metals/Polychlorinated Byphenols detected at concentrations above their respective Method Detection Limits are highlighted and in **Bold**.

Sample collection dates: February 14, 2013 and March 27, 2013



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ARCHITECTURAL SYMBOLS LEGEND

(XX) NEW DOOR, NUMBER

 DENOTES STEEL MATERIAL IN SECTION

VIF VERIFY IN FIELD

 NEW DOOR OR GATE

^


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FAC FACTORY

GENERAL NOTES:

1. REFER TO STRUCTURAL, MECHANICAL AND ELECTRICAL SHEETS FOR ADDITIONAL INFORMATION.
2. DO NOT SCALE DRAWINGS. IF DIMENSIONS ARE IN QUESTION, OBTAIN CLARIFICATION OF AREA IN QUESTION.
3. REFER TO SPECIFICATIONS SECTION 09 97 13.00 98 FOR STEEL COATINGS. QUALITY CONTROL SHALL BE PERFORMED BY AN INDEPENDENT NACE CERTIFIED COATING INSPECTOR LEVEL 3 PROVIDED BY THE GENERAL CONTRACTOR.
4. ISOLATE DISSIMILAR METALS SUCH AS ALUMINUM AND STAINLESS STEEL WITH TEFLON LINER OR TEFLON COATING, DEPENDING ON TYPE OF ASSEMBLY.

SIGNAGE

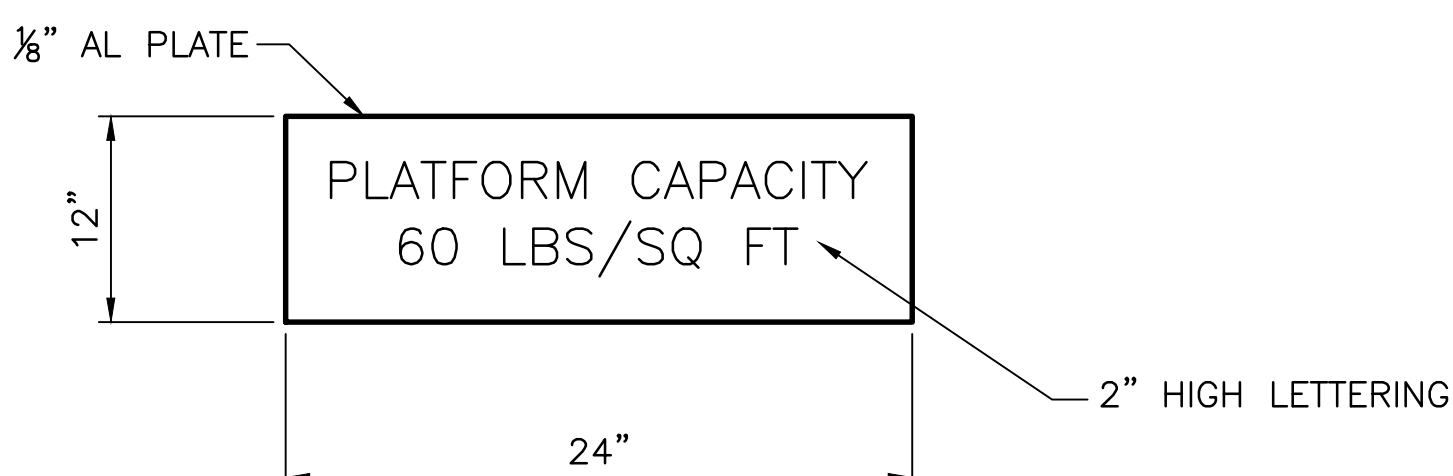

1 SIGNAGE TYPE 1 - SEE A-500 AND A-501 FOR LOCATION

CODE SUMMARY:

VAB HB3 MODIFICATIONS FOR SLS DESIGN

PROJECT SUMMARY

PROJECT SCOPE IS TO INSTALL HOIST SERVICE PLATFORMS IN THE VAB (VEHICLE ASSEMBLY BUILDING). PROJECT SCOPE ALSO INCLUDES INSTALLING HOISTS FOR THE EXTENSIBLE PLATFORMS AND INSTALLING HOISTS FOR THE ELEVATOR PLATFORMS.

APPLICABLE CODES

NFPA 101 LIFE SAFETY CODE 2012

OSHA OCCUPATIONAL SAFETY AND HEALTH ADMINISTRATION - DEPARTMENT OF LABOR
STANDARD 29 CFR 1910

CONSTRUCTION TYPE

VAB - VEHICLE ASSEMBLY BUILDING EXISTING TYPE II UNPROTECTED

BUILDING USE CATEGORY

VAB IS CONSIDERED A SPECIAL PURPOSE INDUSTRIAL OCCUPANCY WITH INCIDENTAL HIGH HAZARD OPERATIONS

HANDRAILS AND GUARDRAILS


GUARDRAILS 42" HIGH ARE REQUIRED AT THE OPEN SIDES OF EGRESS AND WALKING AND WORKING SURFACES THAT EXCEED 30" ABOVE THE ADJACENT FLOOR OR GROUND LEVEL

GUARDRAILS

42" IN HEIGHT, PIPE RAILINGS 1 1/2" NOMINAL DIAMETER WITH POSTS SPACED NOT MORE THAN 5'-0" OC

TOE BOARD 4" IN HT. NOT MORE THAN 1/4" CLEARANCE ABOVE FLOOR LEVEL


ALL GUARDRAILS ARE TO HAVE AN INTERMEDIATE RAIL MOUNTED AT THE MID-POINT OF THE HEIGHT OF THE GUARDRAIL PER 29 CFR 1910.23 (e)

SYM	ZONE	DESCRIPTION	DATE	APPROVAL
REVISIONS				
				
		Reynolds, Smith and Hills, Inc. 115 Alma Blvd, Suite 101 Merritt Island, Florida 32953-4101 (321) 453-0110 (321) 453-0223 FAX www.rsandh.com		
SIGNATURES		DATE		
DRAWN: BRIAN CURTIS		08-20-2013		
CHECKED: ALICE SCHULTZ		08-20-2013		
SUBMITTED: ARCHIVE OF RECORD				
ANTHONY MAZZA				
ST OF LICENSURE: FL				
LICENSE NO:				
APPROVED:				
JOHN KERCSMAR				
		NATIONAL AERONAUTICS AND SPACE ADMINISTRATION JOHN F. KENNEDY SPACE CENTER, NASA KENNEDY SPACE CENTER, FLORIDA LAUNCH COMPLEX 39 VEHICLE ASSEMBLY BUILDING MODIFY VEHICLE ASSEMBLY BUILDING HIGH BAY 3 FOR SLS - HOISTS ARCHITECTURAL ABBREVIATIONS, SYMBOLS AND GENERAL NOTES		
		FILE NO.	SIZE	DWG. NO.
		302-6058-043	E	79K39667
MIKE HARTNETT		PROJ. NO.	PCN	99000.5
		SHEET	5	OF

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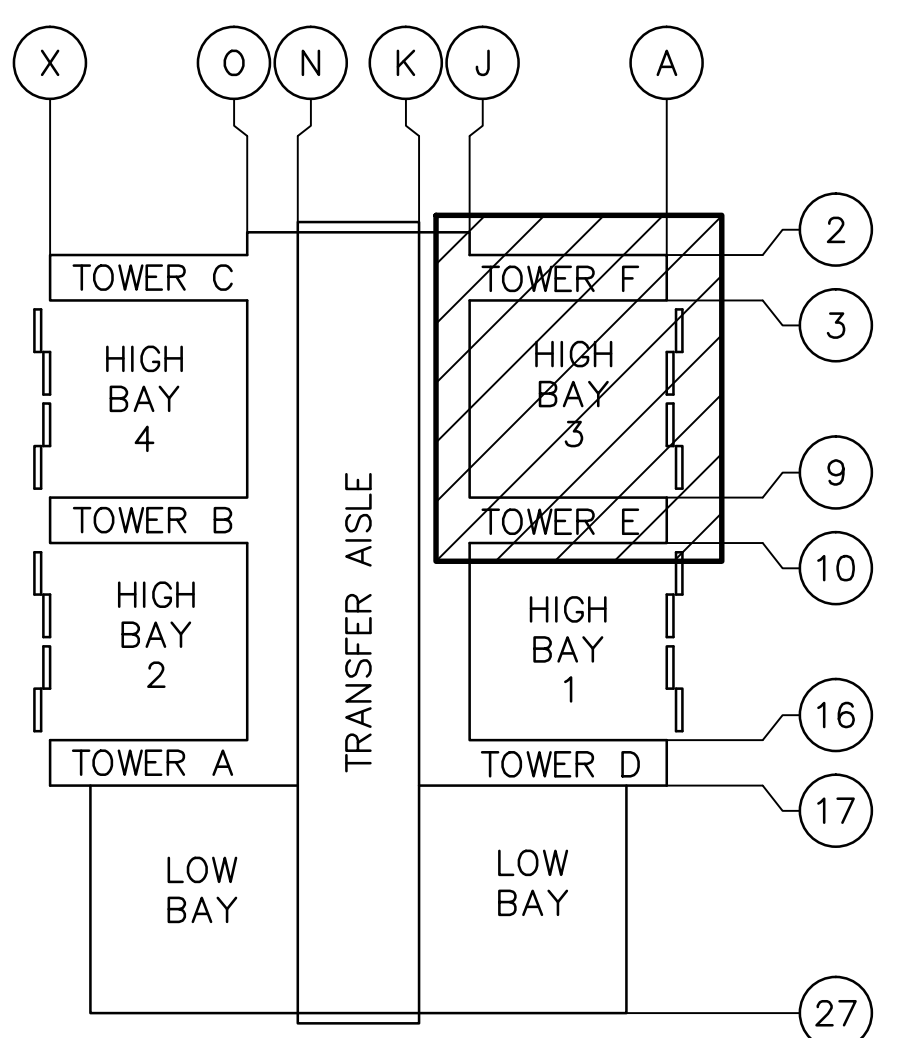
A-001

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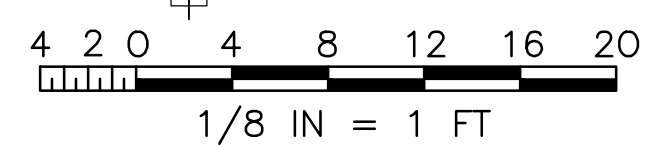
SPECIFIC NOTES:

A REMOVE APPROXIMATELY 4'-0" W x 8'-0" TALL PORTION OF FENCING. ONCE FENCING IS REMOVED INSTALL REMOVABLE GUARDRAIL, SEE SHEET A-501.

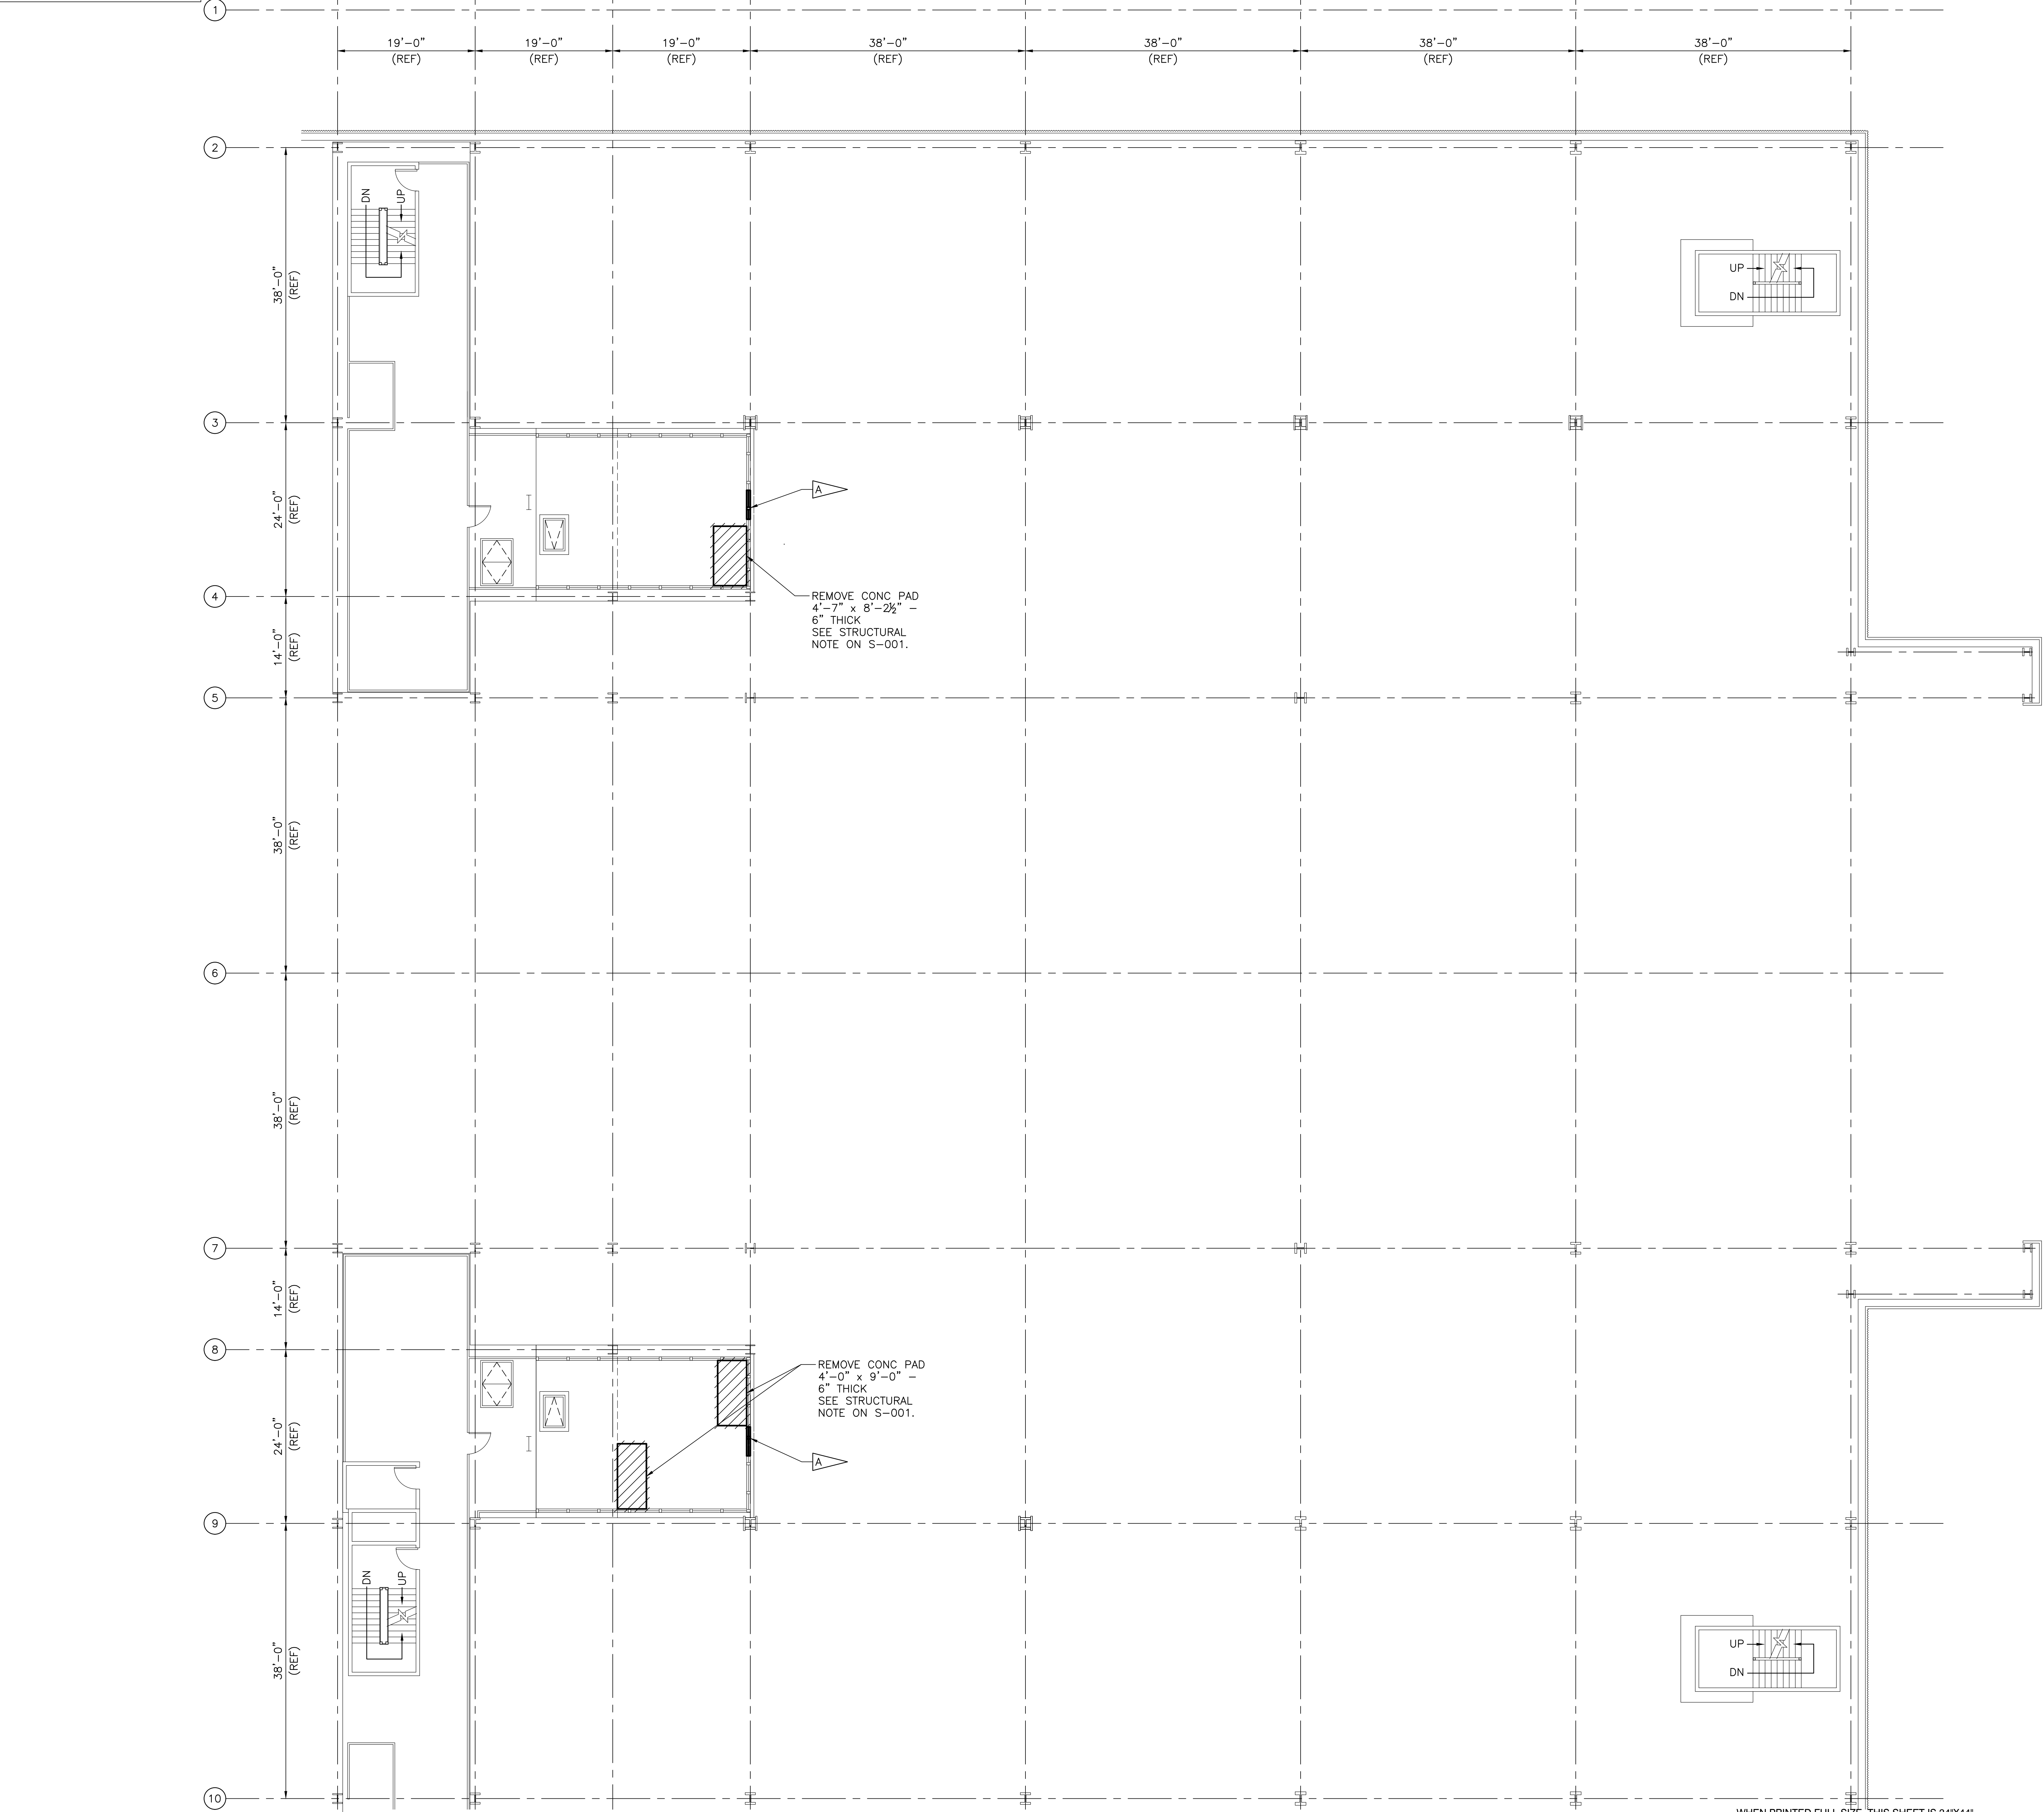

VAB KEY PLAN
SCALE: NTS

FLOOR PLAN
SCALE: 1/8" = 1'-0"





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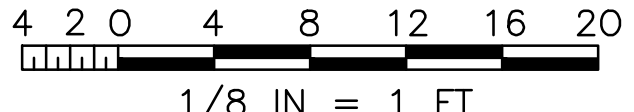
AD-136

SYM	ZONE	DESCRIPTION	DATE	APPROVAL
REVISIONS				
RSH IMPROVING YOUR WORLD				
Reynolds, Smith and Hills, Inc. 115 Alma Blvd, Suite 101 Merritt Island, Florida 32953-4101 (321) 453-0212 (321) 453-0223 FAX www.rsandh.com				
NATIONAL AERONAUTICS AND SPACE ADMINISTRATION JOHN F. KENNEDY SPACE CENTER, NASA KENNEDY SPACE CENTER, FLORIDA				
LAUNCH COMPLEX 39 VEHICLE ASSEMBLY BUILDING MODIFY VEHICLE ASSEMBLY BUILDING HIGH BAY 3 FOR SLS - HOISTS LEVEL 36 - DEMOLITION PLAN				
SIGNATURES		DATE		
DRAWN: BRIAN CURTIS		08-20-2013		
CHECKED: ALICE SCHULTZ		08-20-2013		
SUBMITTED ARCHIVING OF RECORD				
ANTHONY MAZZA				
ST. OF LICENSURE: FL				
LICENSE NO:				
APPROVED:				
JOHN KEROSMAR				
MIKE HARTNETT				
FILE NO:		302-6058-043		REV
SIZE		E		79K39667
PROJ. NO.		PCN 99000.5		SHEET 6 OF

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FLOOR PLAN
SCALE: 1/8" = 1'-0"

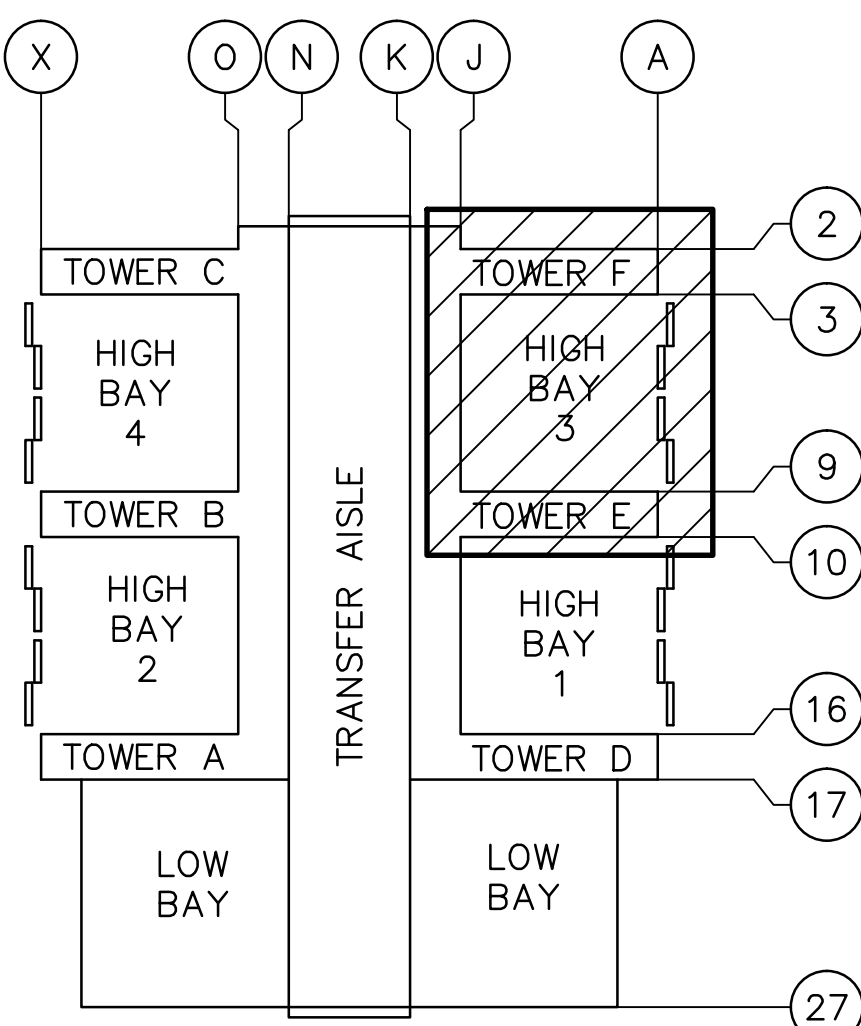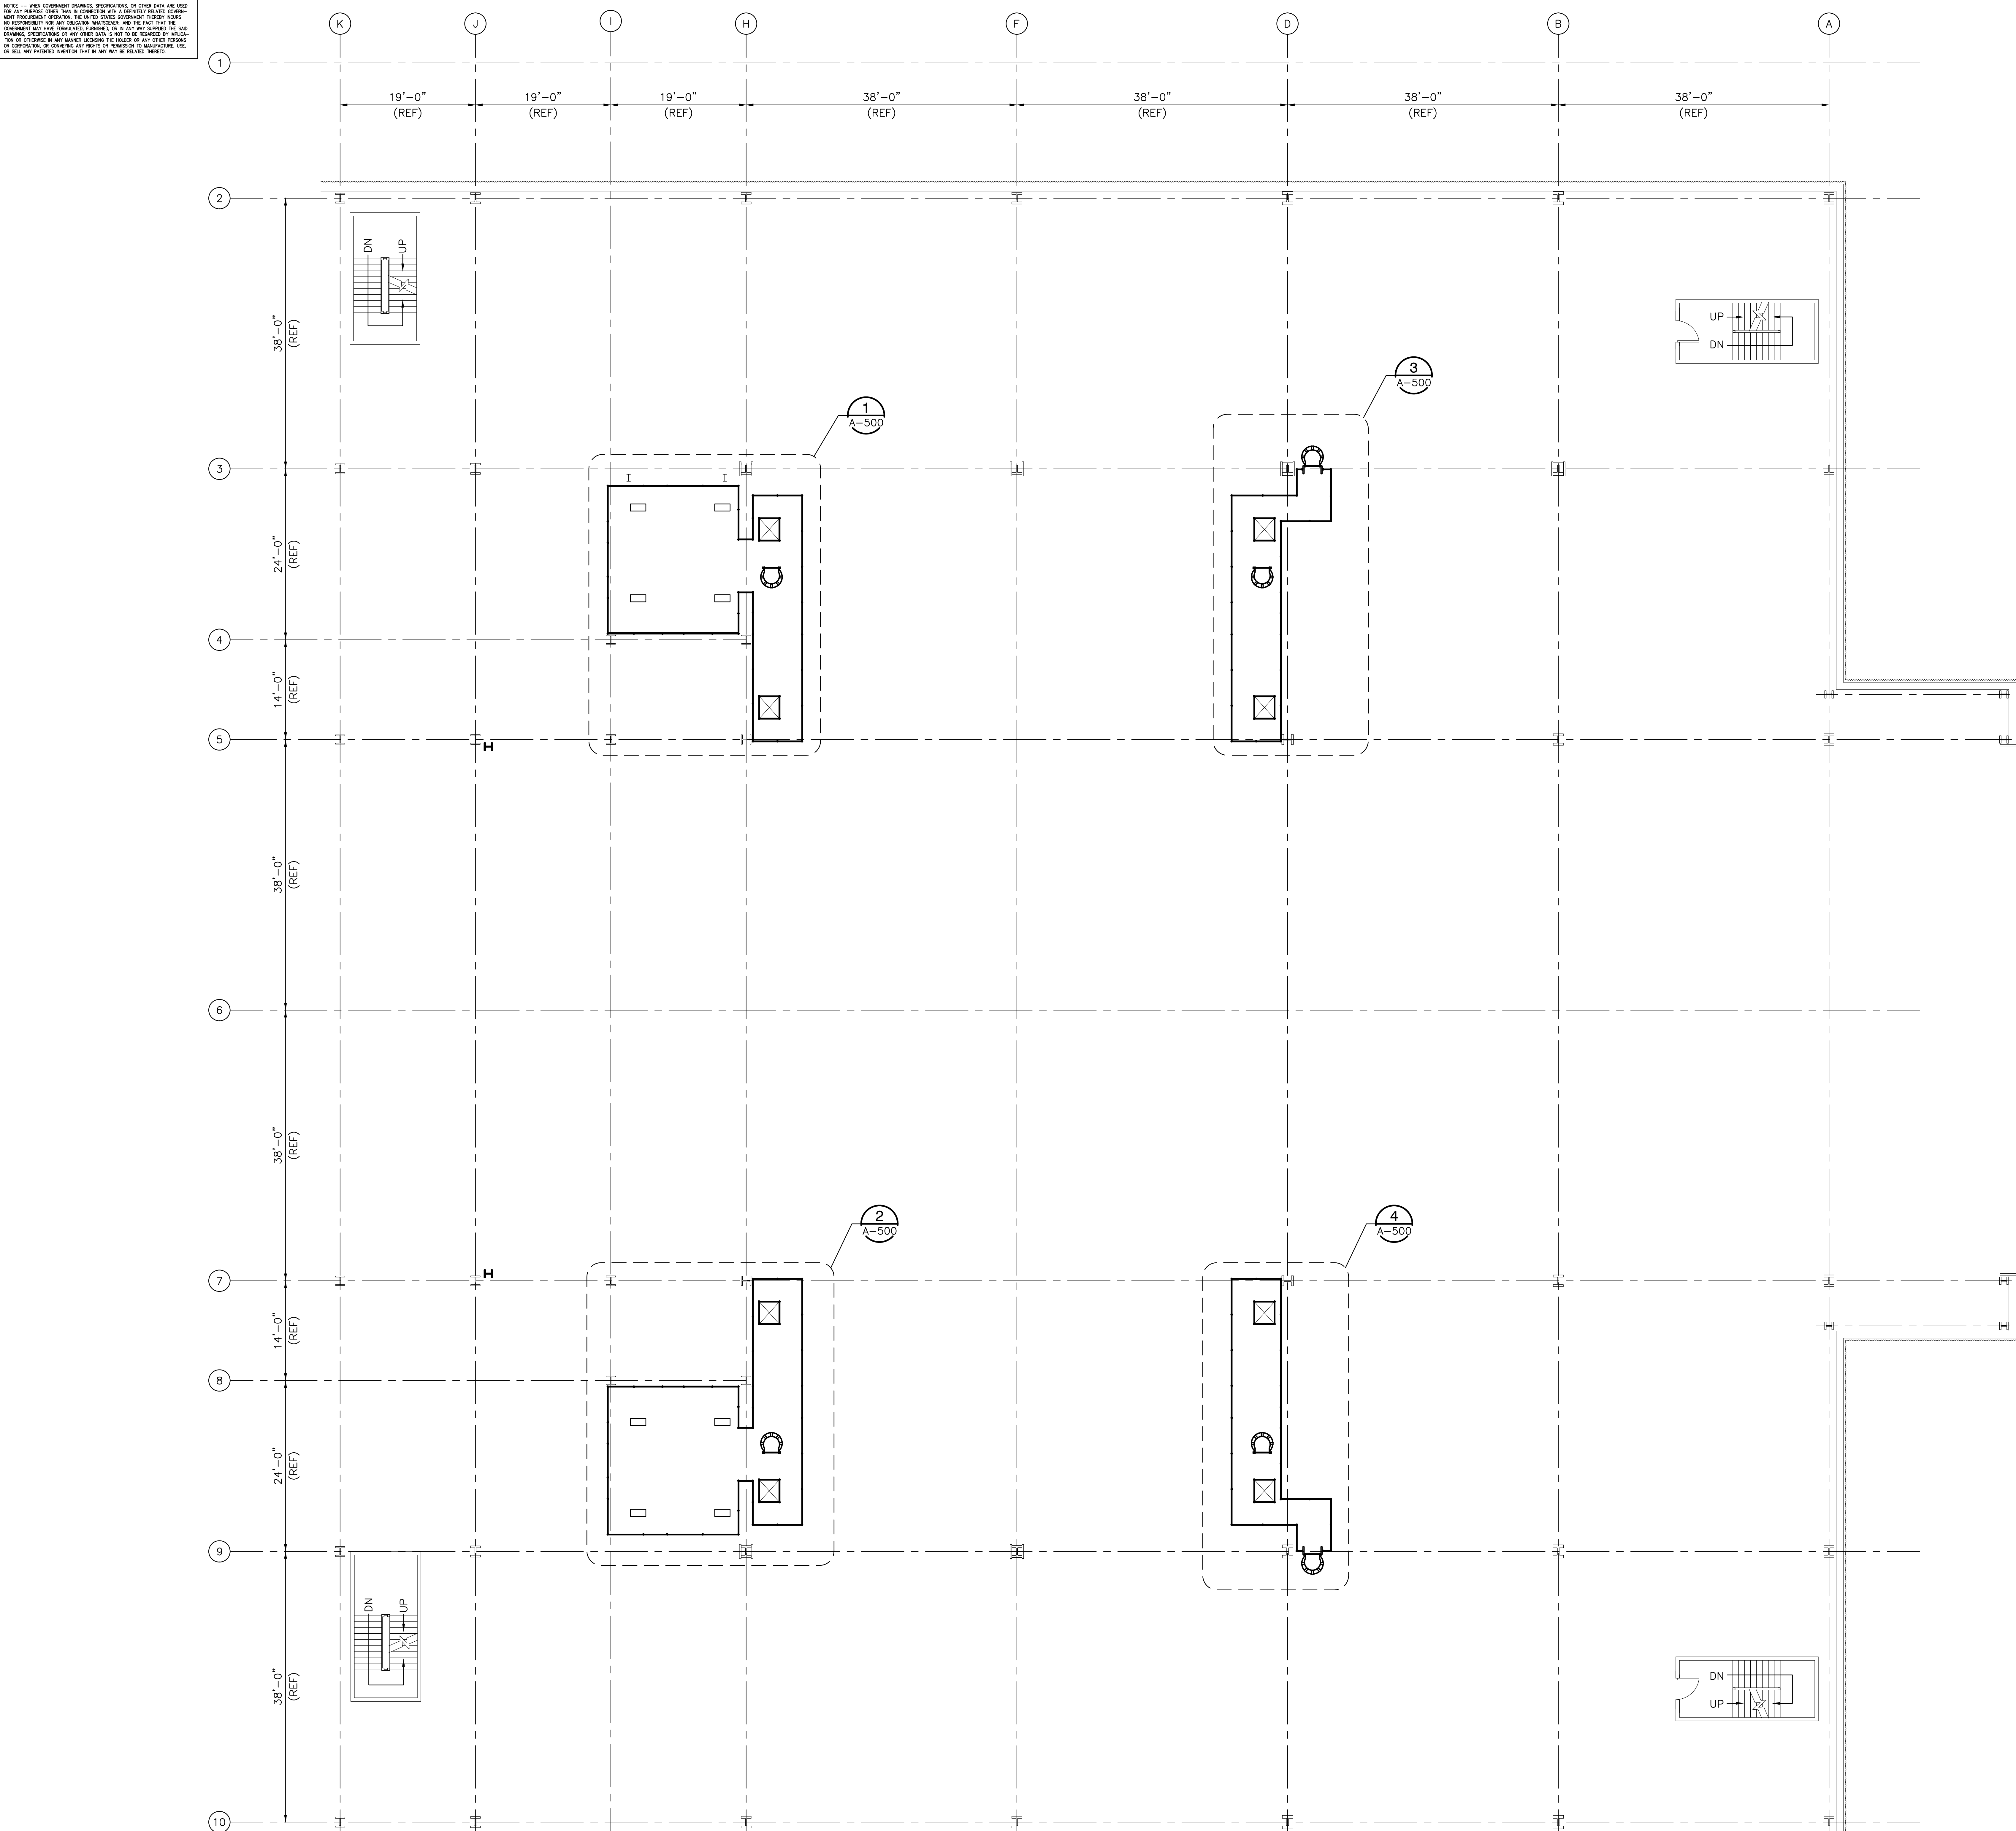


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THIS COMPUTER DRAWING WAS
CREATED IN AUTOCAD AND
FILED UNDER THE DRAWING NUMBER

A-135

SYM	ZONE	DESCRIPTION	DATE	APPROVAL
REVISIONS				
SIGNATURES		DATE	REYNOLDS, SMITH AND HILLS, INC. 115 ALMA BLVD., SUITE 101 MERRITT ISLAND, FLORIDA 32953-4101 (321) 453-0212 (321) 453-0223 FAX WWW.RSANDH.COM	
DRAWN:	BRIAN CURTIS	08-20-2013	NATIONAL AERONAUTICS AND SPACE ADMINISTRATION JOHN F. KENNEDY SPACE CENTER, NASA KENNEDY SPACE CENTER, FLORIDA	
CHECKED:	ALICE SCHULTZ	08-20-2013	LAUNCH COMPLEX 39 VEHICLE ASSEMBLY BUILDING	
SUBMITTED ARCHIVING OF RECORD:	ANTHONY MAZZA		MODIFY VEHICLE ASSEMBLY BUILDING HIGH BAY 3 FOR SLS - HOISTS	
ST. OF LICENSE:	FL		LEVEL 35	
LICENSE NO.:			PLAN	
APPROVED:	JOHN KERSHAW		FILE NO. 302-6058-043	SIZE E
	MIKE HARTNETT		PROJ. NO. PCN 99000.5	99000.5
			SHEET 7	OF 7


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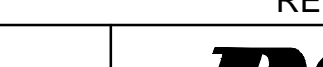
SPECIFIC NOTES:

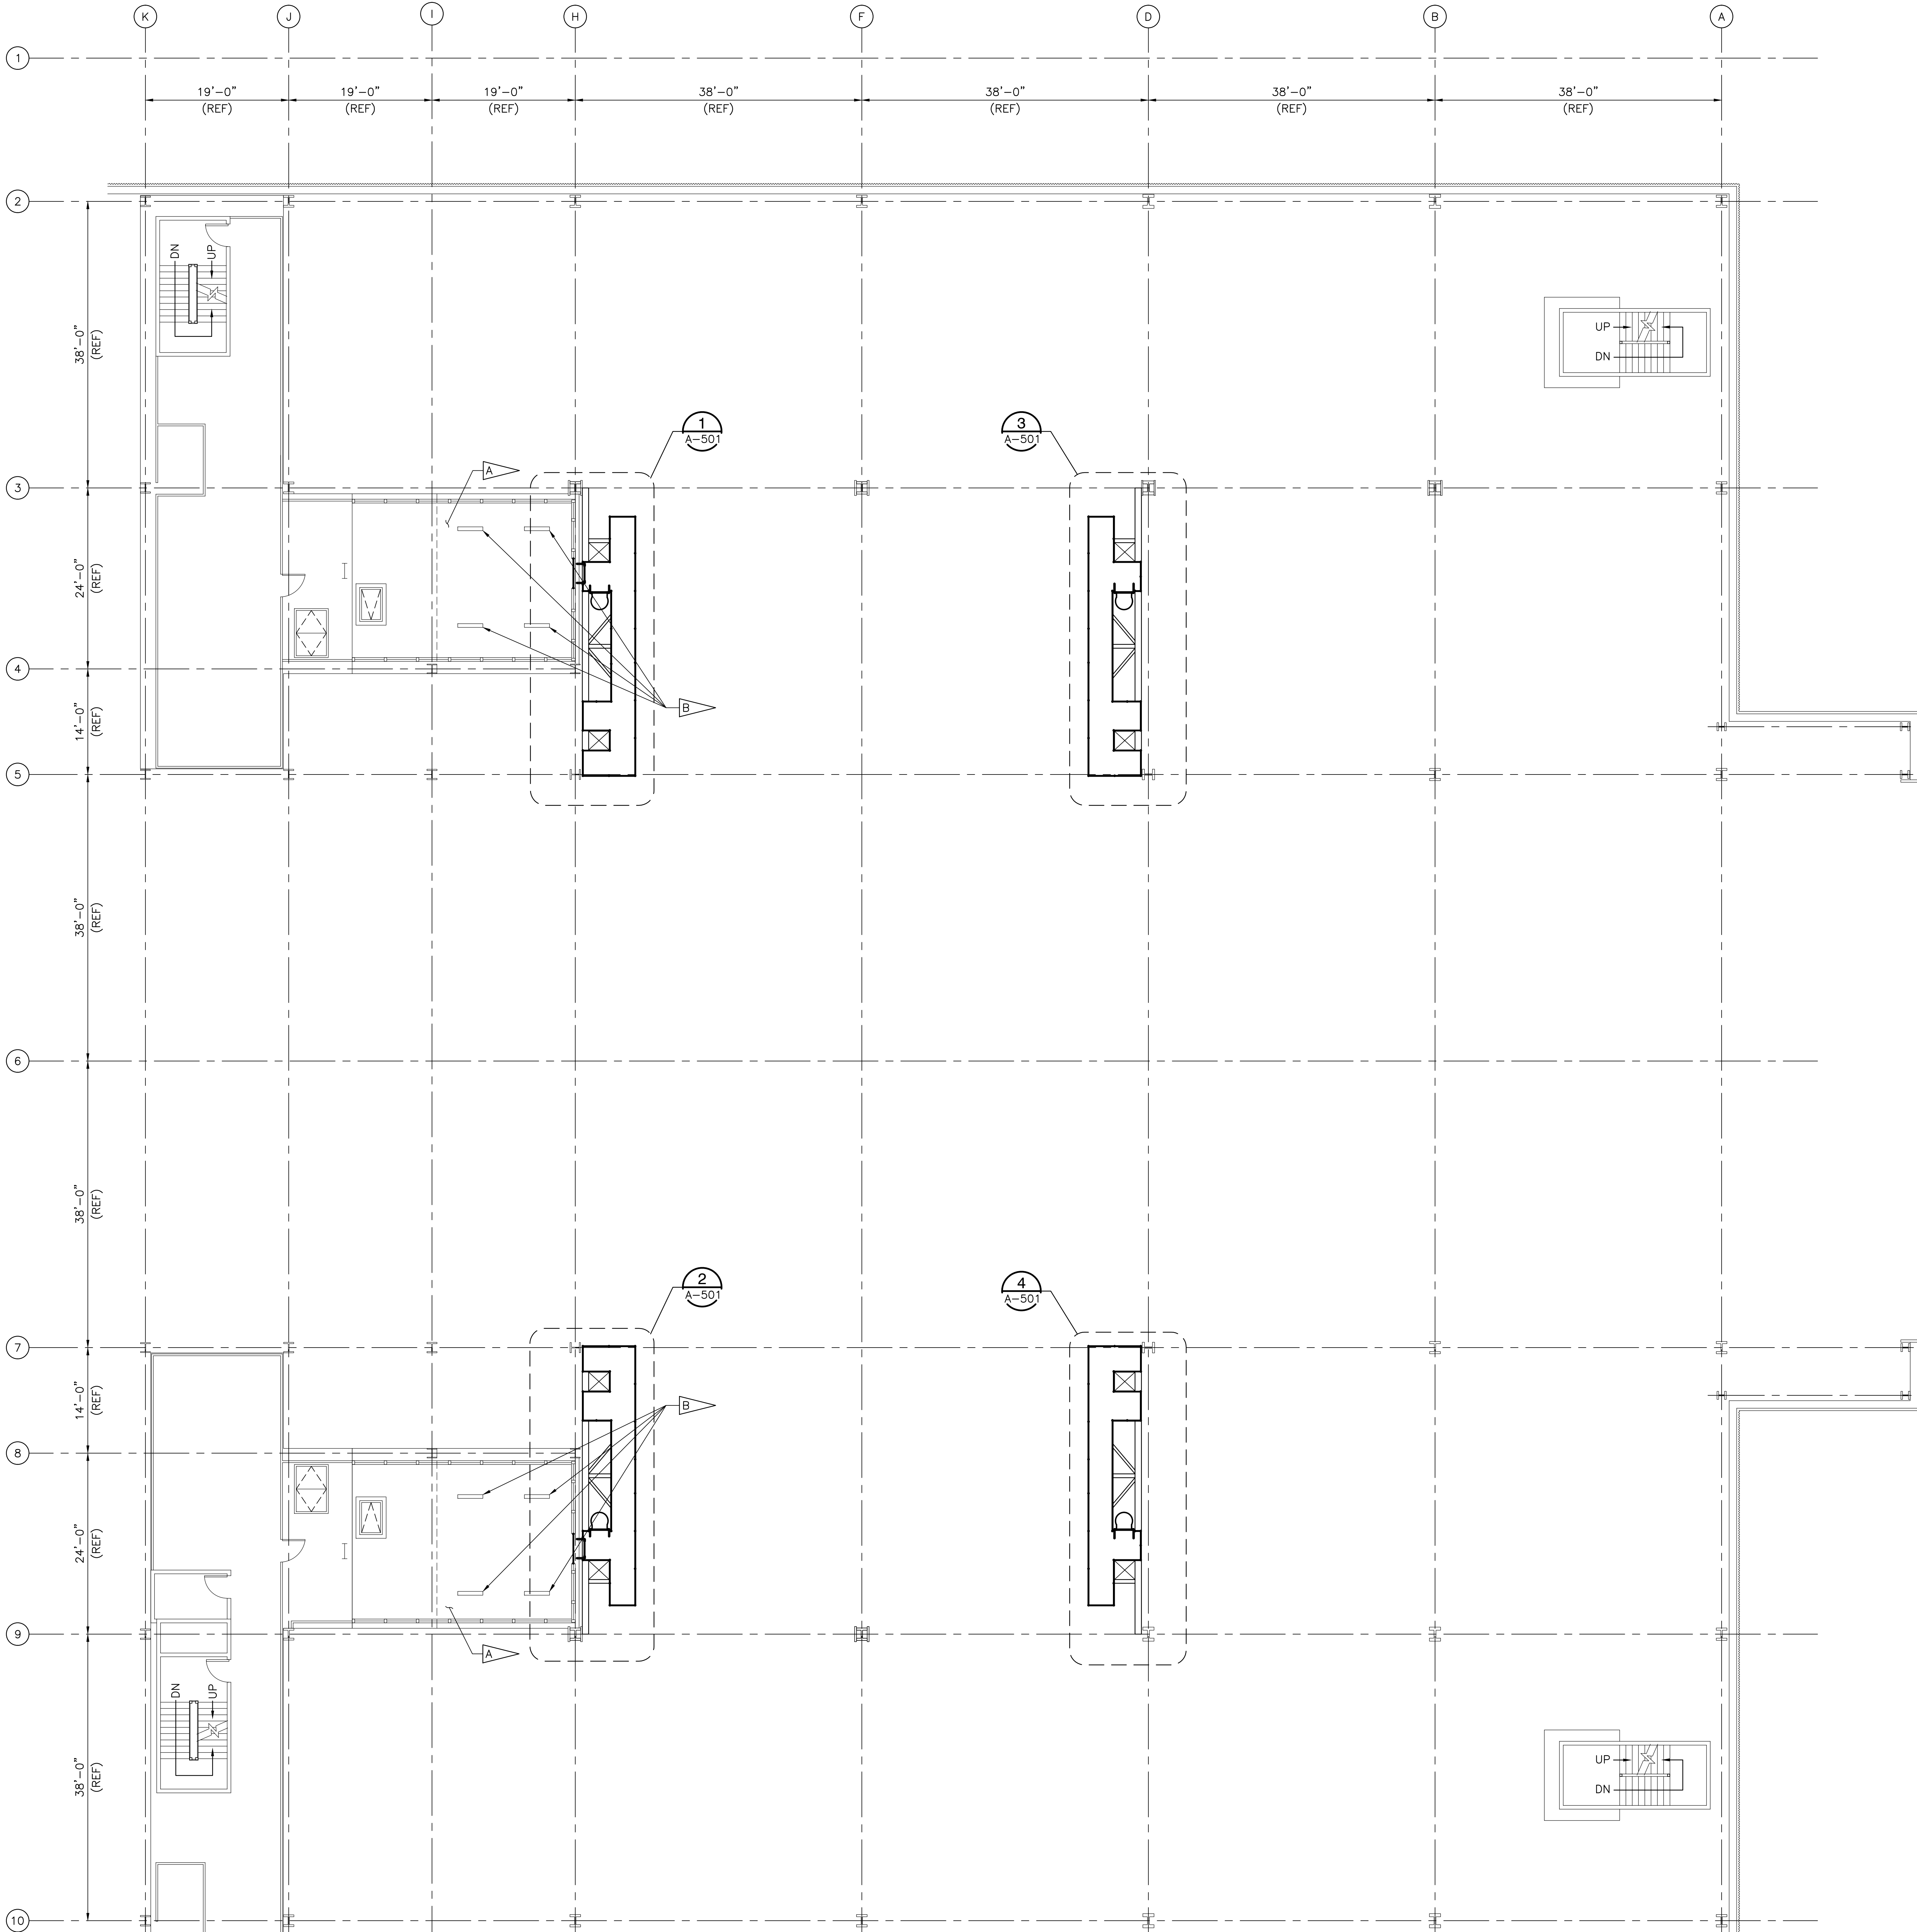A EXISTING ELEVATOR MACHINE ROOM.


B HOLE THROUGH CONCRETE FLOOR FOR HOIST ROPE.
COORDINATE SIZE AND LOCATION WITH HOIST MANUFACTURER.



 **VAB KEY PLAN**
SCALE: NTS

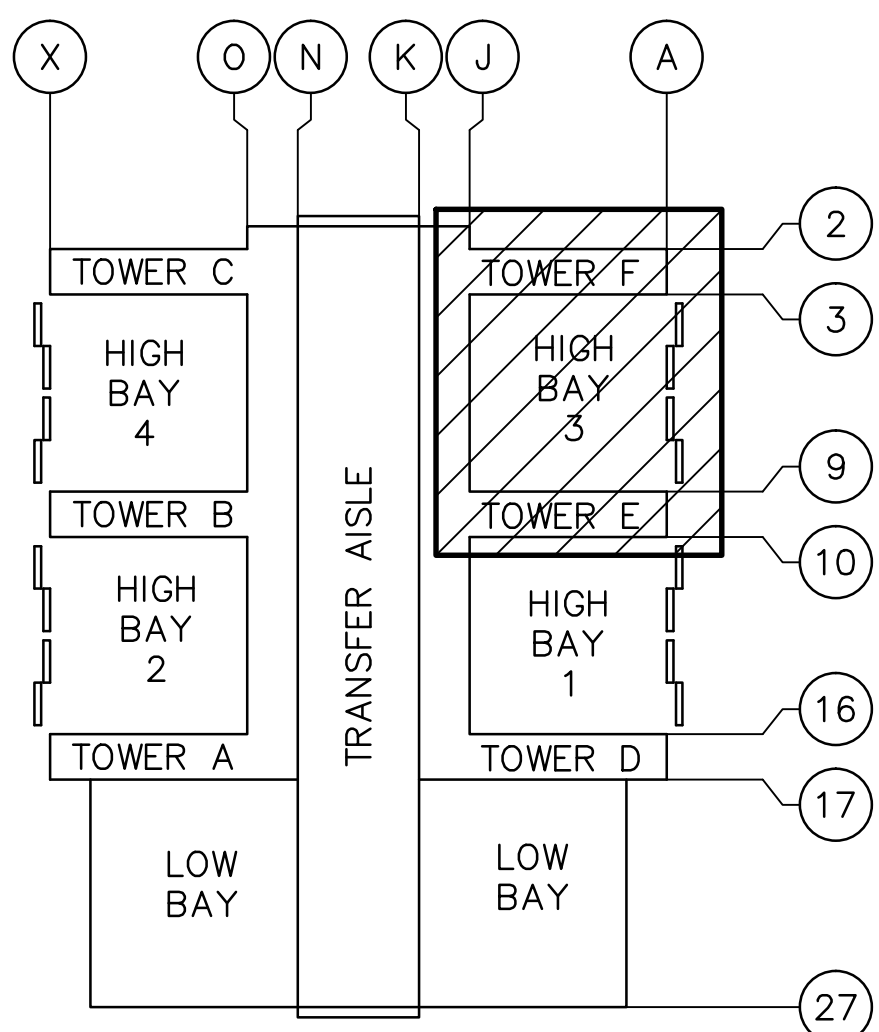SYM	ZONE	DESCRIPTION	DATE	APPROVAL
<div style="text-align: center;"> REVISIONS </div>				
		<div style="display: flex; justify-content: space-between; align-items: center;"> <div style="text-align: center;">  </div> <div> Reynolds, Smith and Hills, Inc. 115 Alma Blvd, Suite 101 Merritt Island, Florida 32953-4101 (321) 453-9212 (321) 453-0223 FAX www.rsandh.com </div> </div>		
SIGNATURES		DATE		
DRAWN: BRIAN CURTIS		08-20-2013		
CHECKED: ALICE SCHULTZ		08-20-2013		
SUBMITTED: ARCHIVING OF RECORD:				
ANTHONY MAZZA				
ST OF LICENSE#: FL				
LICENSE NO:				
APPROVED:				
JOHN KERCSMAR				
		FILE NO.	SIZE	DWG. NO.
		302-6058-043	E	79K39667
MIKE HARTNETT		PROJ. NO.	PCN	99000.5
		SHEET	8	OF

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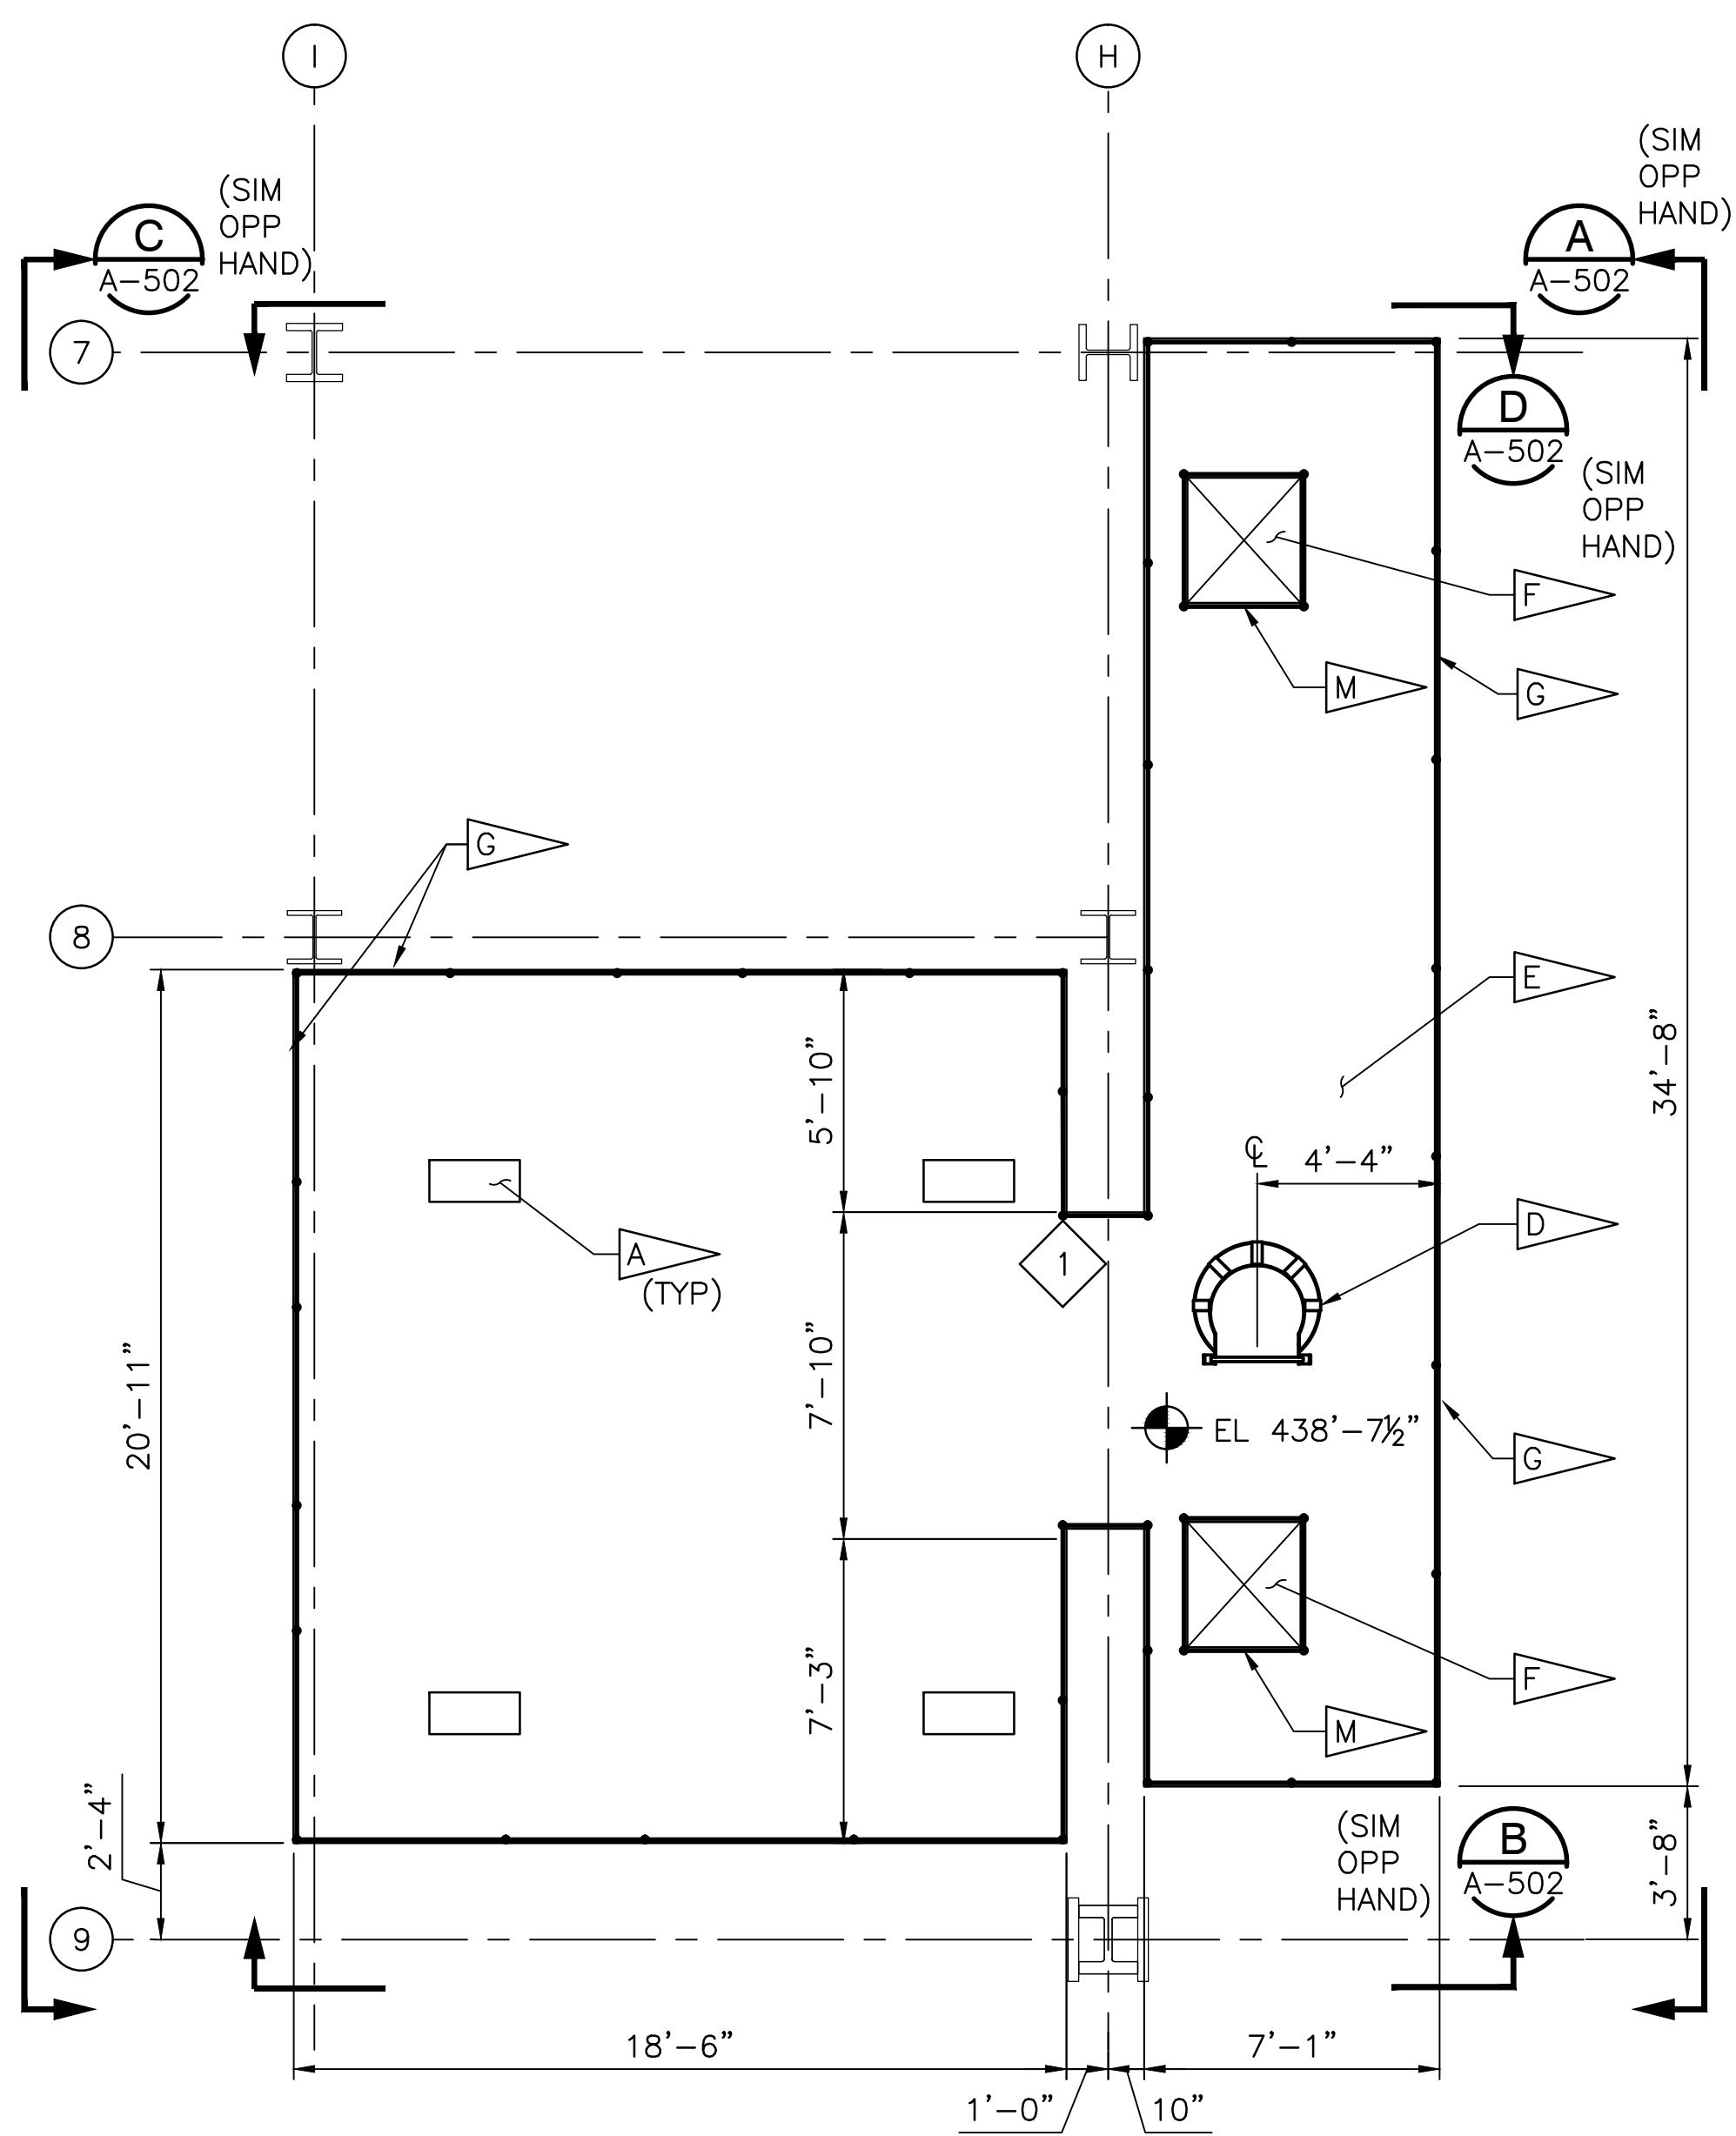


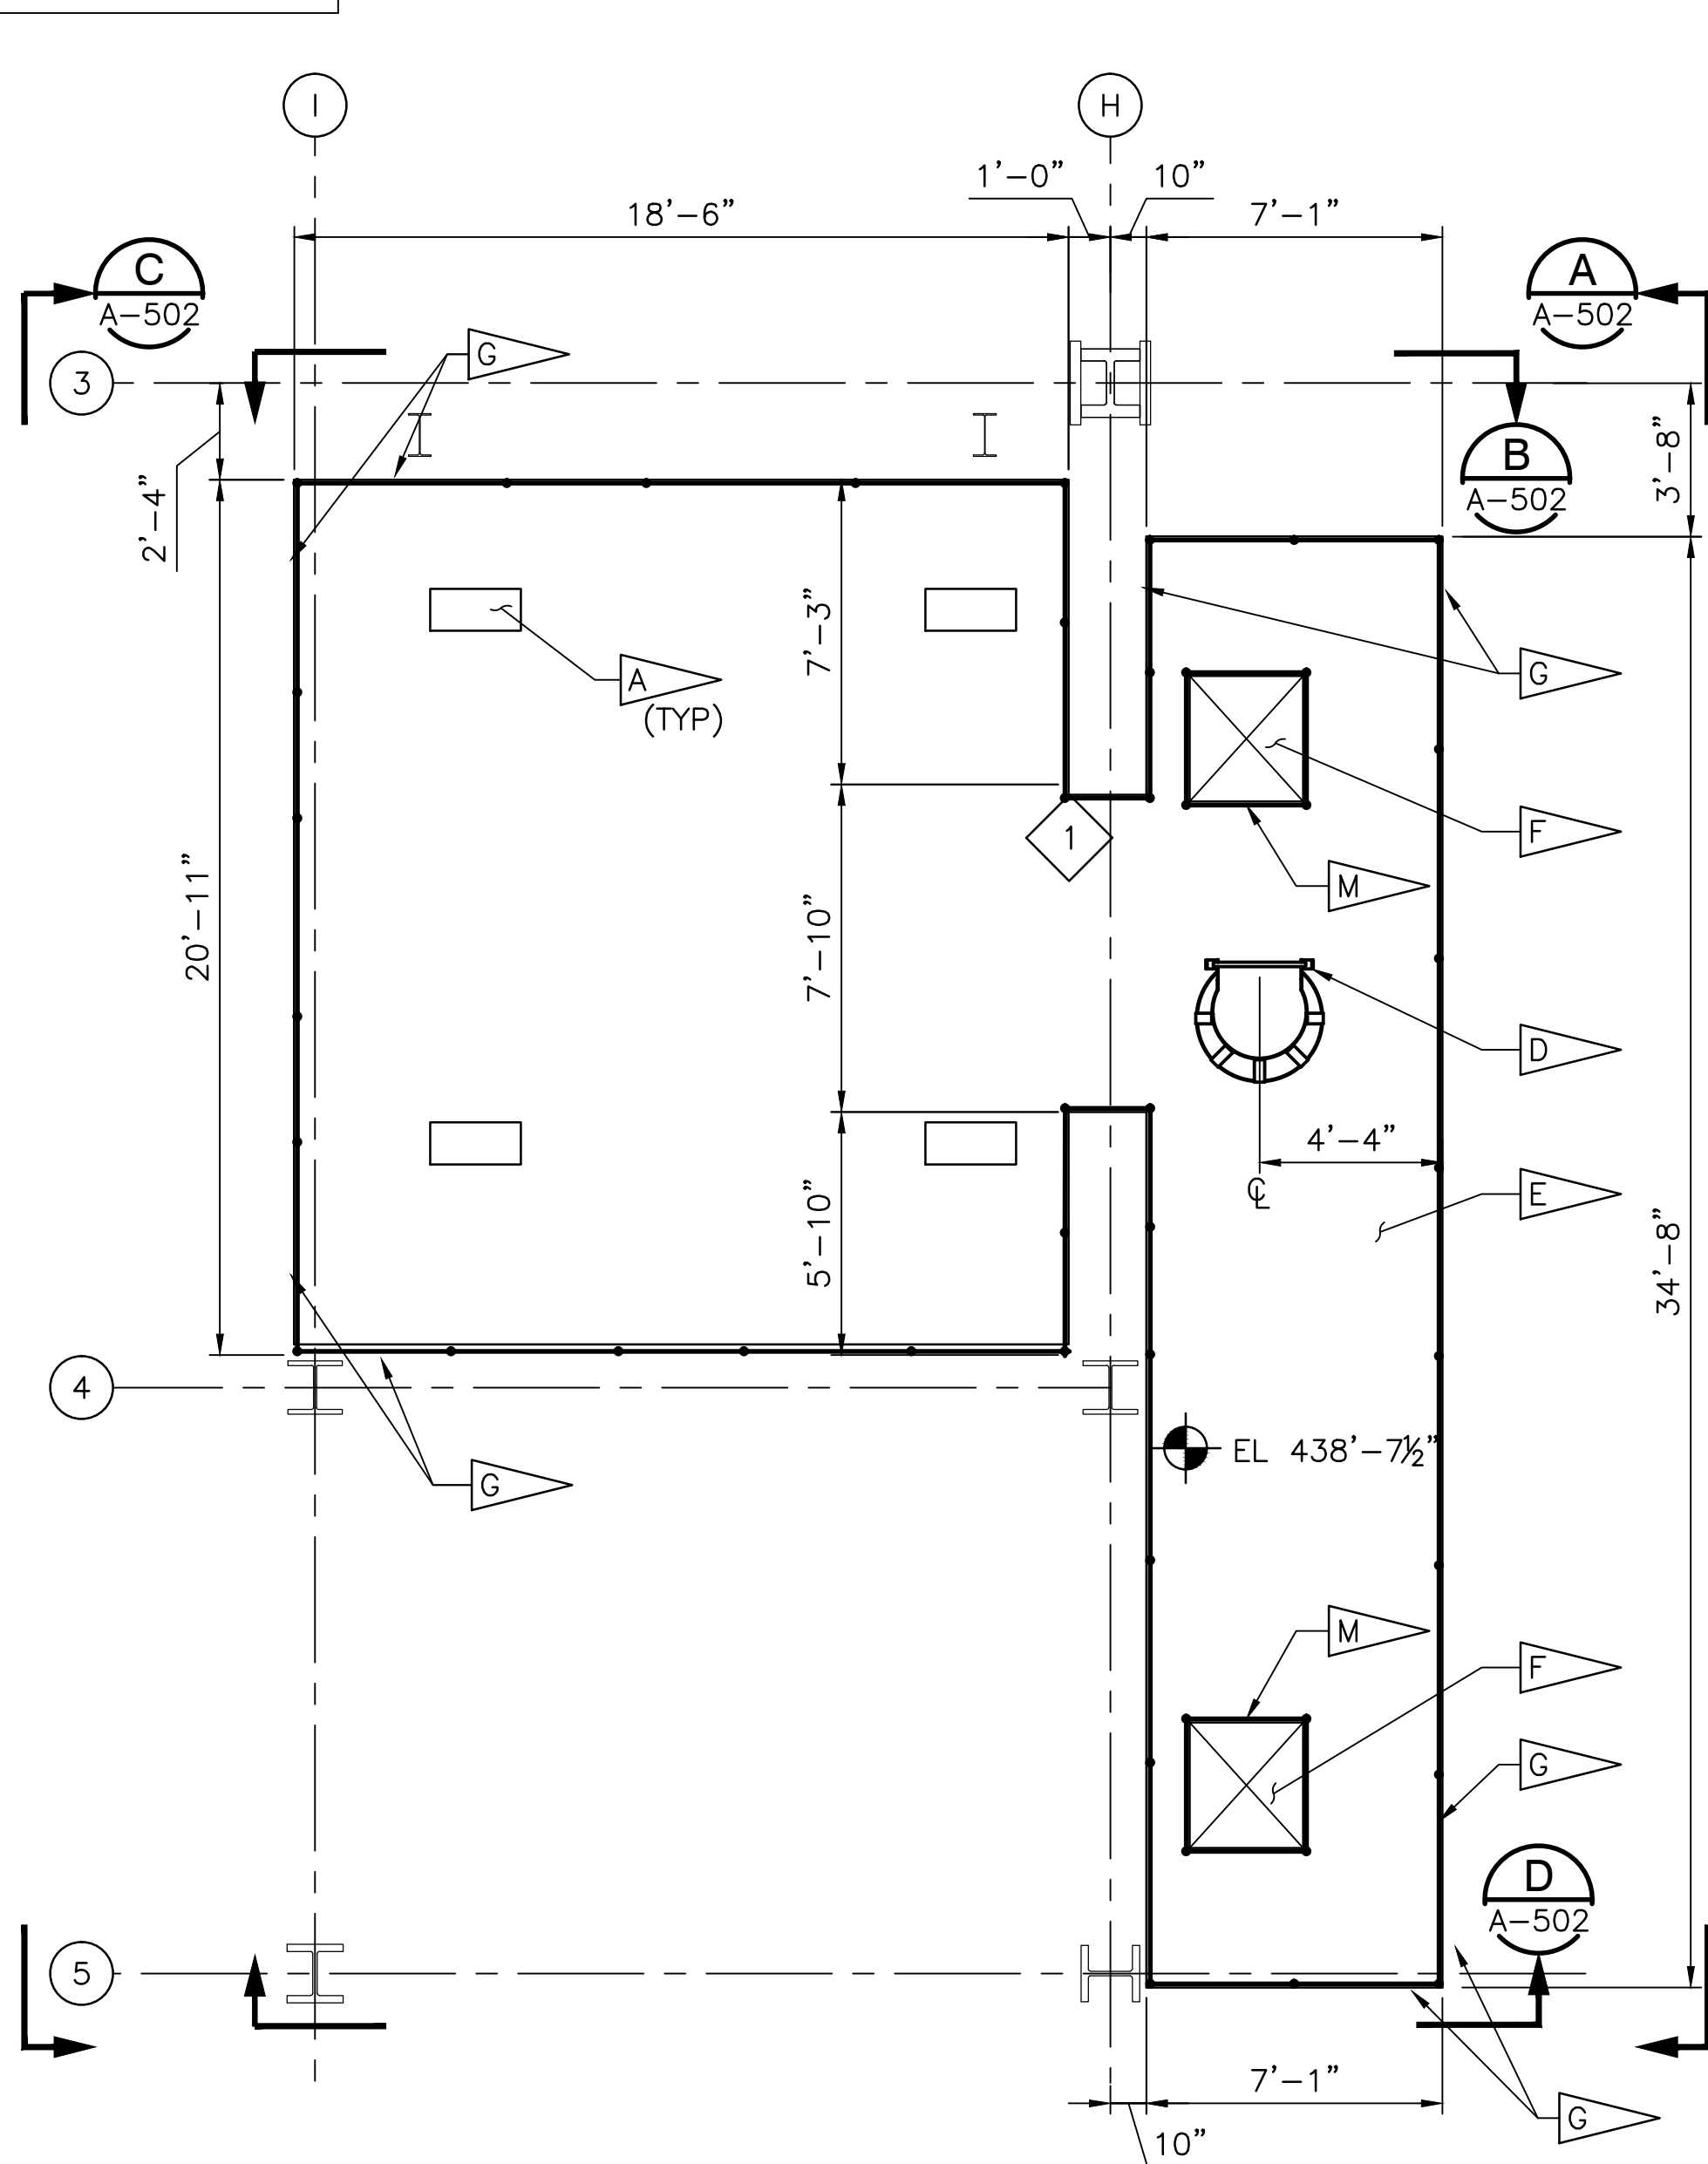LEVEL 35

SERVICE PLATFORM PLAN - TOWER F @ COL LINE H

SCALE: 1/4" = 1'-0"

1
A-135




LEVEL 35

SERVICE PLATFORM PLAN - TOWER E @ COL LINE H

SCALE: 1/4" = 1'-0"


(2)
A-135

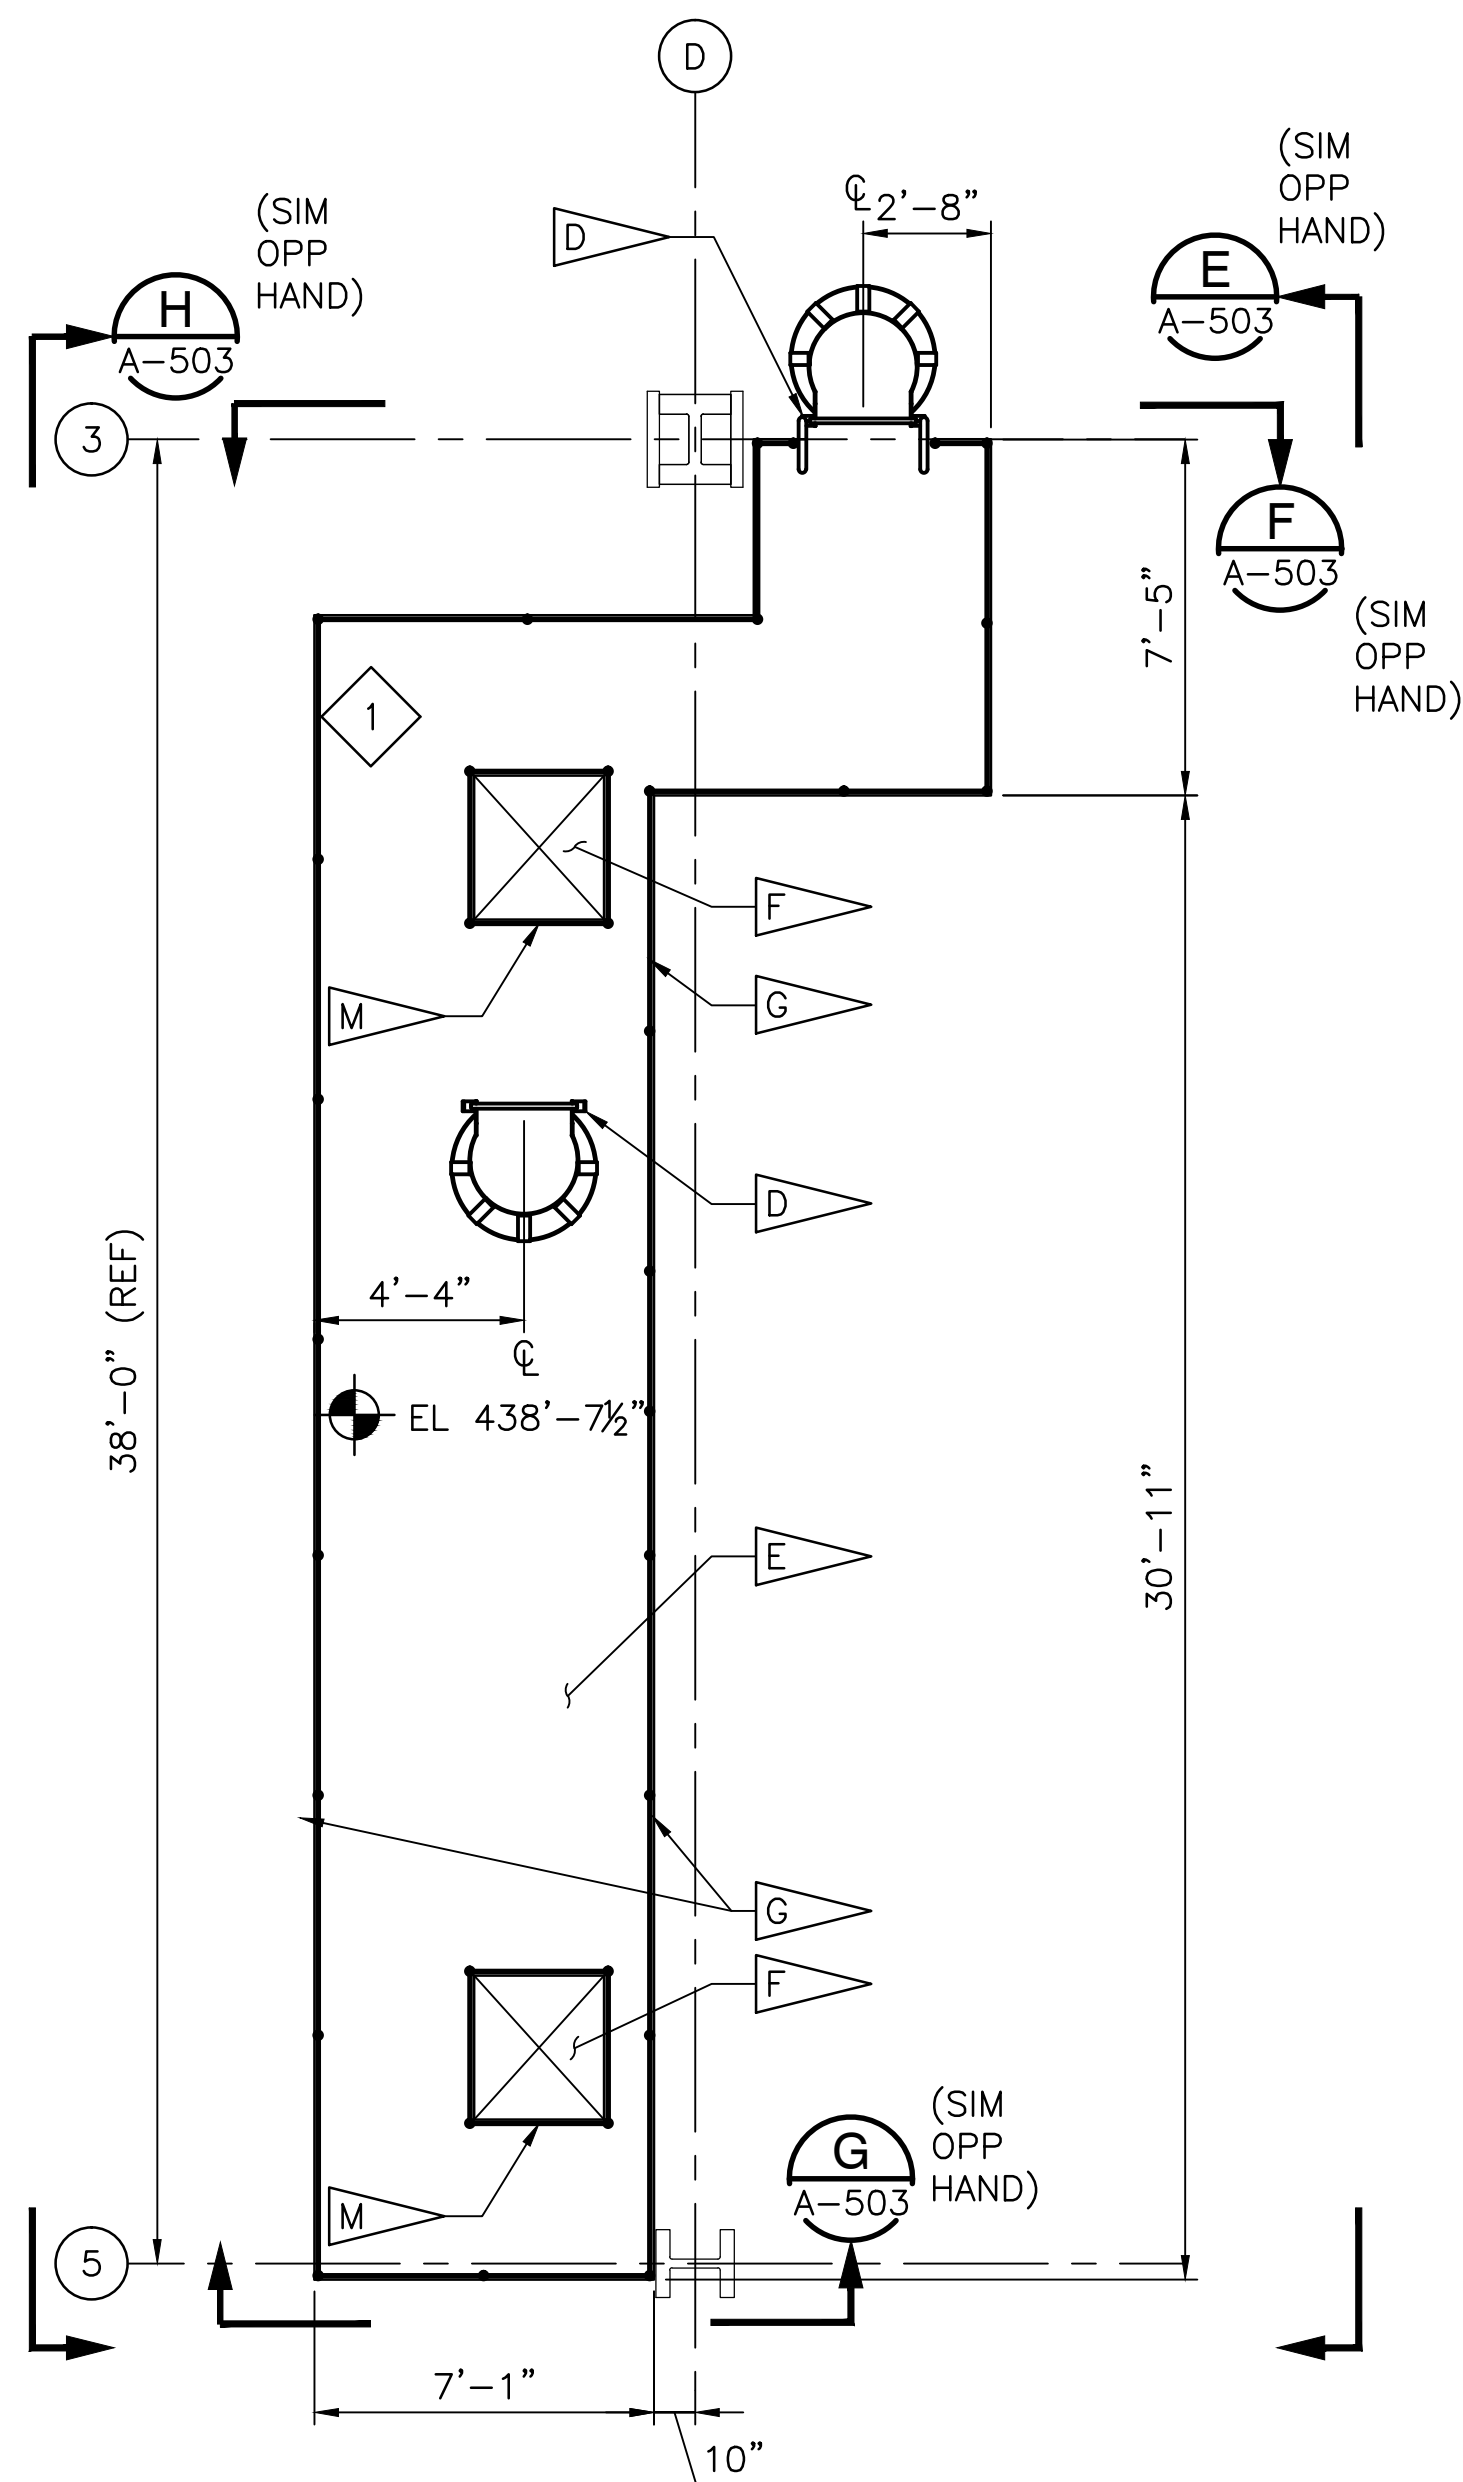


LEVEL 35

SERVICE PLATFORM PLAN - TOWER F @ COL LINE D 3

SCALE: 1/4" = 1'-0" A-135

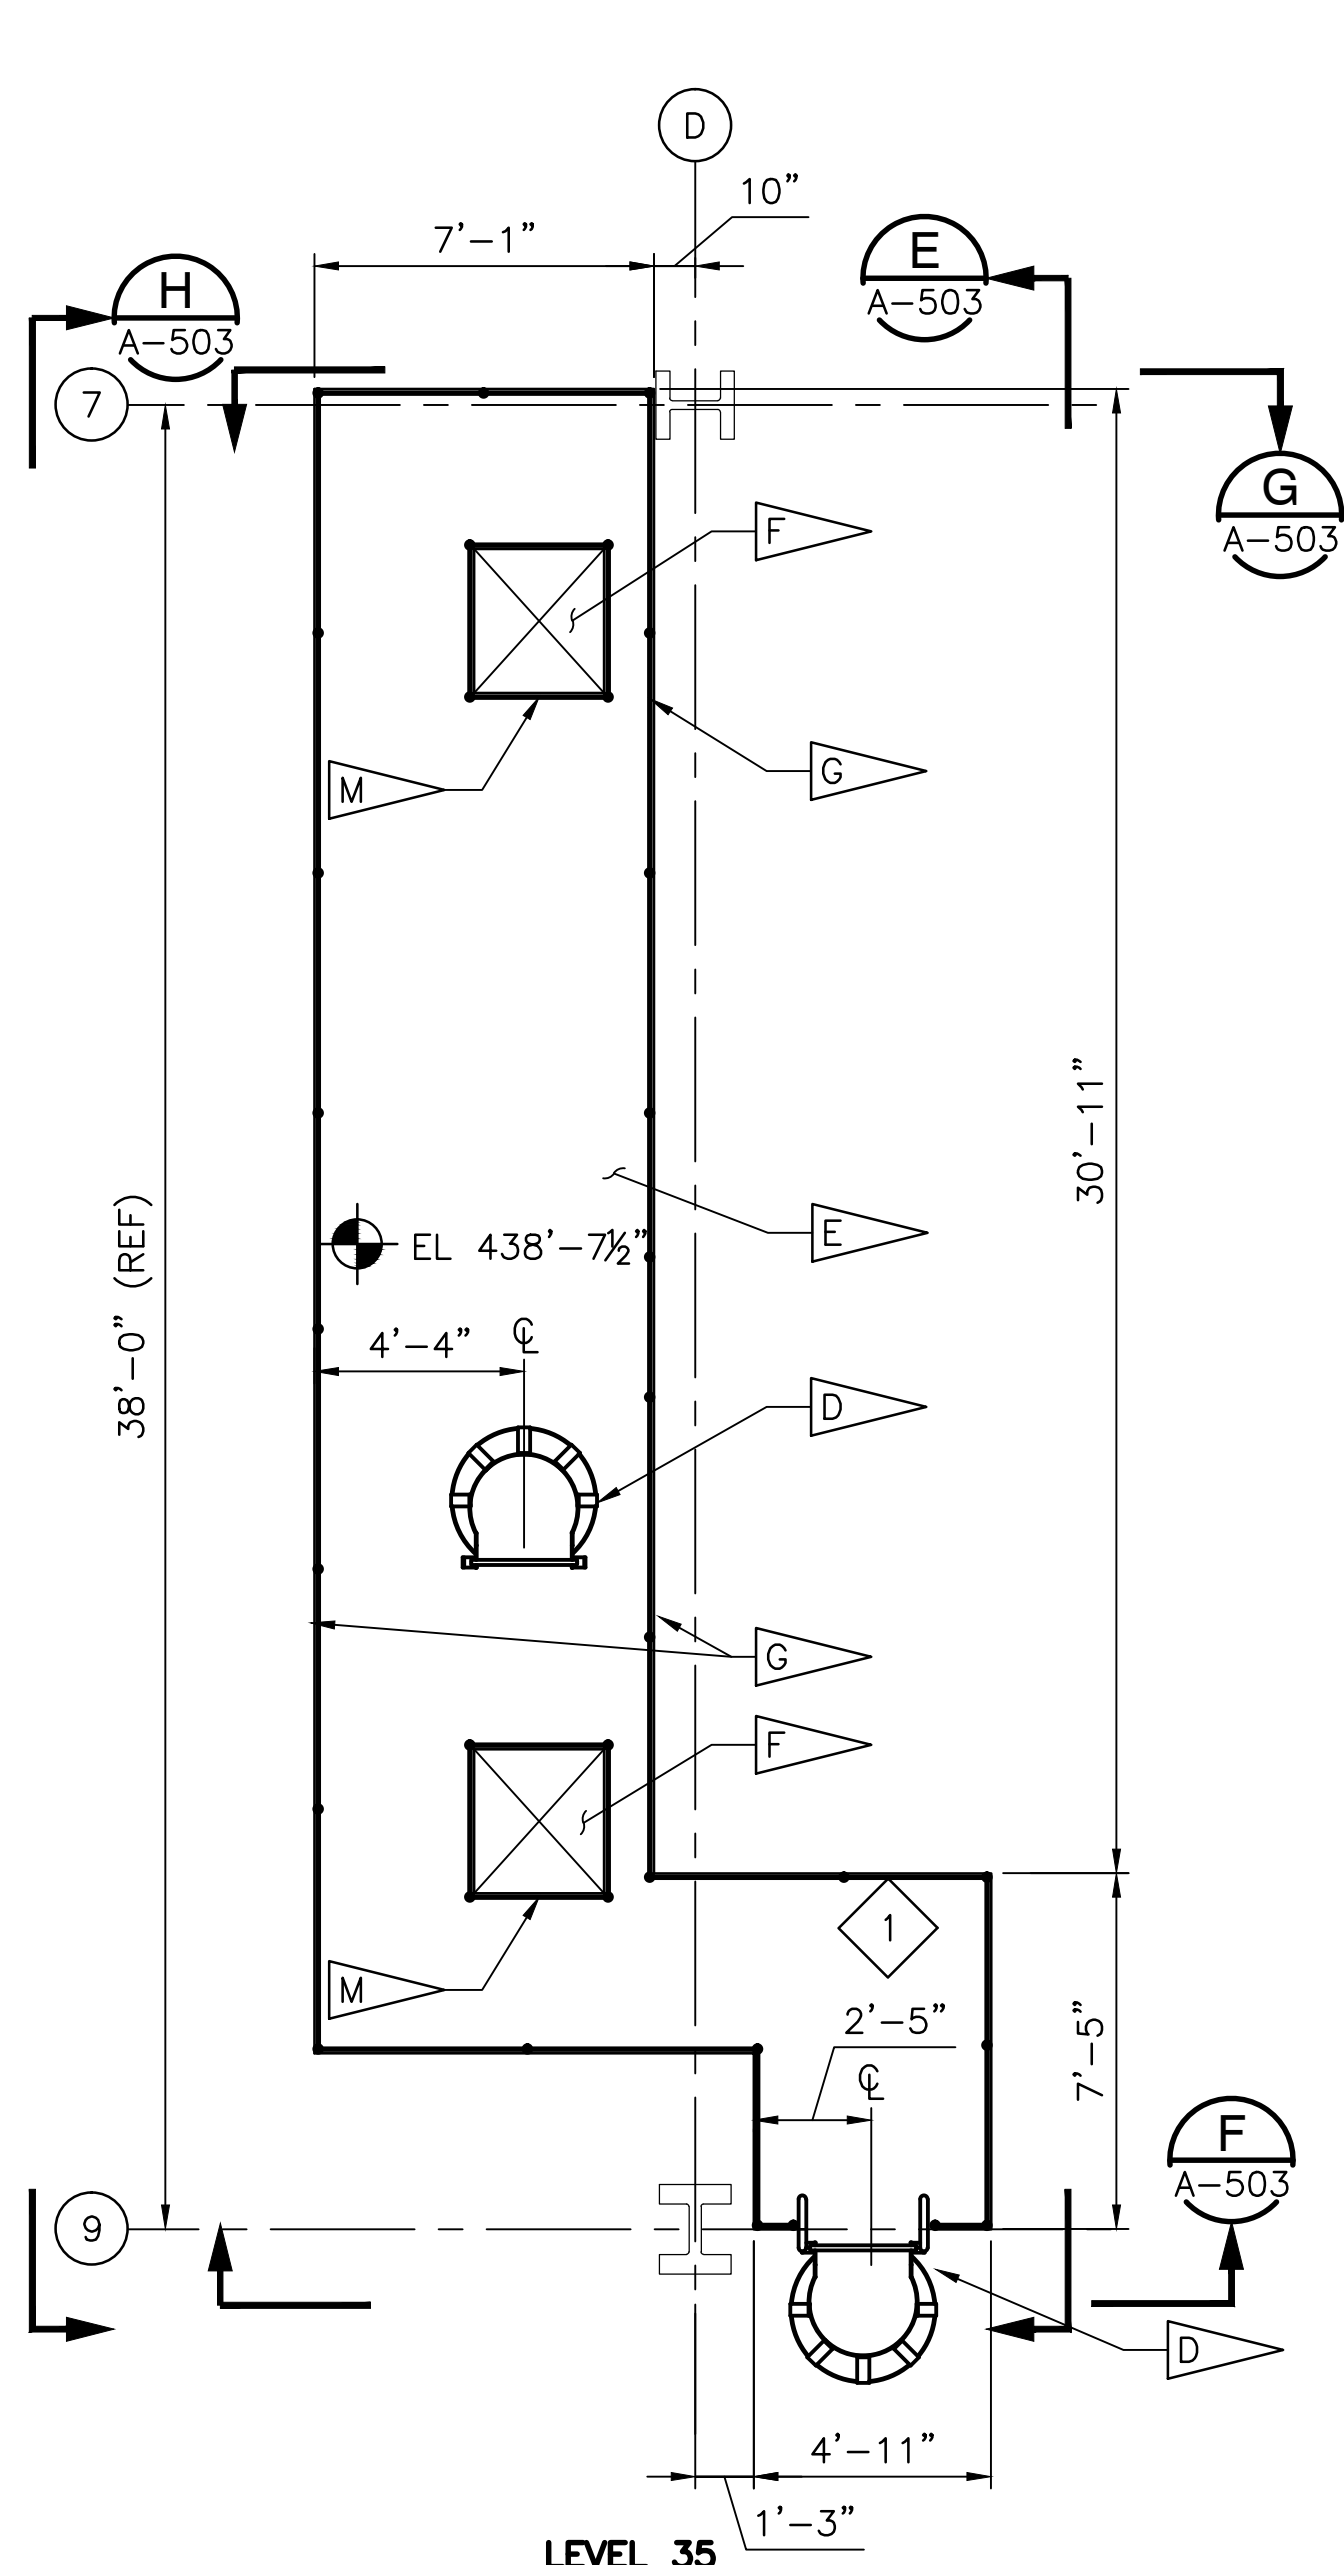


SERVICE PLATFORM PLAN - TOWER E @ COL LINE D 4
SCALE: 1/4" = 1'-0" A-135

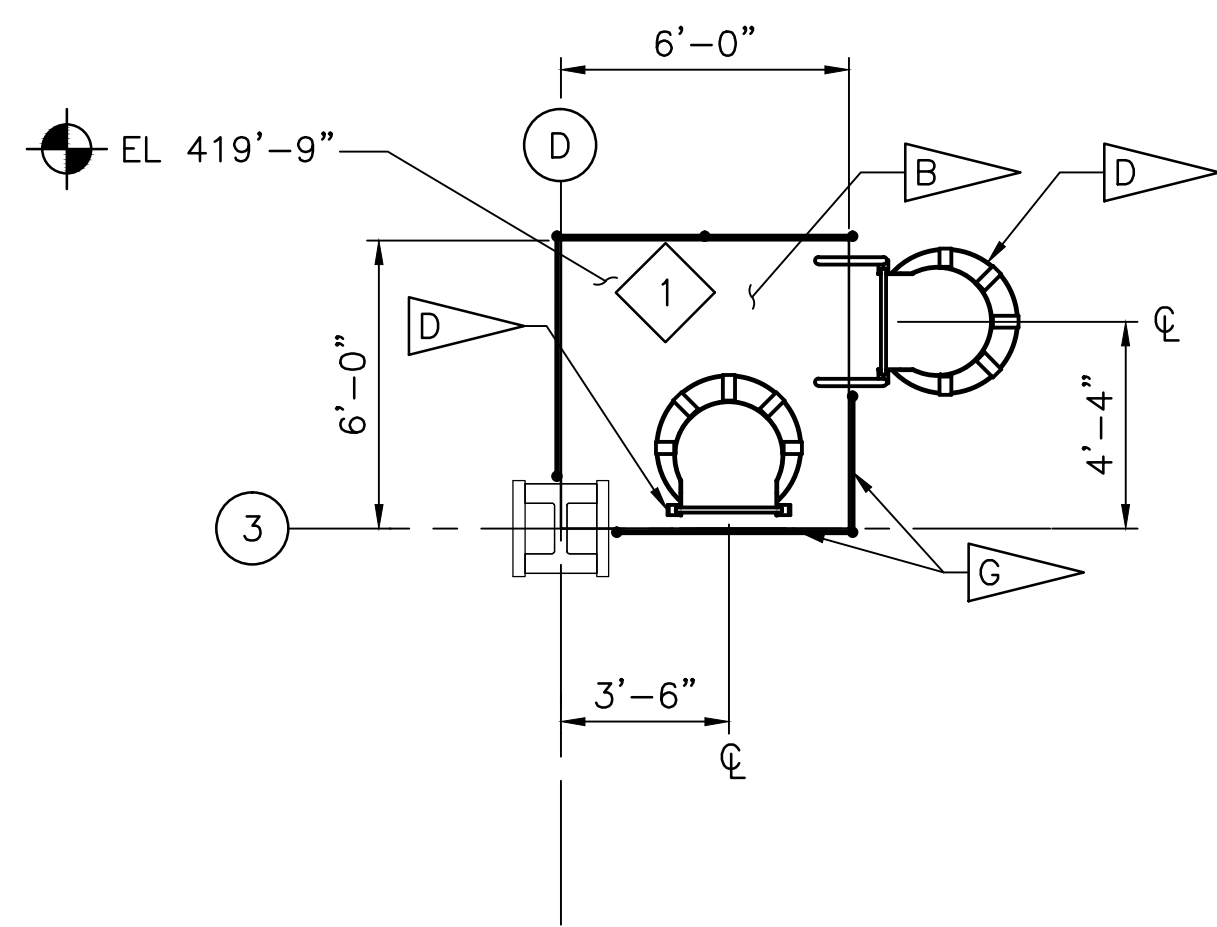


LEVEL 34

LADDER LANDING PLAN - TOWER F @ COL LINE D


SCALE: 1/4" = 1'-0"

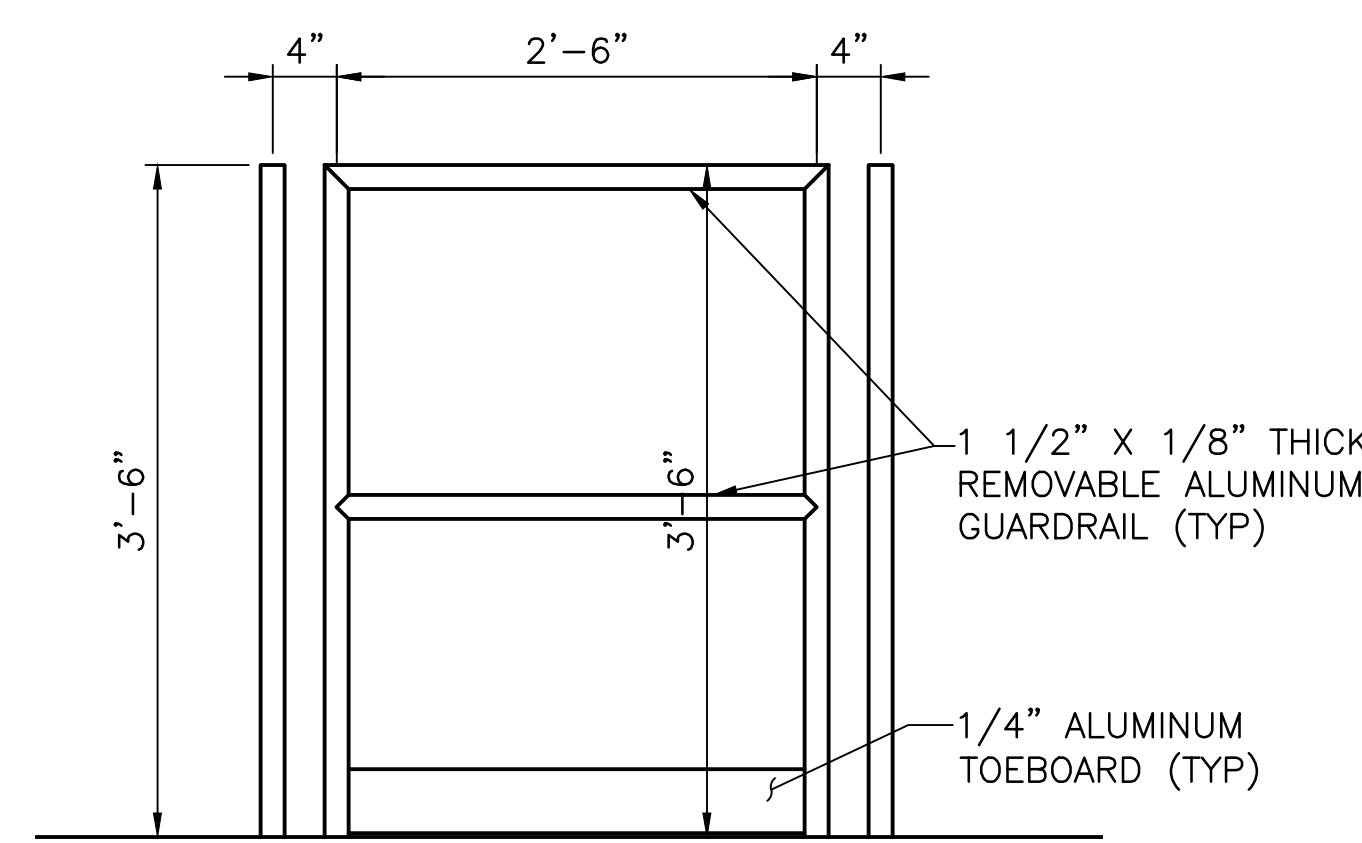

REMOVABLE GUARDRAIL (TYP) 
SCALE: 1" = 1'-0"

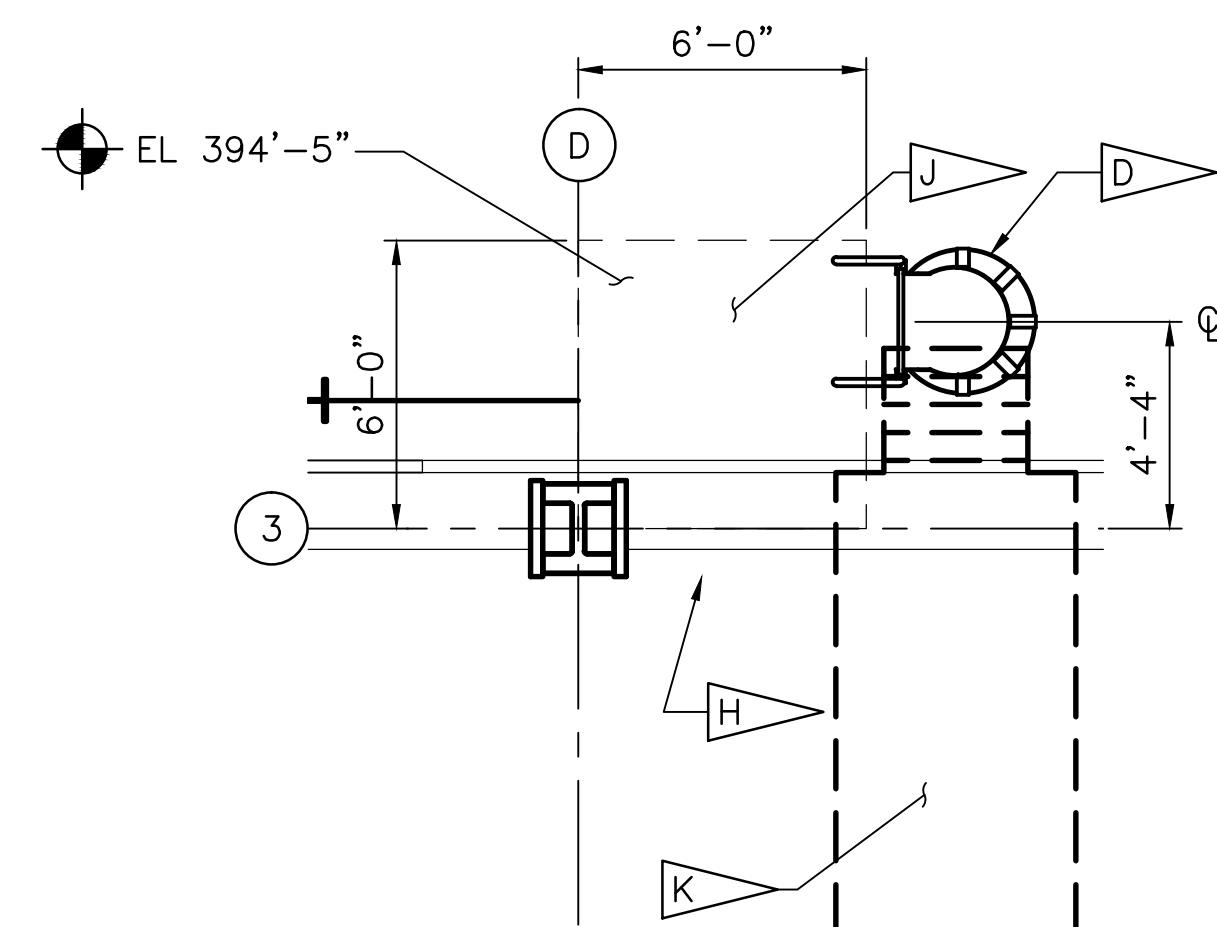


LEVEL 32
LADDER PLAN - TOWER F @ COL LINE D
SCALE: 1/4" = 1'-0"

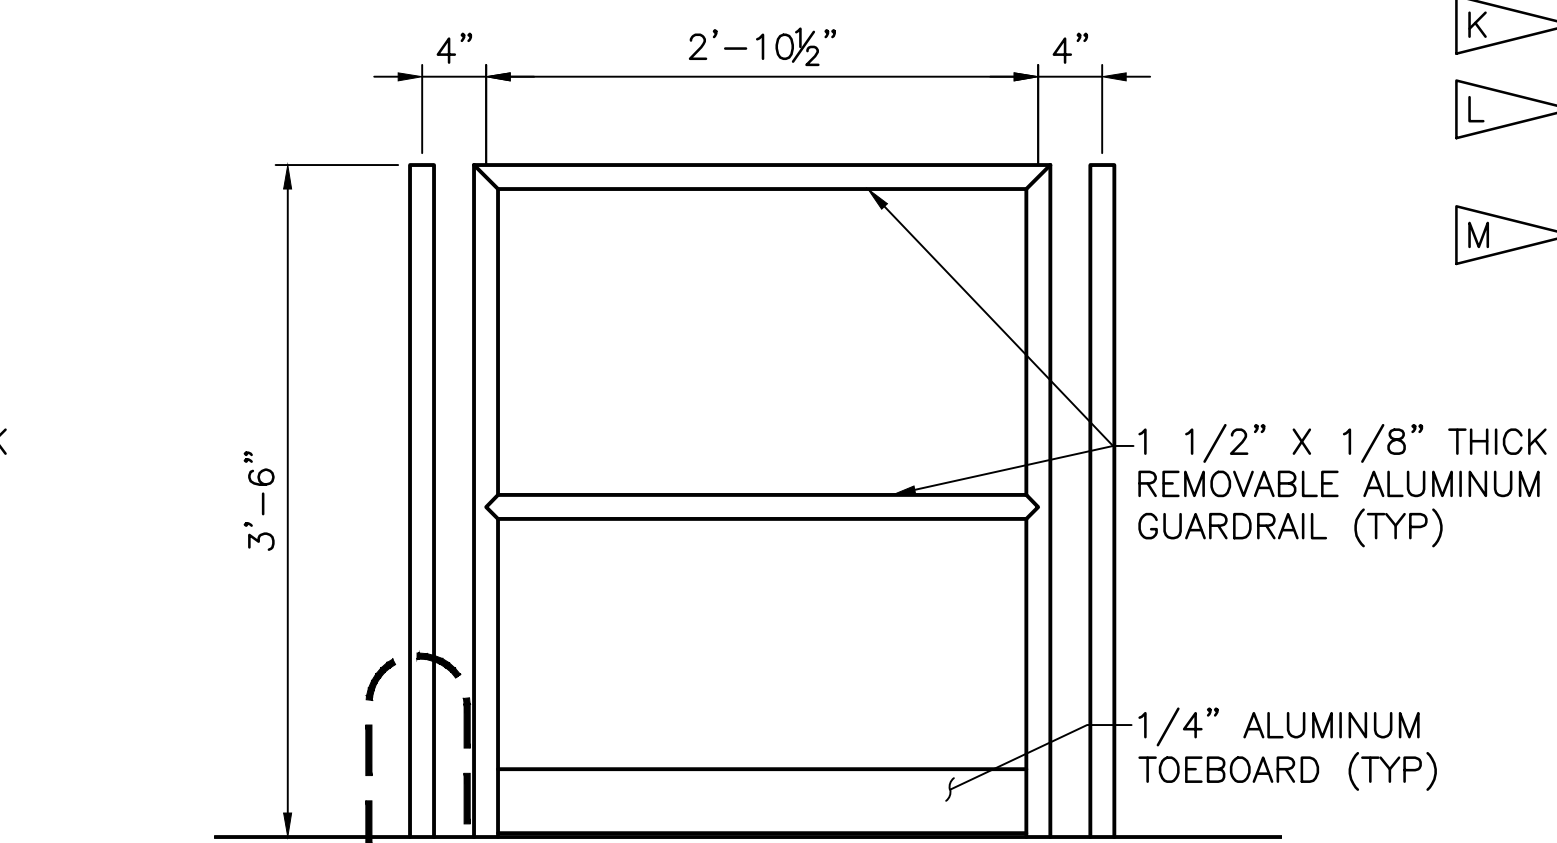


REMOVABLE GUARDRAIL (TYP) 
SCALE: 1" = 1'-0" 

- ### SPECIFIC NOTES:
- | | |
|----------|--|
| A | FLOOR OPENING FOR HOIST. THE OPENING SIZE TO BE DETERMINED DURING SHOP DRAWING PHASE ONCE THE HOIST MANUFACTURER IS CHOSEN. IF OPENING IN FLOOR IS LARGER THAN OSHA MINIMUM, GUARDRAILS AROUND OPENING WILL BE REQUIRED. |
| B | NEW LANDING. |
| C | NOT USED. |
| D | NEW FIXED LADDER, SEE A-505 FOR DETAILS. |
| E | NEW SERVICE PLATFORM. SEE STRUCTURAL FOR FRAMING AND DETAILS. |
| F | OPENING IN PLATFORM FLOOR. |
| G | FIXED STEEL GUARDRAIL. |
| H | EDGE OF SLAB. |
| J | NEW LANDING ABOVE. |
| K | DEMOLISH STAIR AND EXISTING CATWALK - CATWALK 38' x 5'. |
| L | REMOVE 5'-0" OF EXISTING GUARDRAIL TO MAKE ROOM FOR NEW LADDER. |
| M | REMOVABLE ALUMINUM GUARDRAIL ALL FOUR SIDES OF OPENING, SEE DETAIL A AND B ON THIS SHEET. |

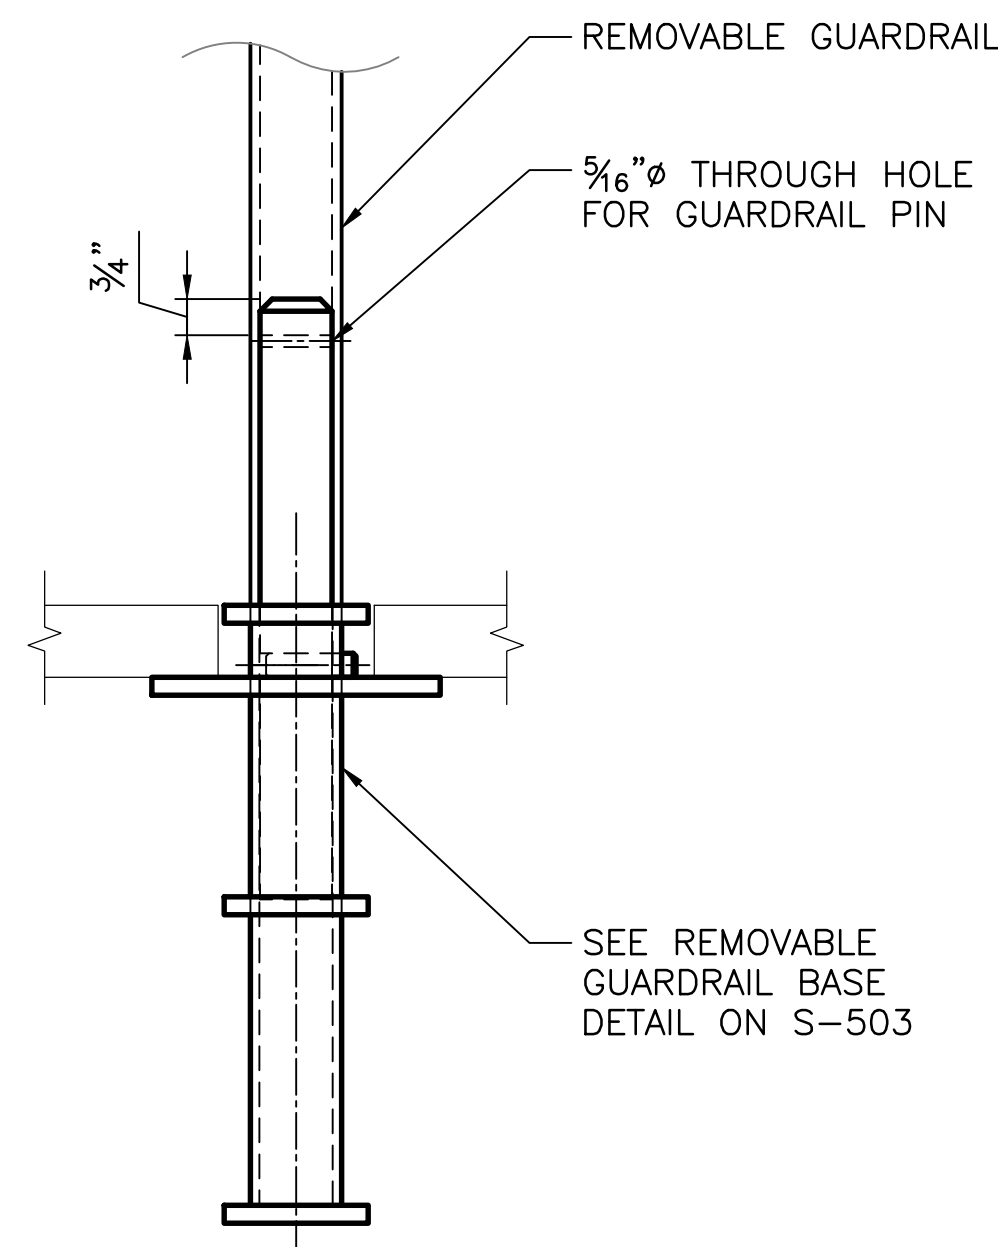


REMOVABLE GUARDRAIL BASE DETAIL (TYP) 5
 SCALE: 3" = 1'-0"

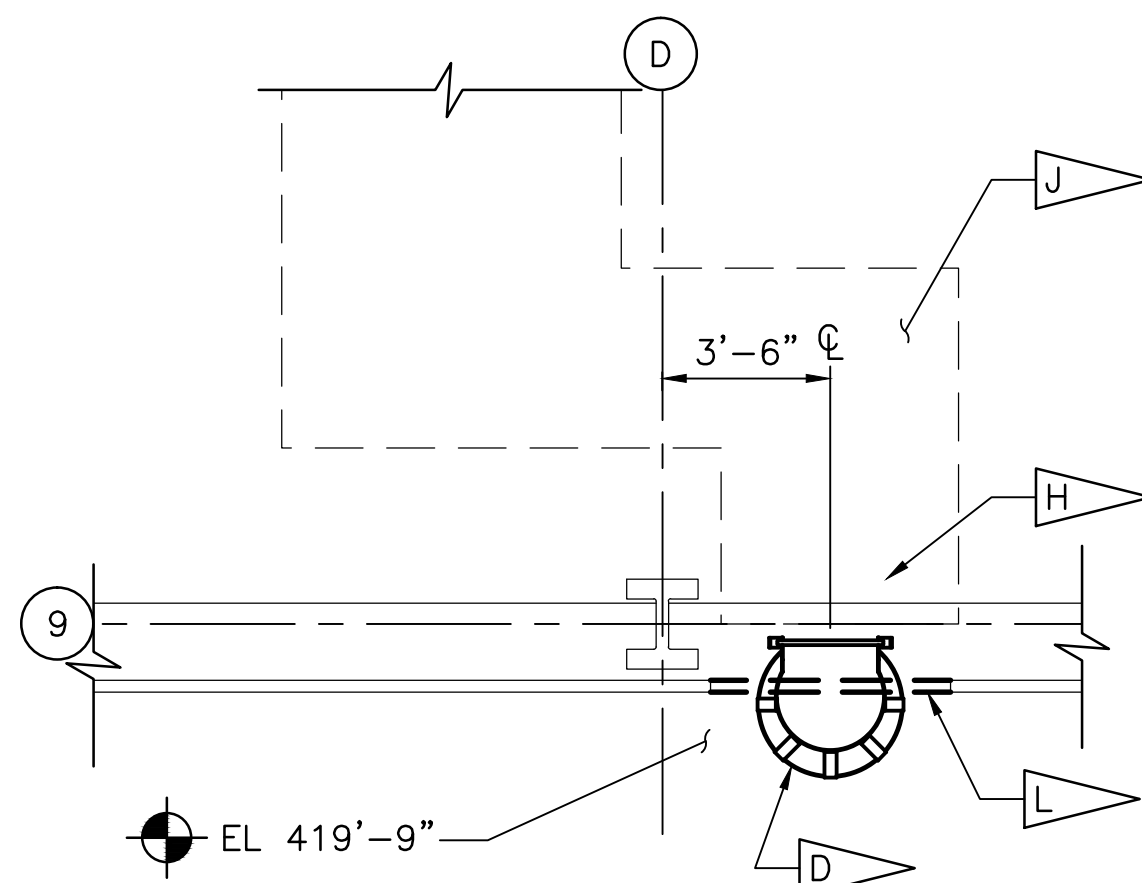


LEVEL 34

LADDER PLAN - TOWER E @ COL LINE D


SCALE: $1/4" = 1'-0"$

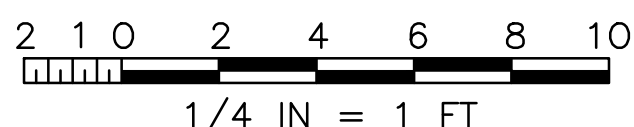


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REVISONS				
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SIGNATURES		DATE		
DRAWN: BRIAN CURTIS		08-20-2013		
CHECKED: ALICE SCHULTZ		08-20-2013		
SUBMITTED ARCHIVING OF RECORD				
ANTHONY MAZZA				
ST OF LICENSE: FL				
LICENSE NO:				
APPROVED:				
JOHN KERSHAW				
MIKE HARTNETT				
NATIONAL AERONAUTICS AND SPACE ADMINISTRATION		JOHN F. KENNEDY SPACE CENTER, NASA		
KENNEDY SPACE CENTER, FLORIDA		LAUNCH COMPLEX 39		
		VEHICLE ASSEMBLY BUILDING		
		MODIFY VEHICLE ASSEMBLY BUILDING		
		HIGH BAY 3 FOR SLS - HOISTS		
		ENLARGED PLATFORM PLANS,		
		LEVEL 35		
FILE NO.		SIZE DWG. NO.		REV
302-6058-043		E 79K39667		
PROD. NO.		PCN 99000.5		SHEET 9 OF


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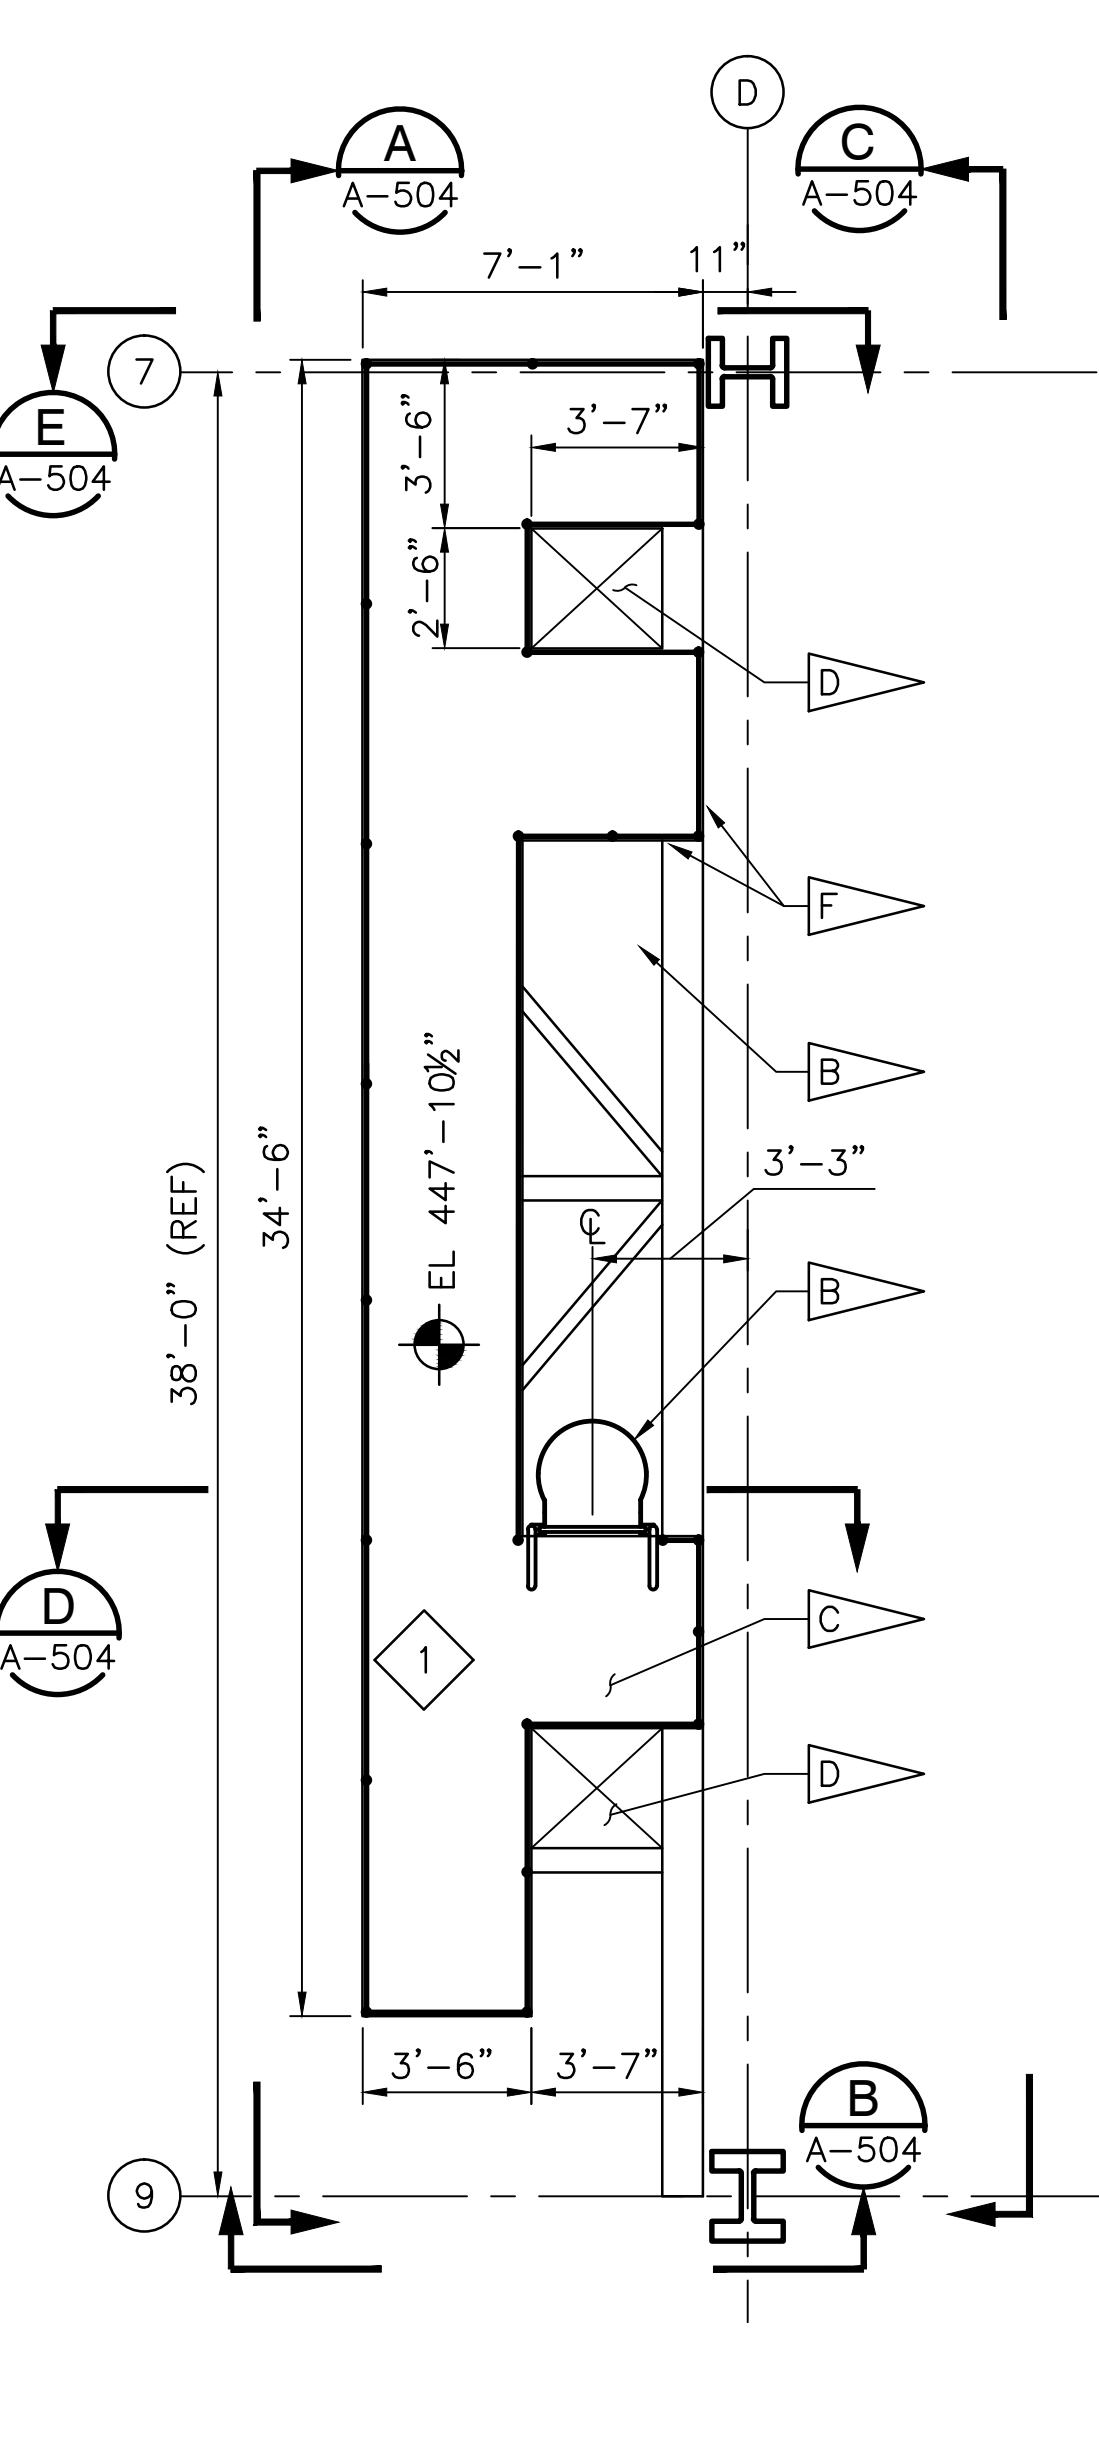
LEVEL 36
SERVICE PLATFORM PLAN - TOWER F @ COL LINE H (1)
SCALE: 1/4" = 1'-0"

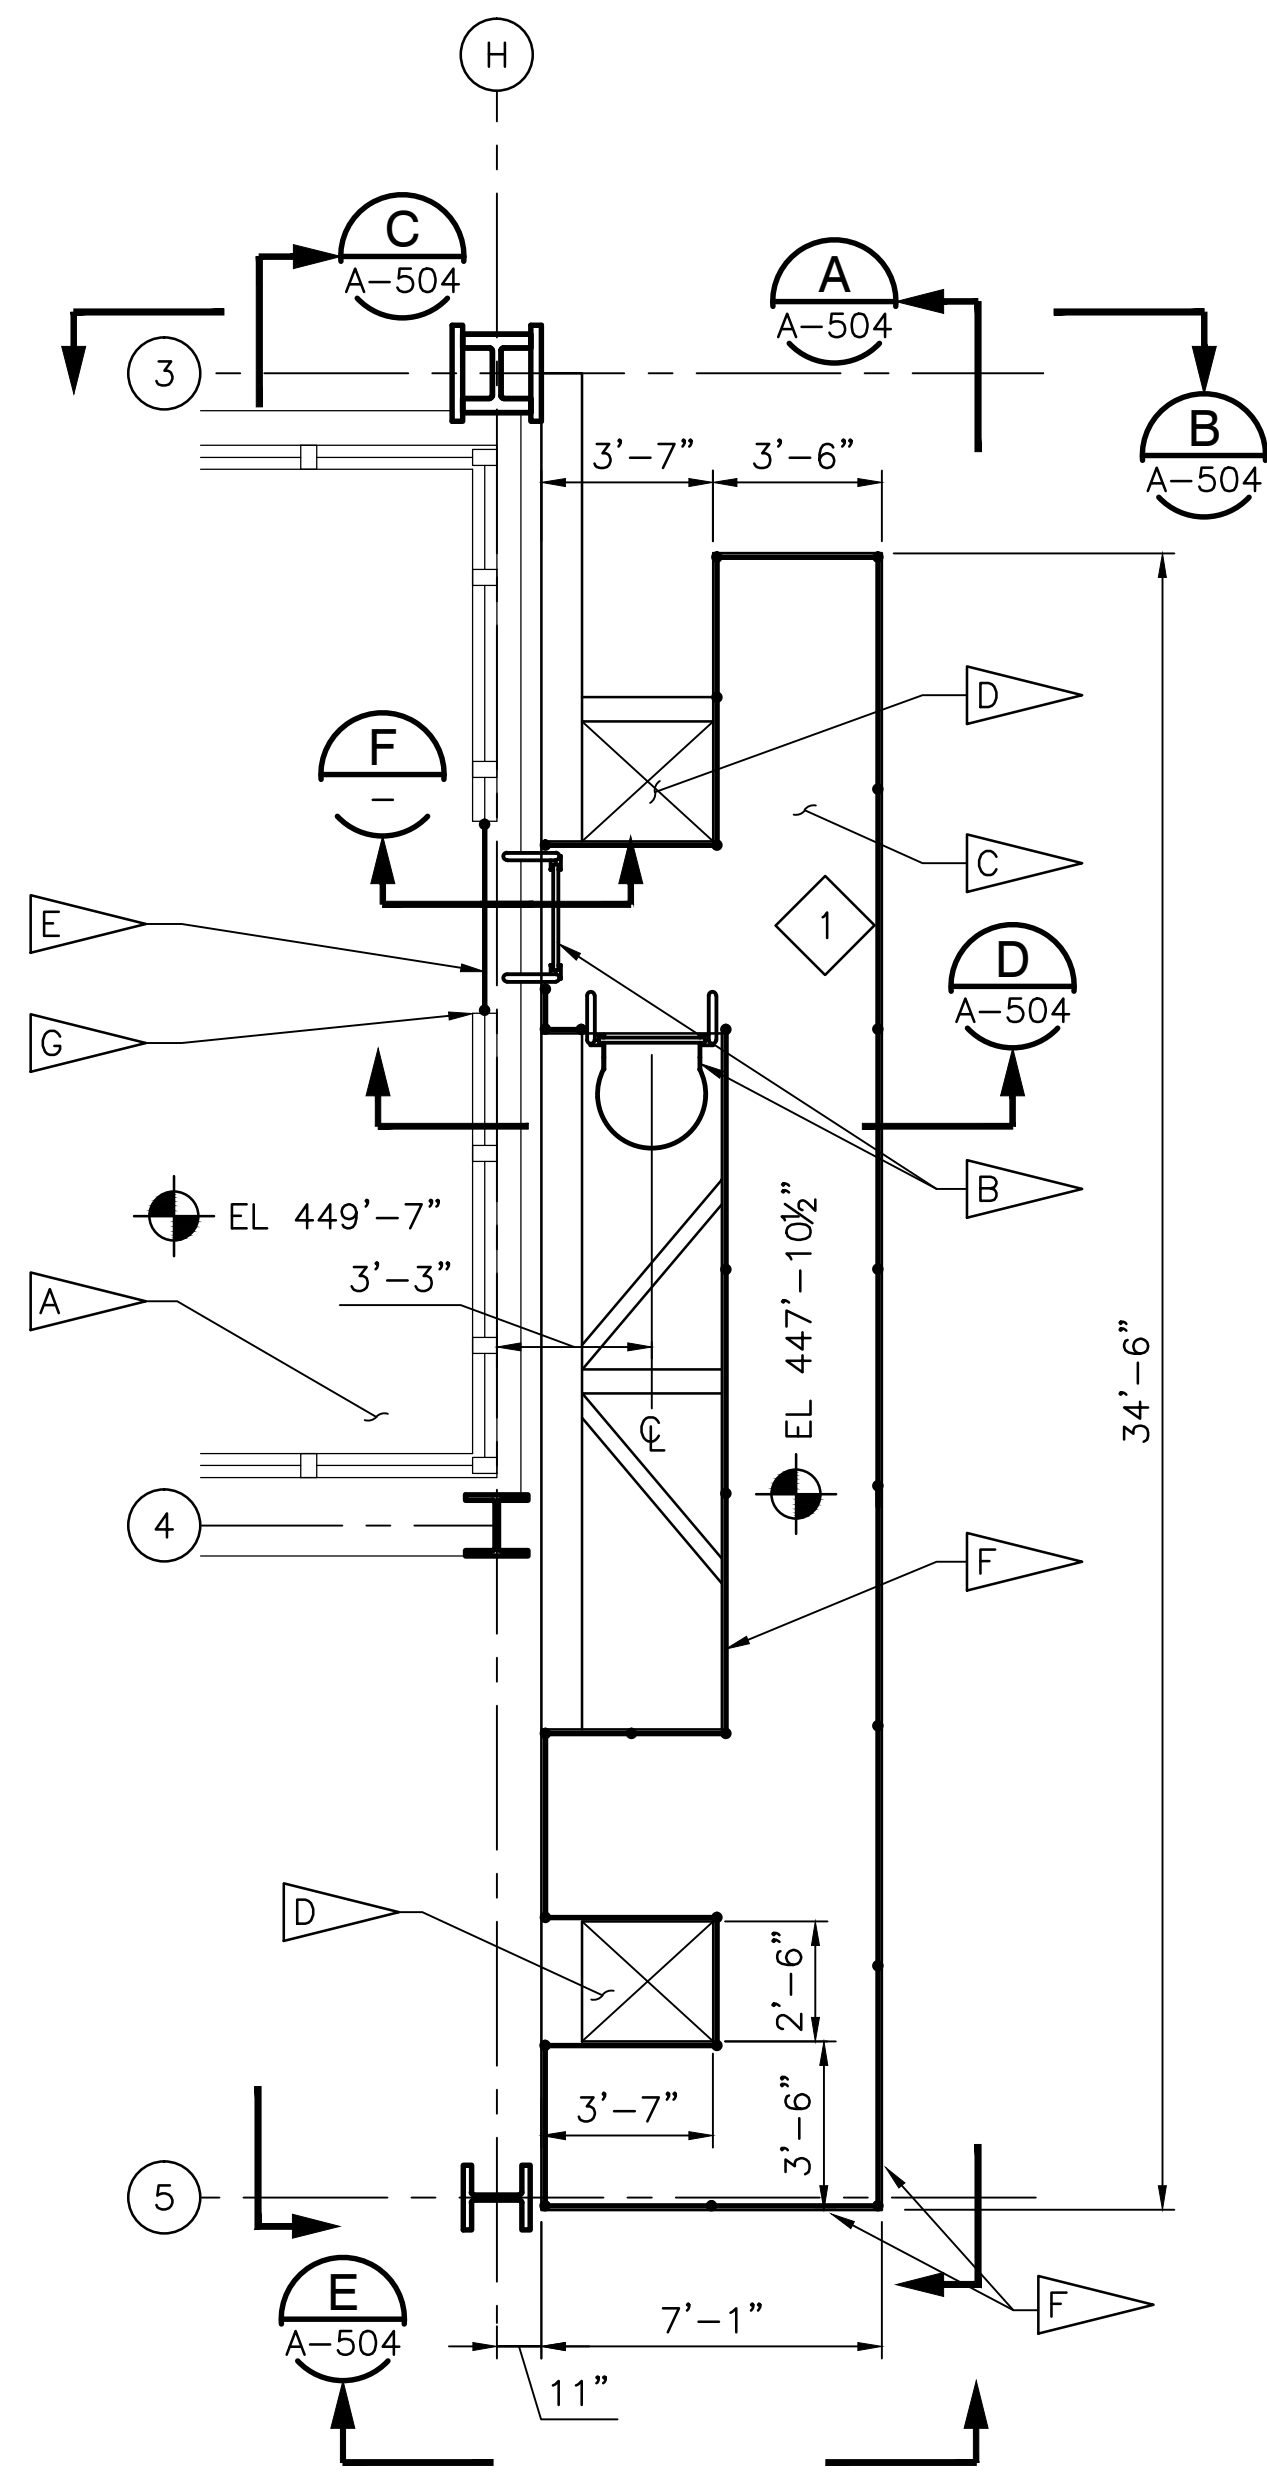


LEVEL 36
SERVICE PLATFORM PLAN - TOWER F @ COL LINE D (3)
SCALE: 1/4" = 1'-0"

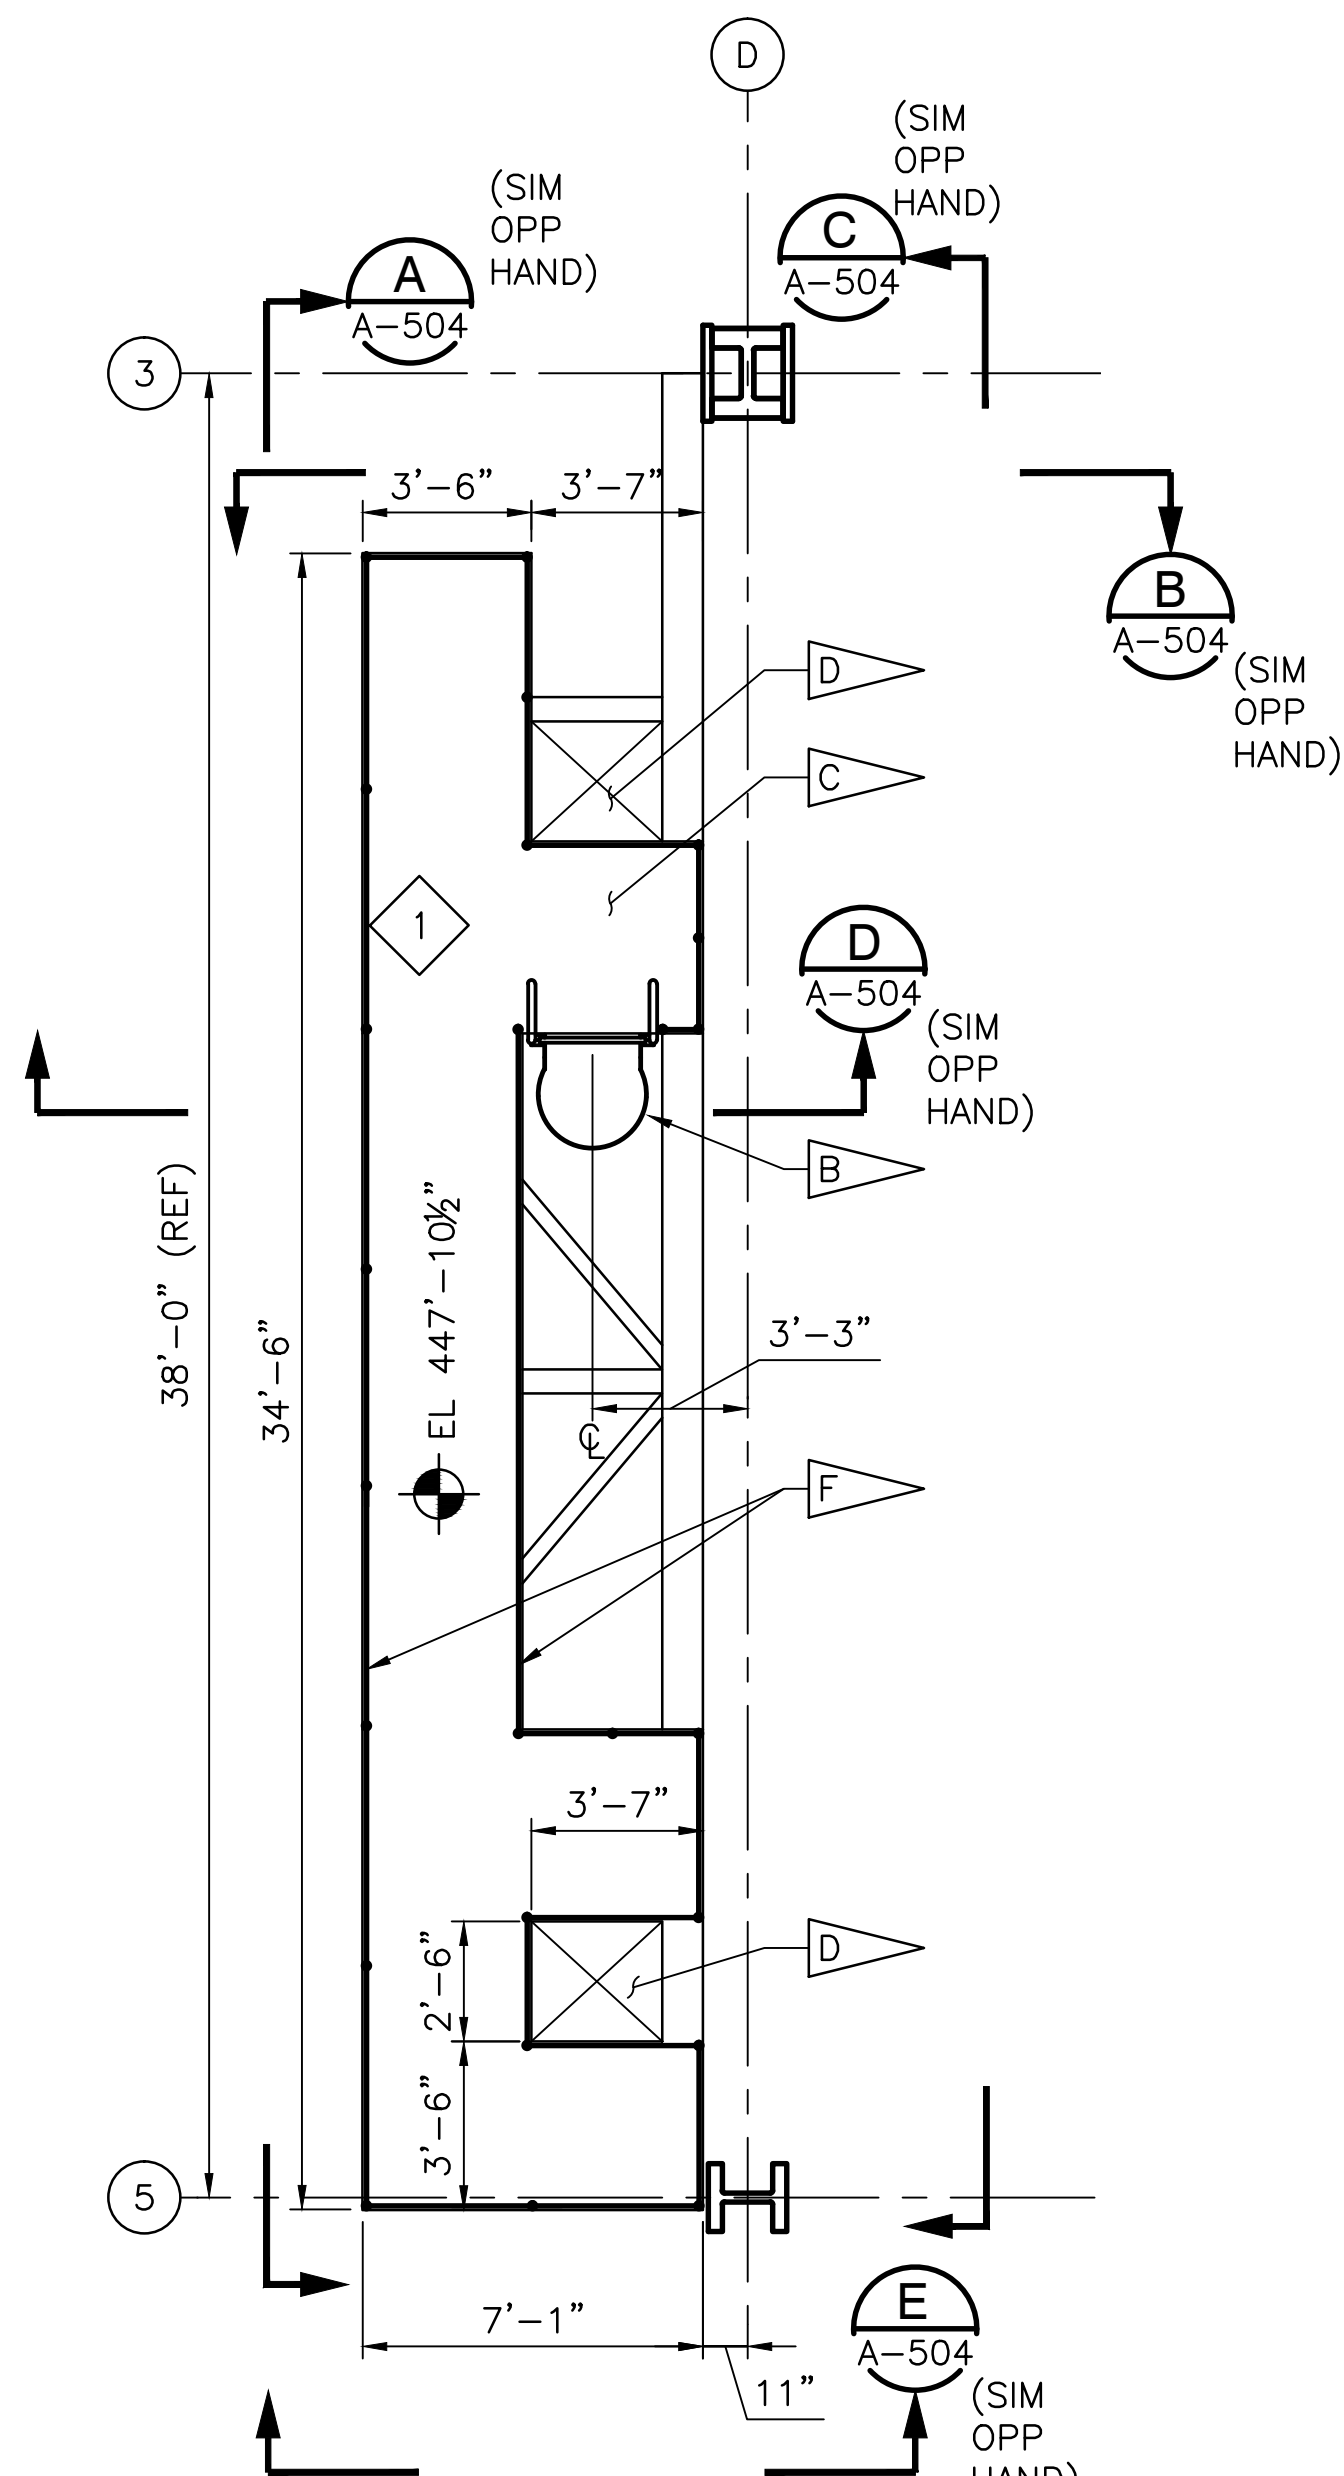


LEVEL 36
SERVICE PLATFORM PLAN - TOWER E @ COL LINE H (2)
SCALE: 1/4" = 1'-0"

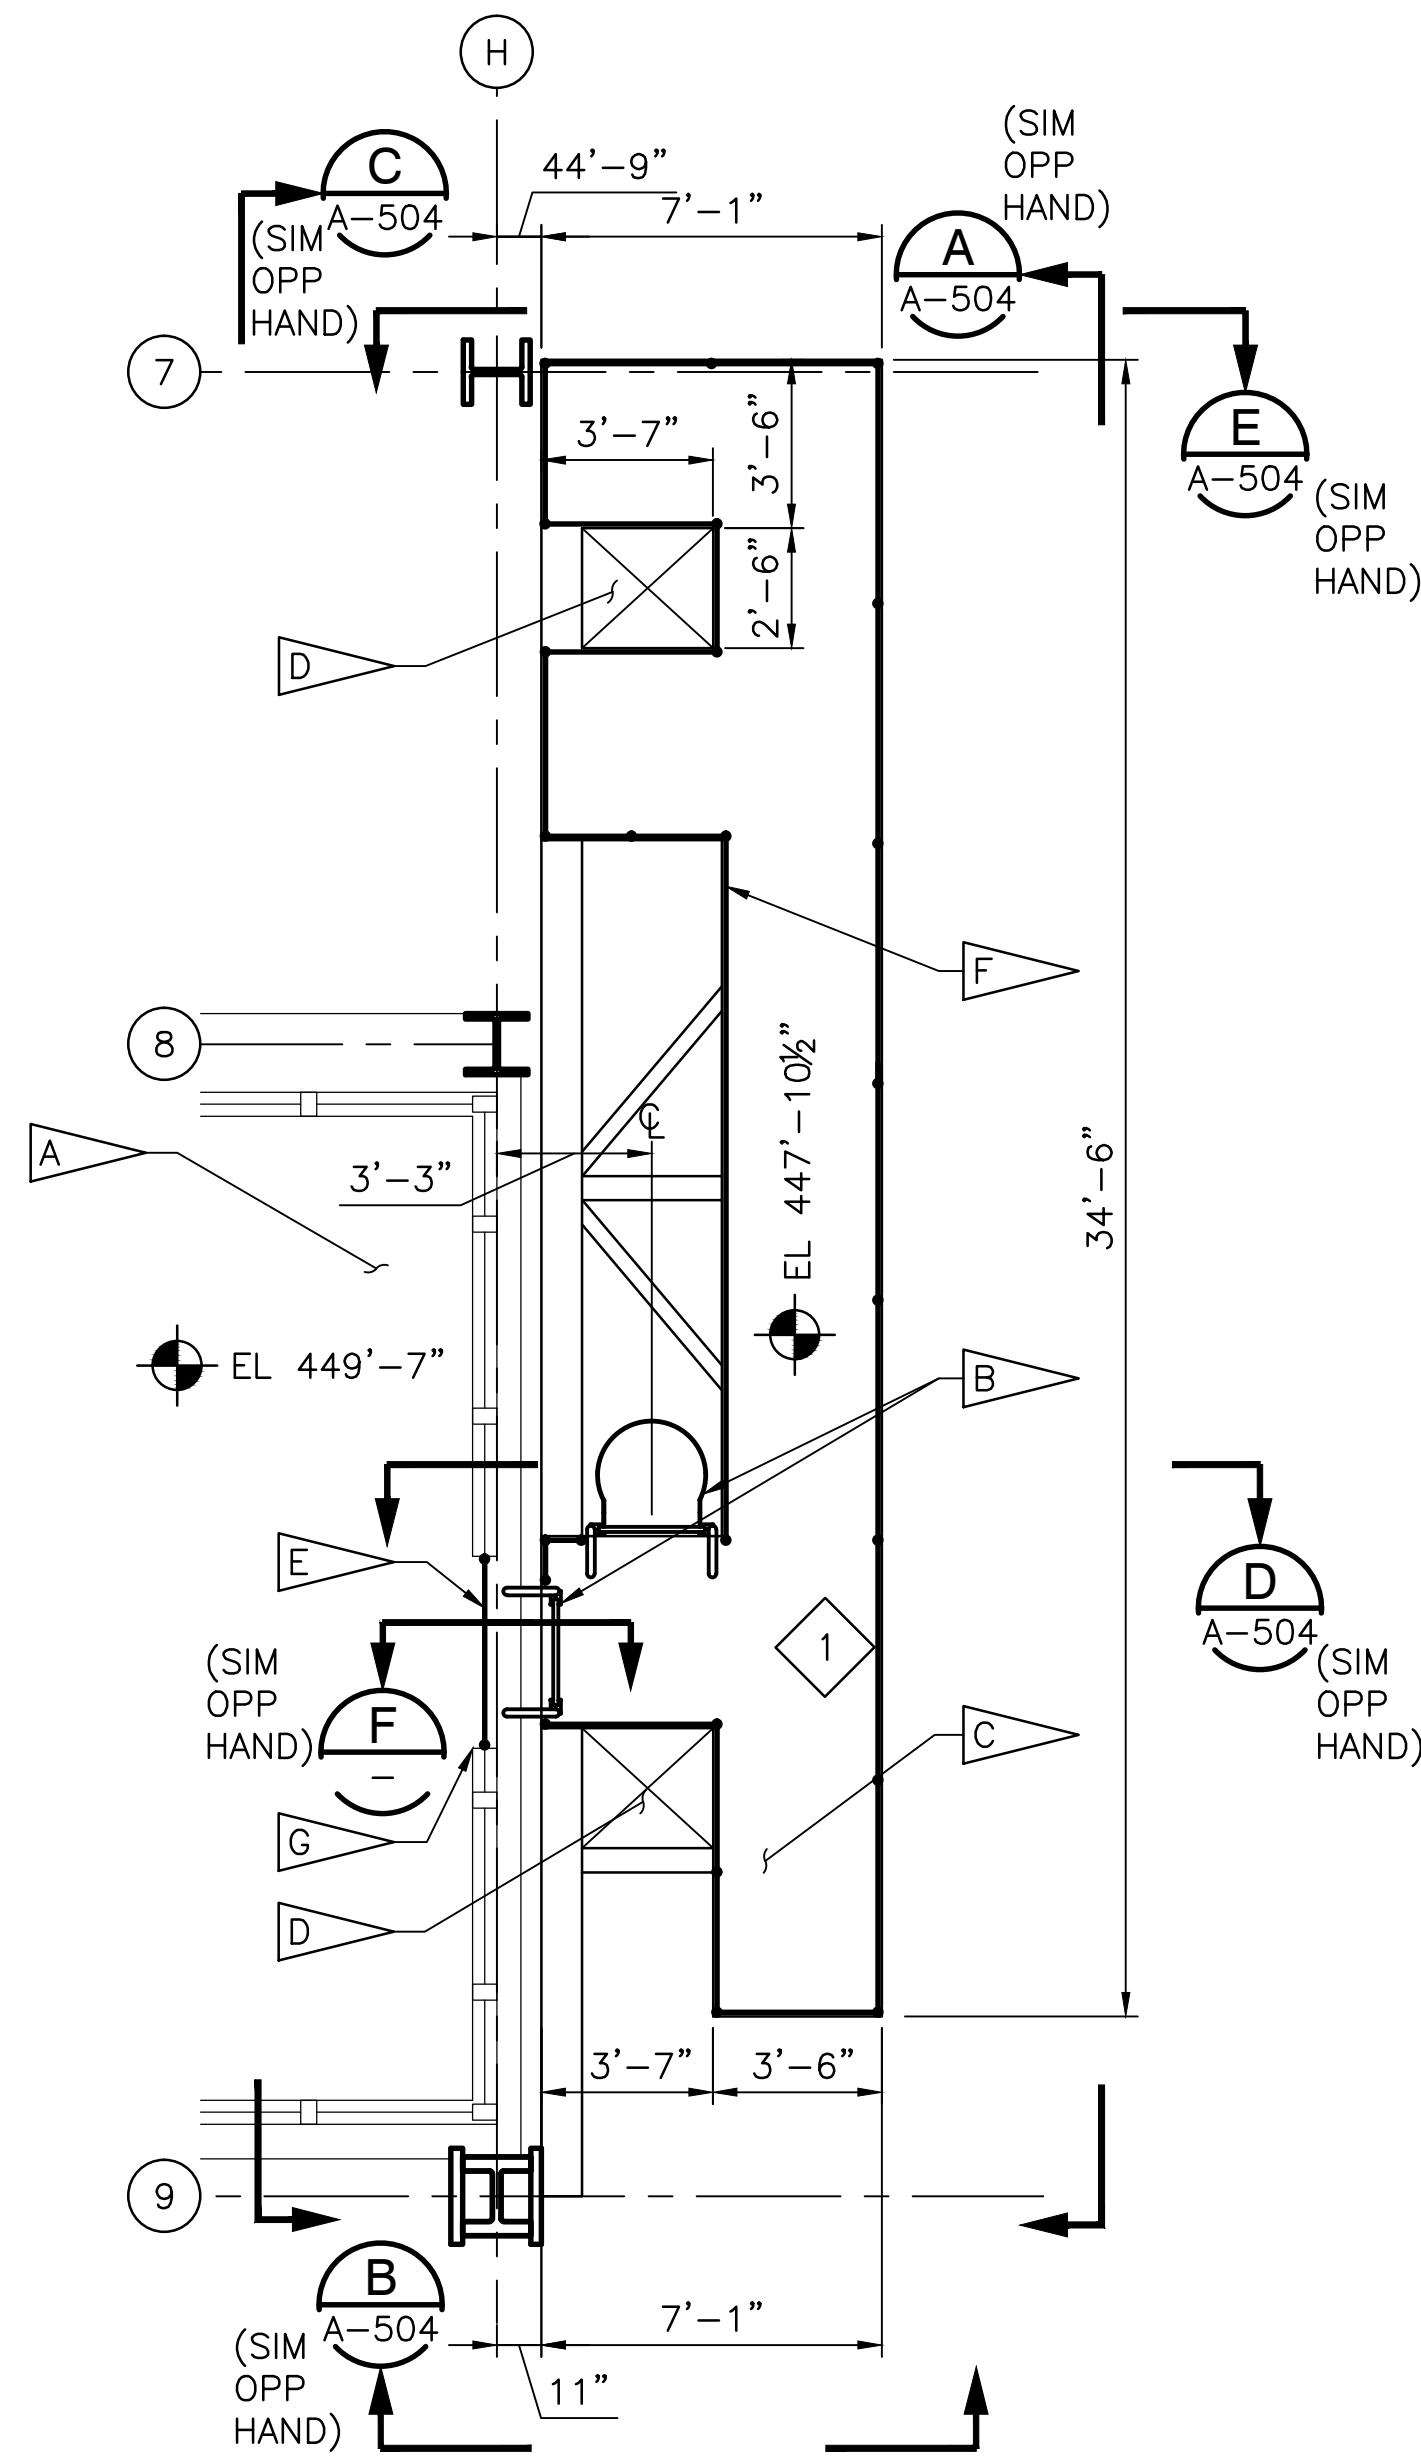


LEVEL 36
SERVICE PLATFORM PLAN - TOWER E @ COL LINE D (4)
SCALE: 1/4" = 1'-0"

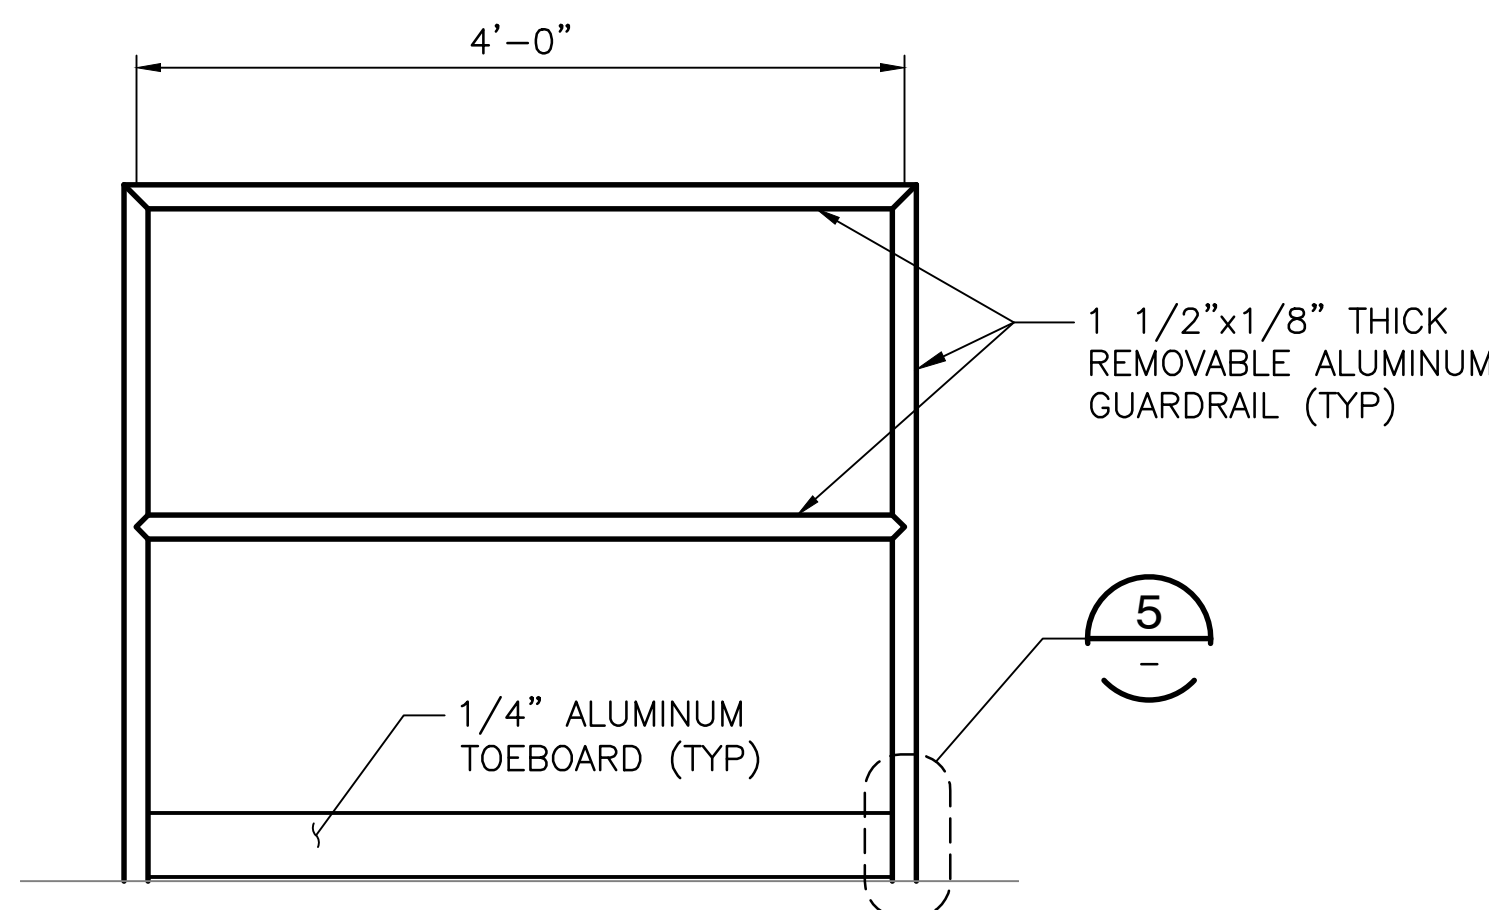


REMOVABLE GUARDRAIL (A)
SCALE: 1" = 1'-0"

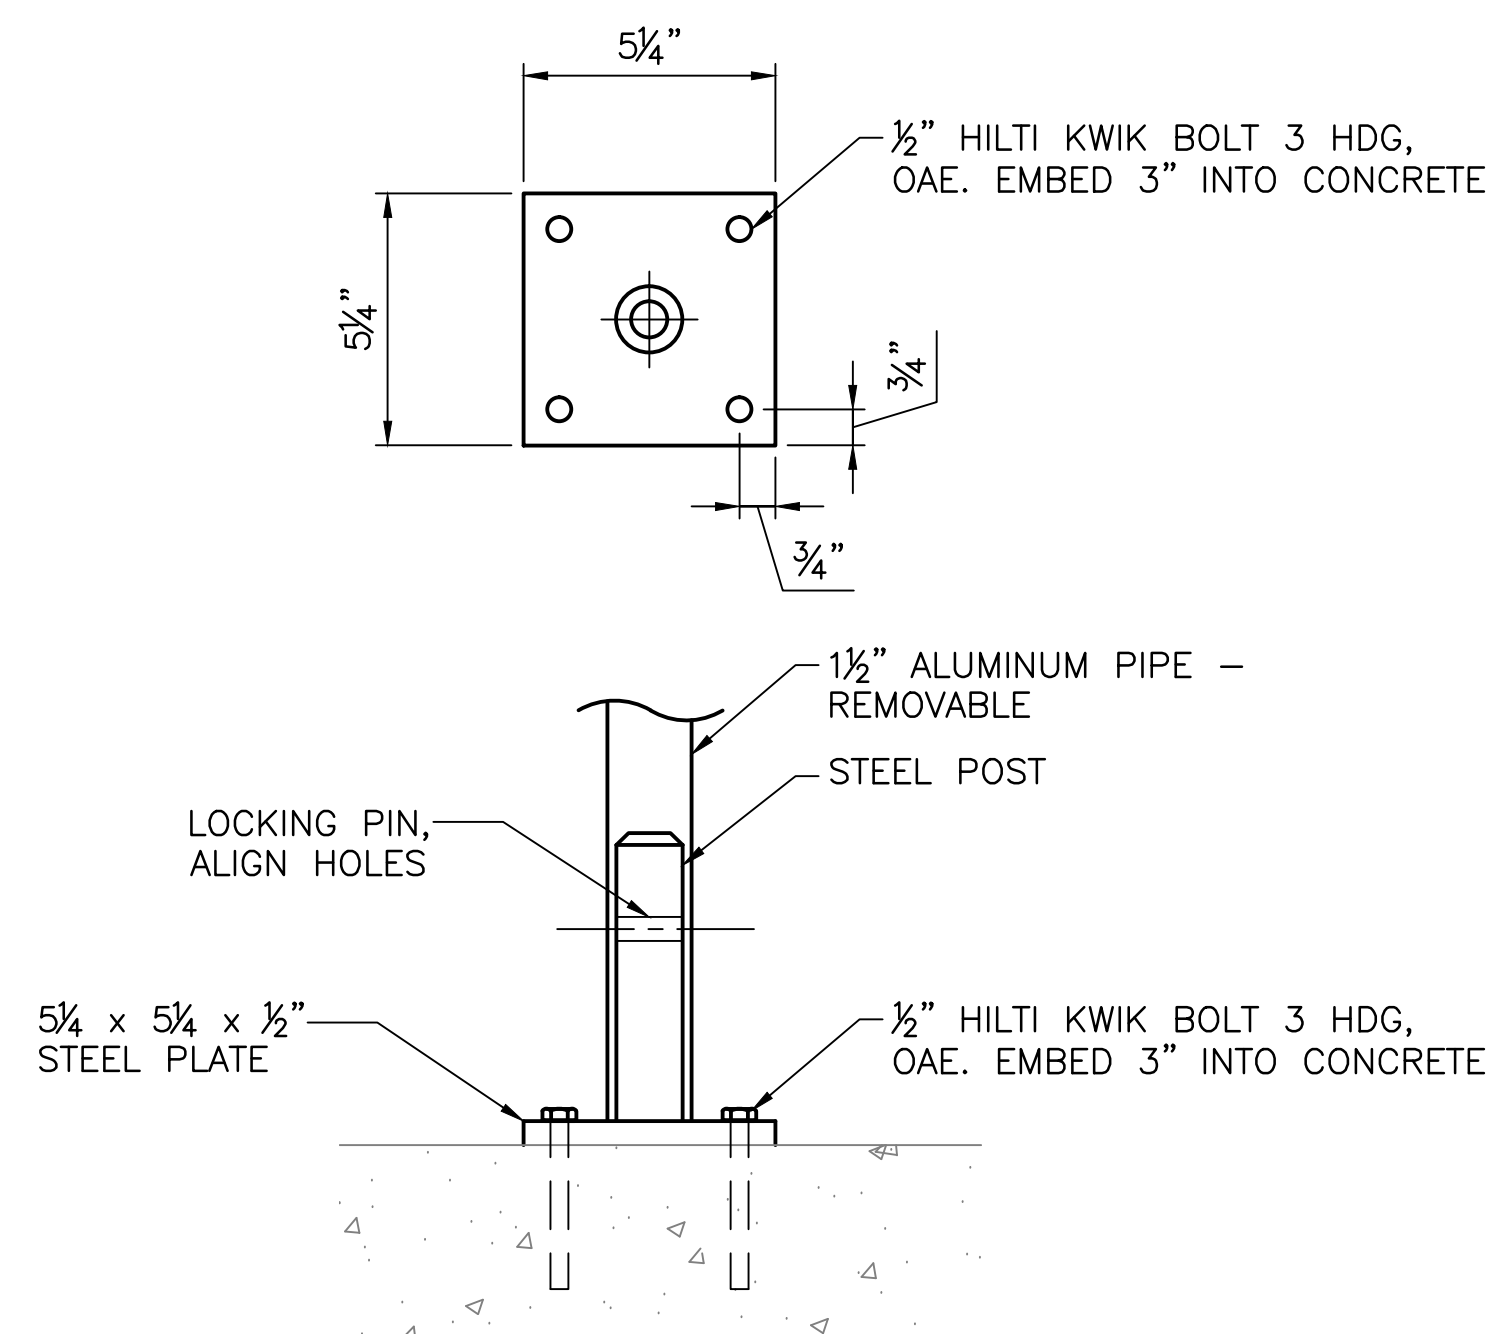


REMOVABLE GUARDRAIL (5)
SCALE: 3" = 1'-0"

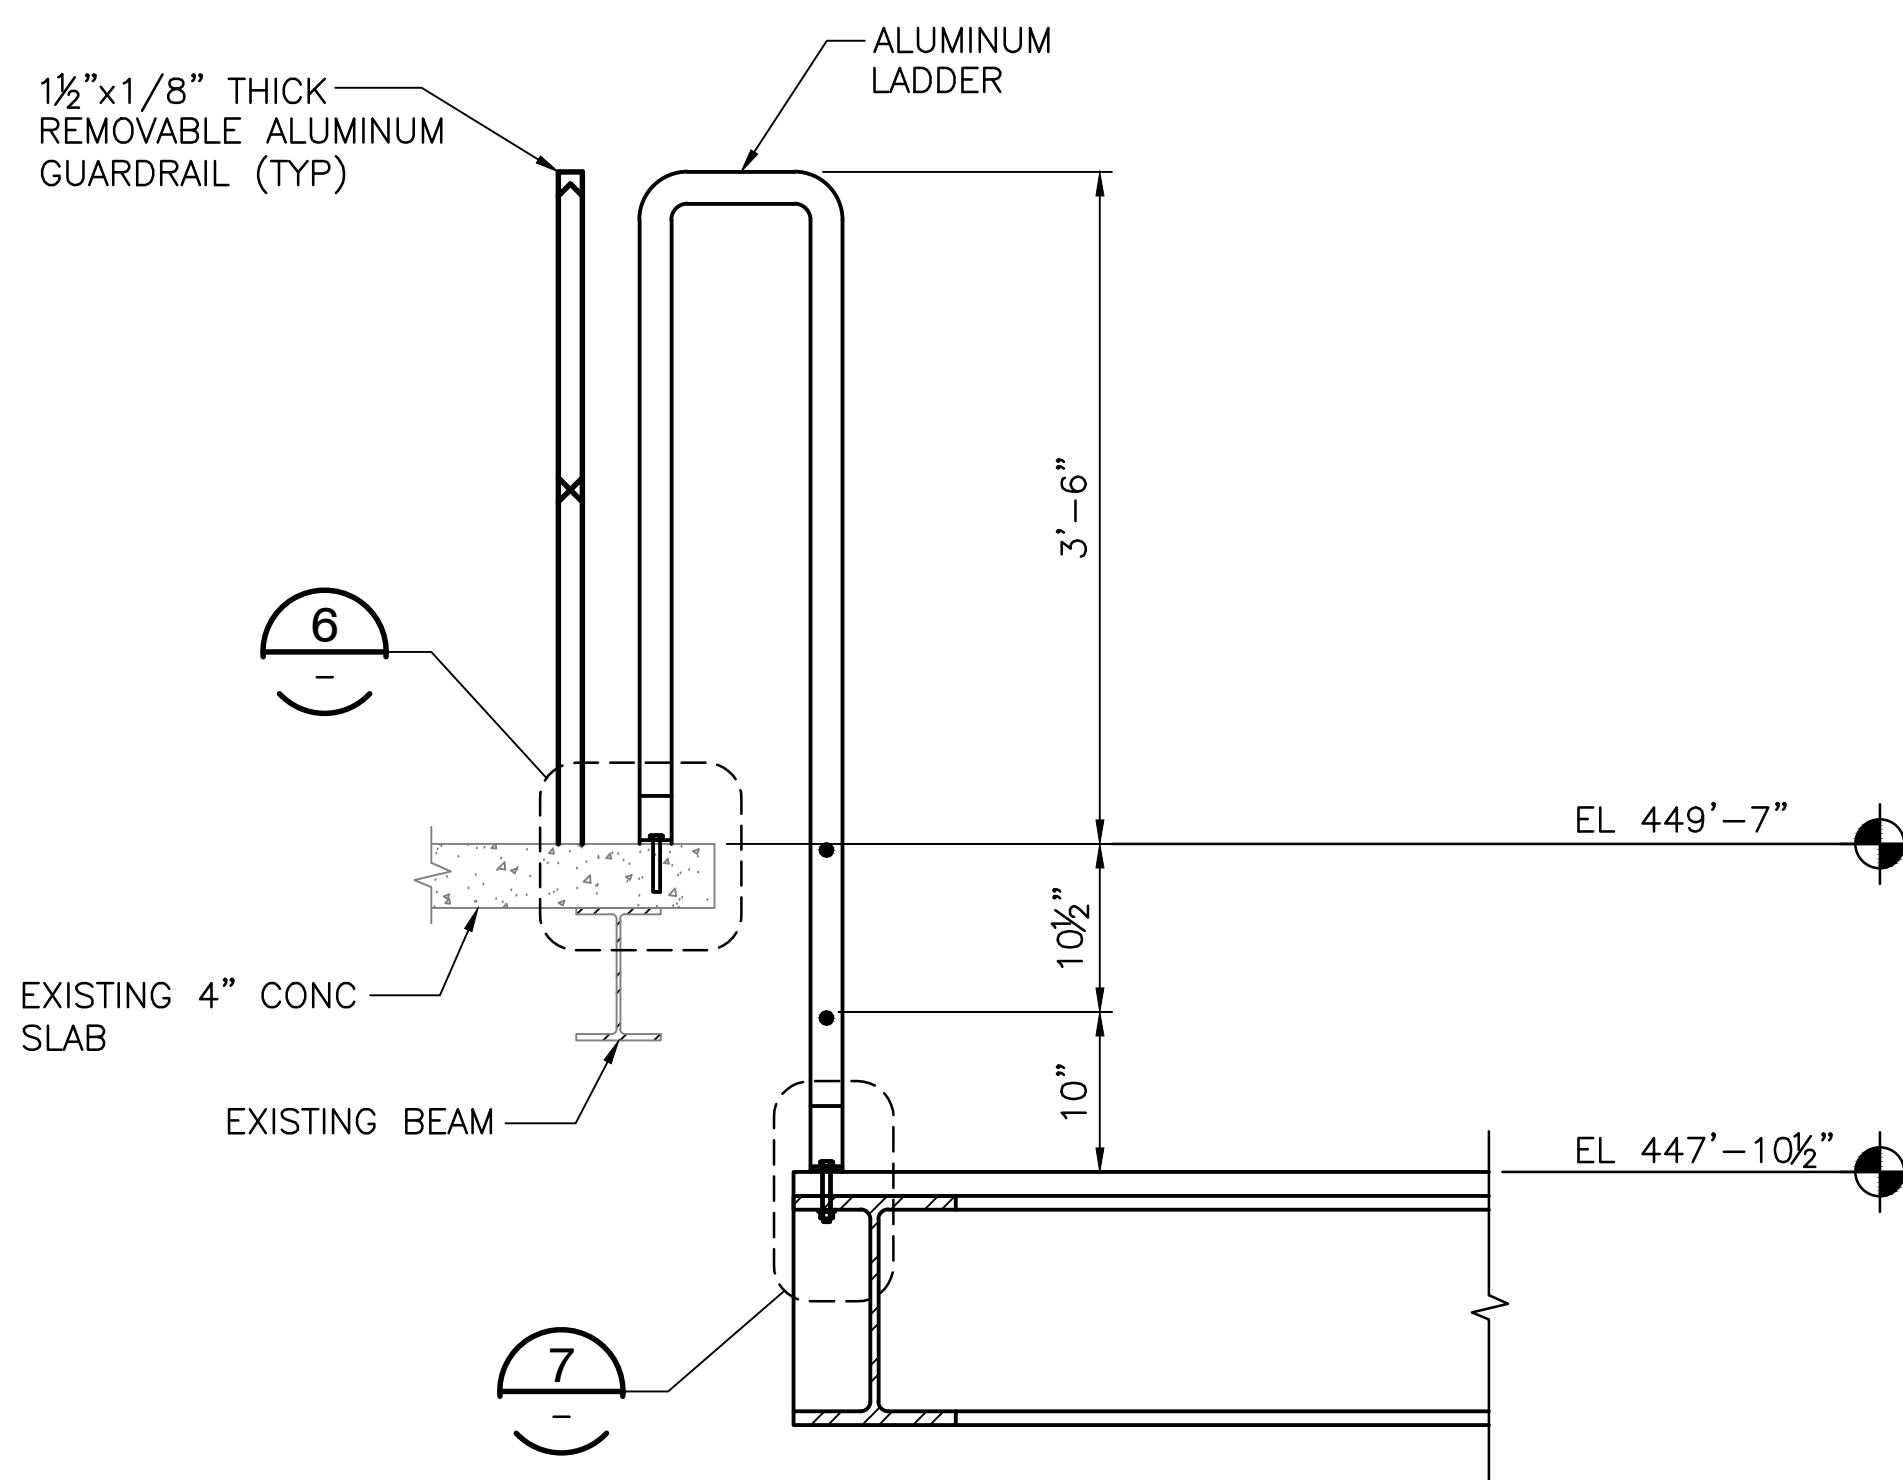


LADDER @ SERVICE PLATFORM (F)
SCALE: 1" = 1'-0"

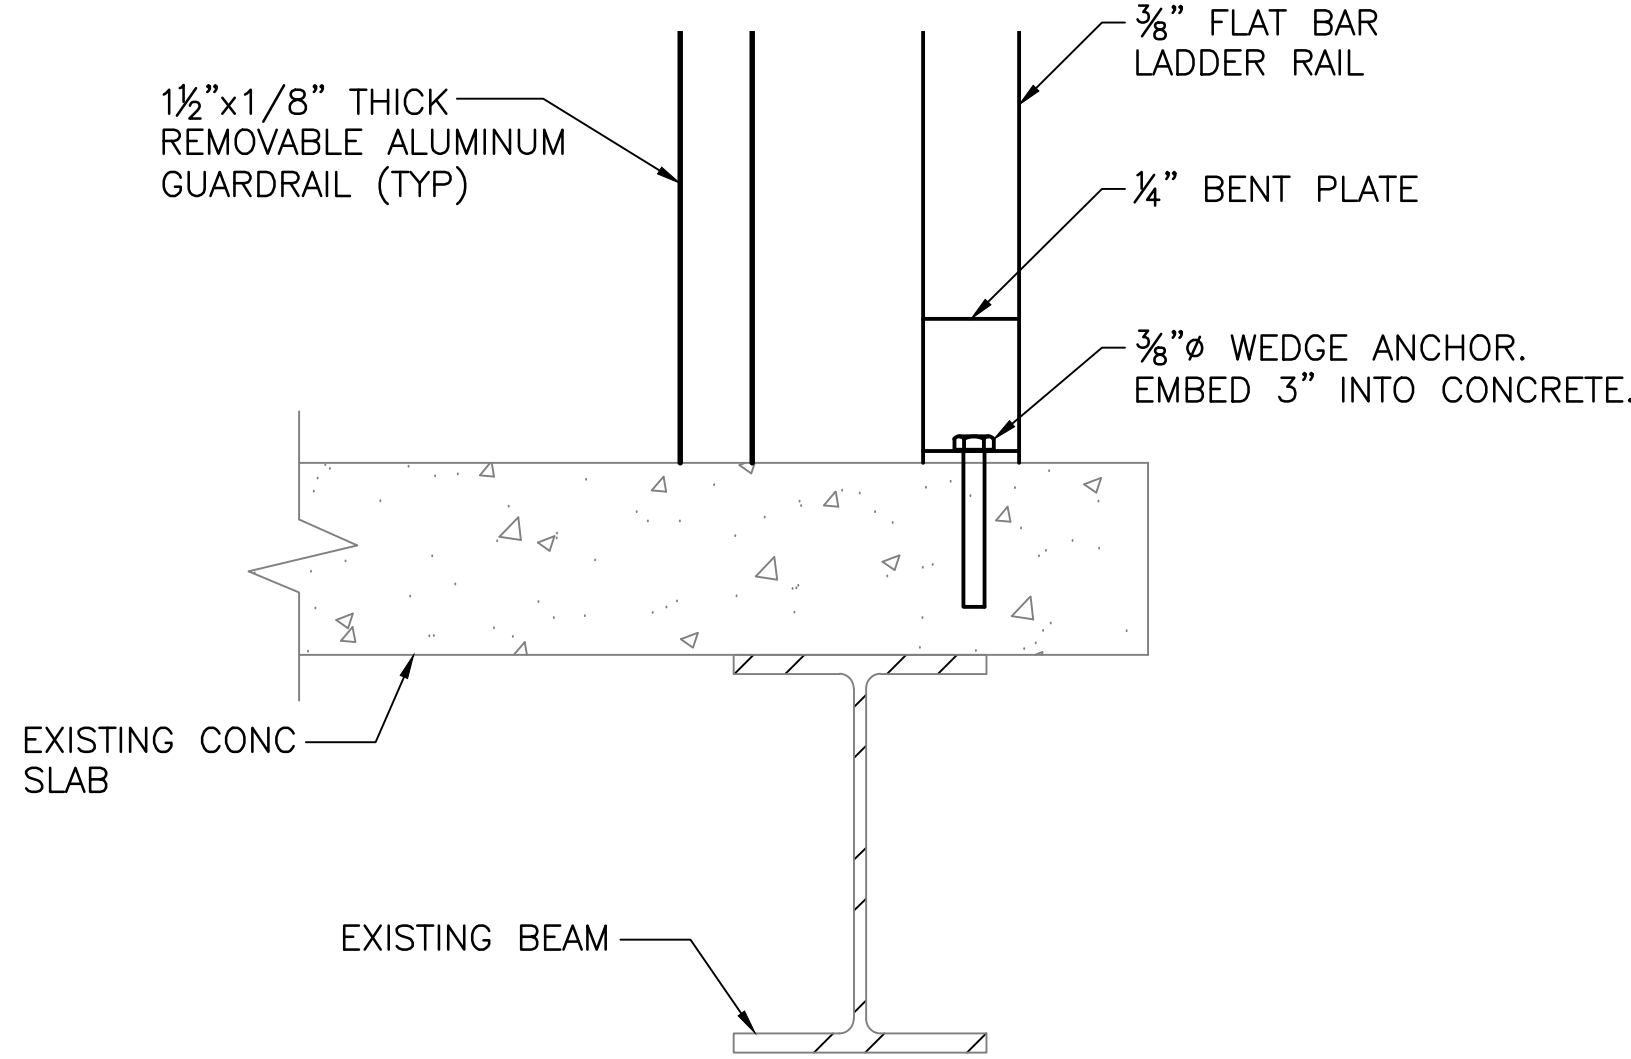

LADDER CONNECTION @ CONC SLAB (6)
SCALE: 3" = 1'-0"

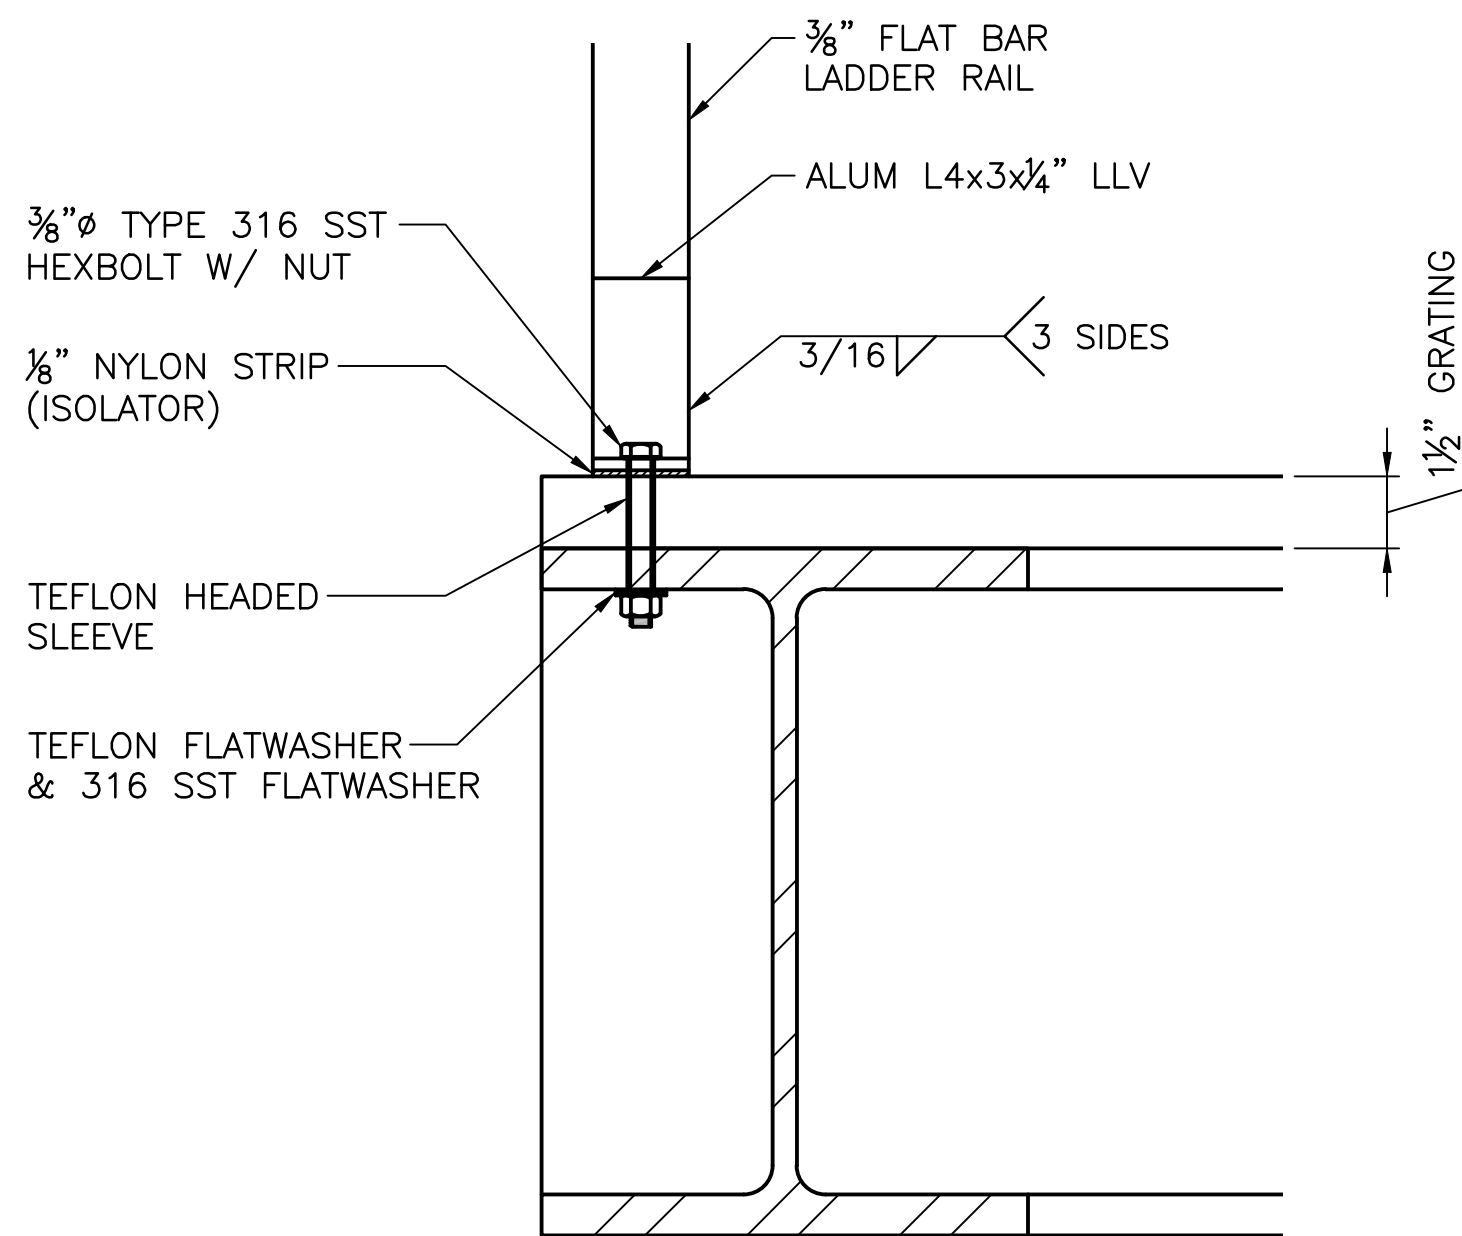

LADDER CONNECTION @ STEEL BEAM (7)
SCALE: 3" = 1'-0"

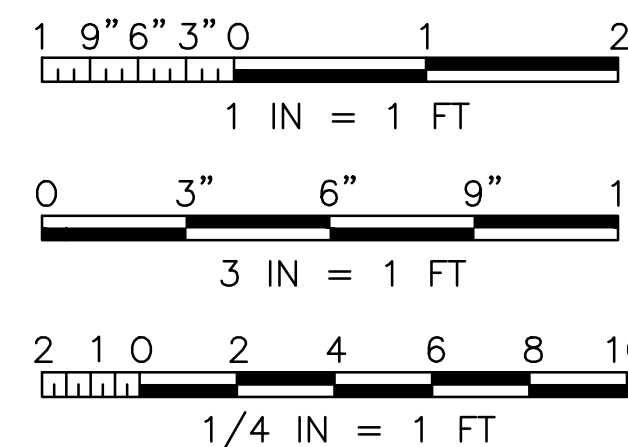


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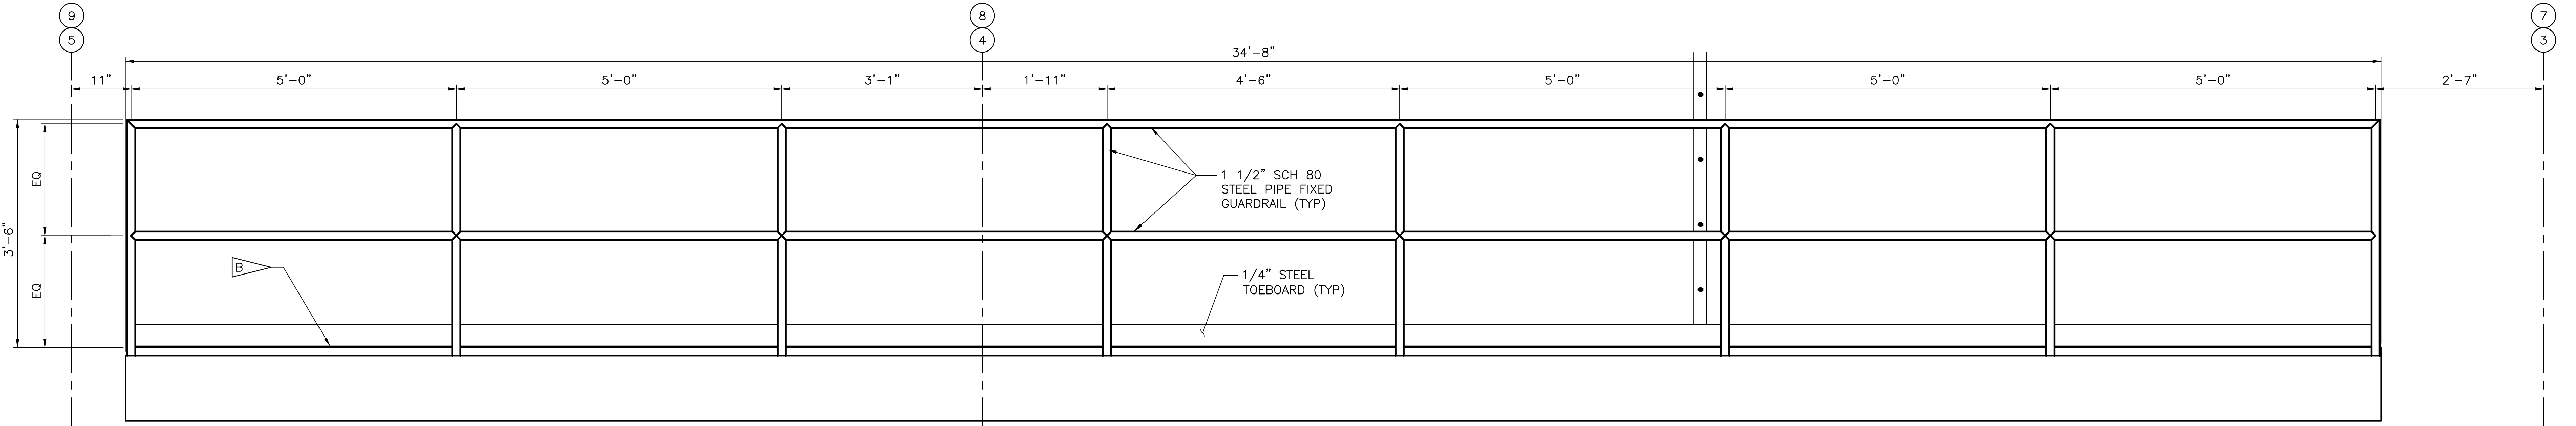
A-501

SYM	ZONE	DESCRIPTION	DATE	APPROVAL
REVISIONS				
SIGNATURES				
DRAWN: BRIAN CURTIS	DATE: 08-20-2013	NATIONAL AERONAUTICS AND SPACE ADMINISTRATION		
CHECKED: ALICE SCHULTZ	DATE: 08-20-2013	JOHN F. KENNEDY SPACE CENTER, NASA		
APPROVED: ANTHONY MAZZA	DATE: 08-20-2013	KENNEDY SPACE CENTER, FLORIDA		
ST. OF LICENSURE: FL		LAUNCH COMPLEX 39		
LICENSE NO:		VEHICLE ASSEMBLY BUILDING		
APPROVED: JOHN KERSHAW		MODIFY VEHICLE ASSEMBLY BUILDING		
MIKE HARNETT		HIGH BAY 3 FOR SLS - HOISTS		
		ENLARGED PLATFORM PLANS,		
		LEVEL 36		
FILE NO: 302-6058-043	SIZE: E	TOWNSHIP NO: 79K39667	REV: 1	
PROJ. NO. PCN 99000.5	SHEET 10	OF 10		


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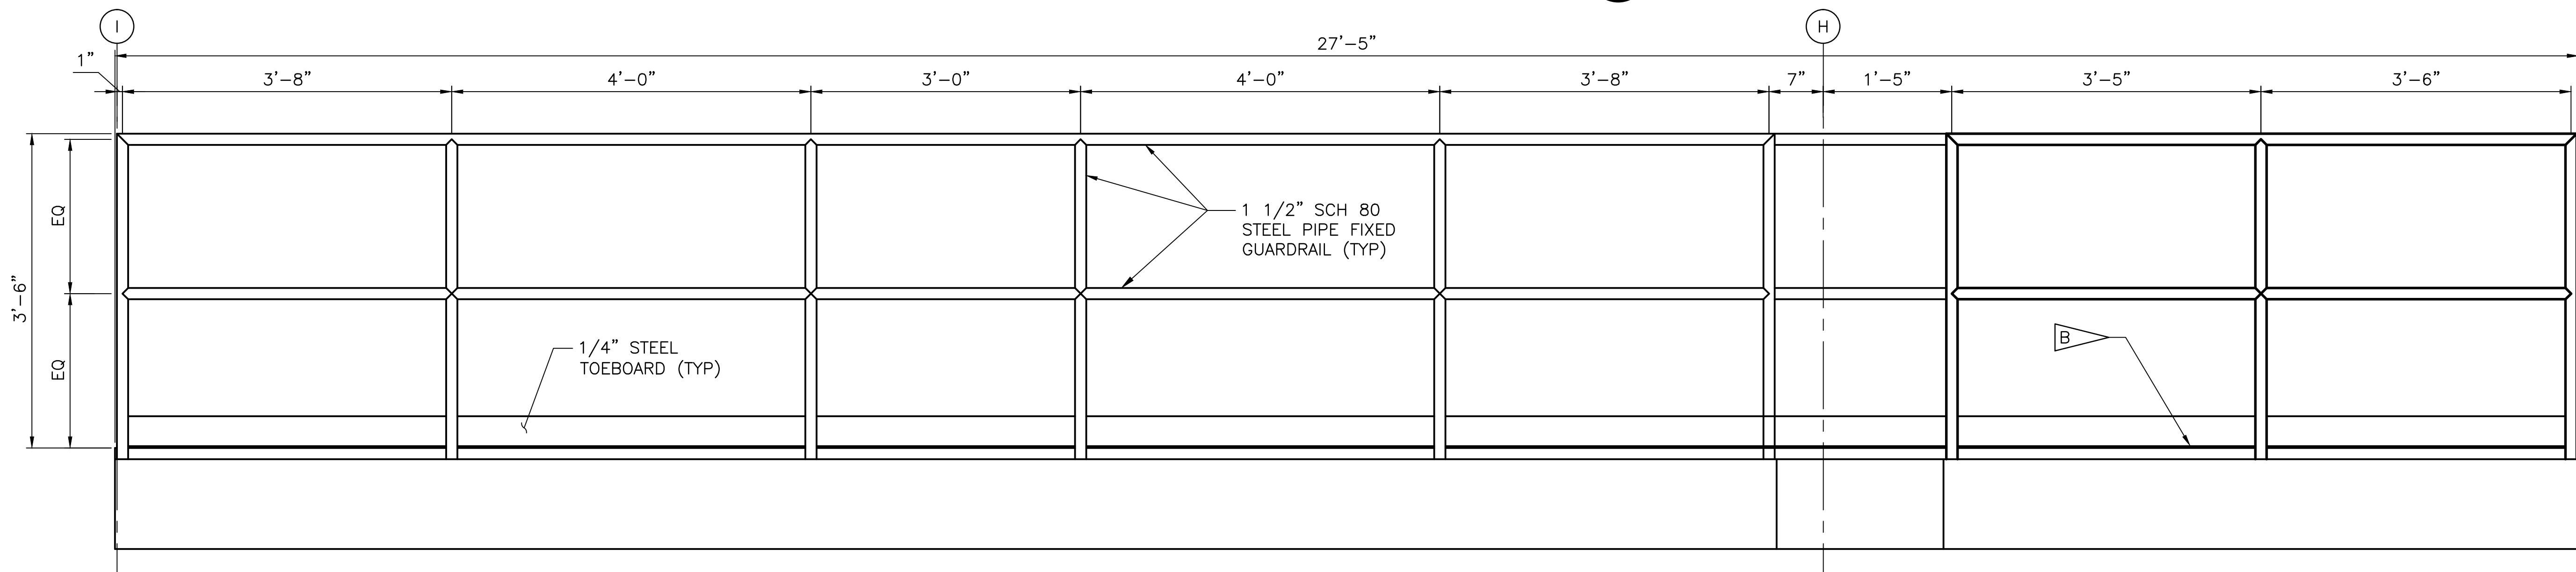
GUARDRAIL AT ELEVATOR LANDING PLATFORM **B**
SCALE: 1" = 1'-0"

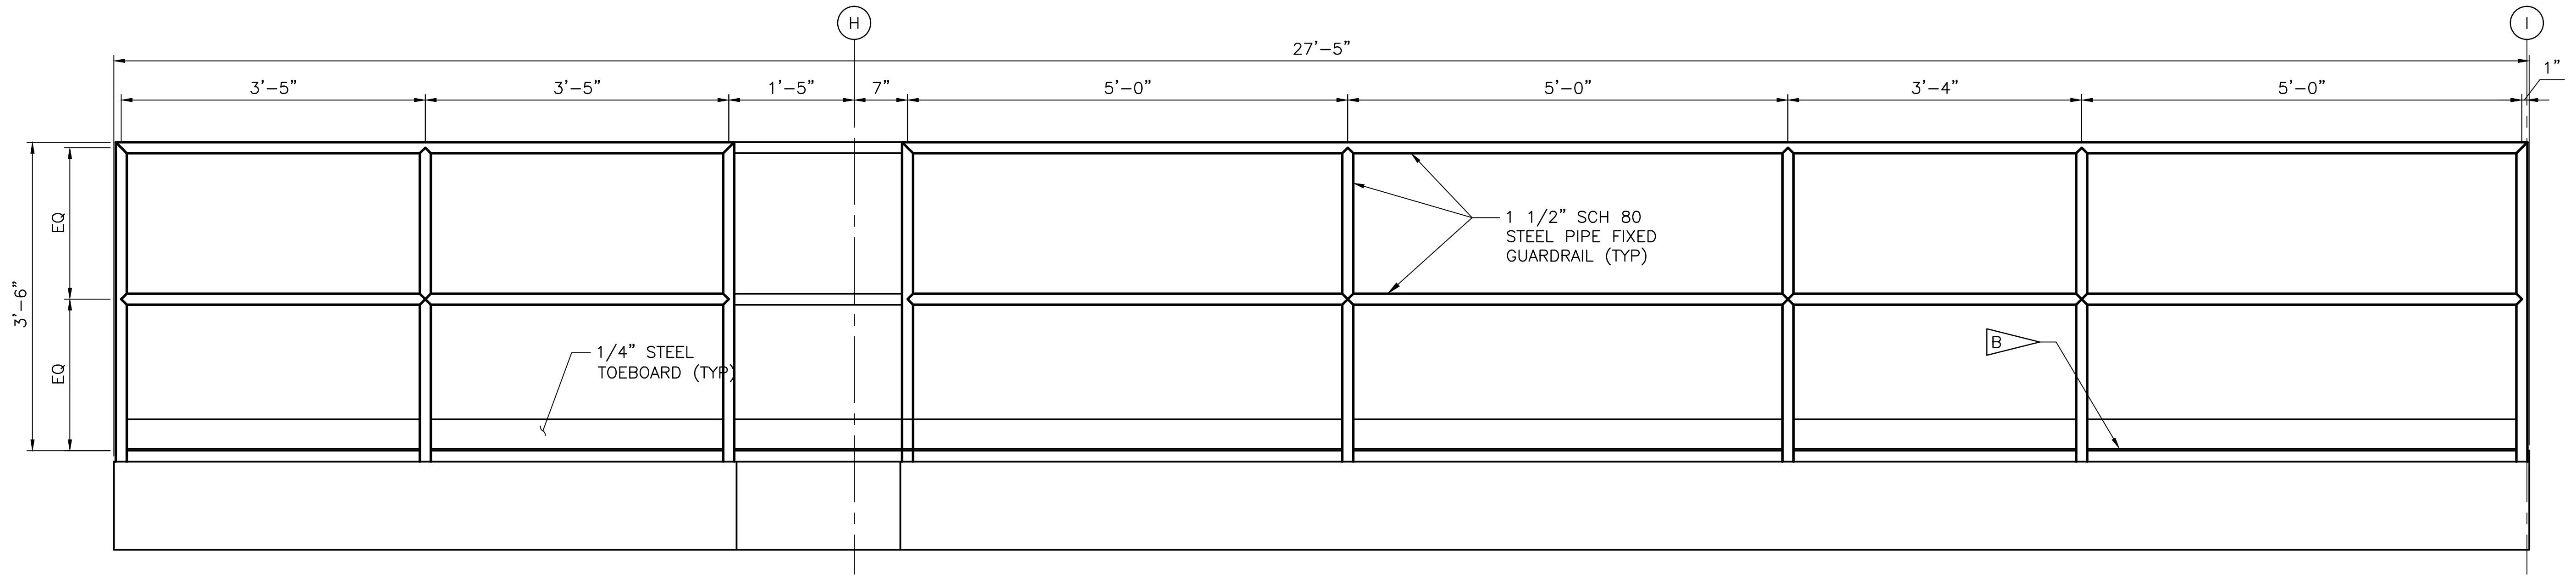

GUARDRAIL AT ELEVATOR LANDING PLATFORM **A**
SCALE: 1" = 1'-0"



GUARDRAIL AT ELEVATOR LANDING PLATFORM **C**
SCALE: 1" = 1'-0"

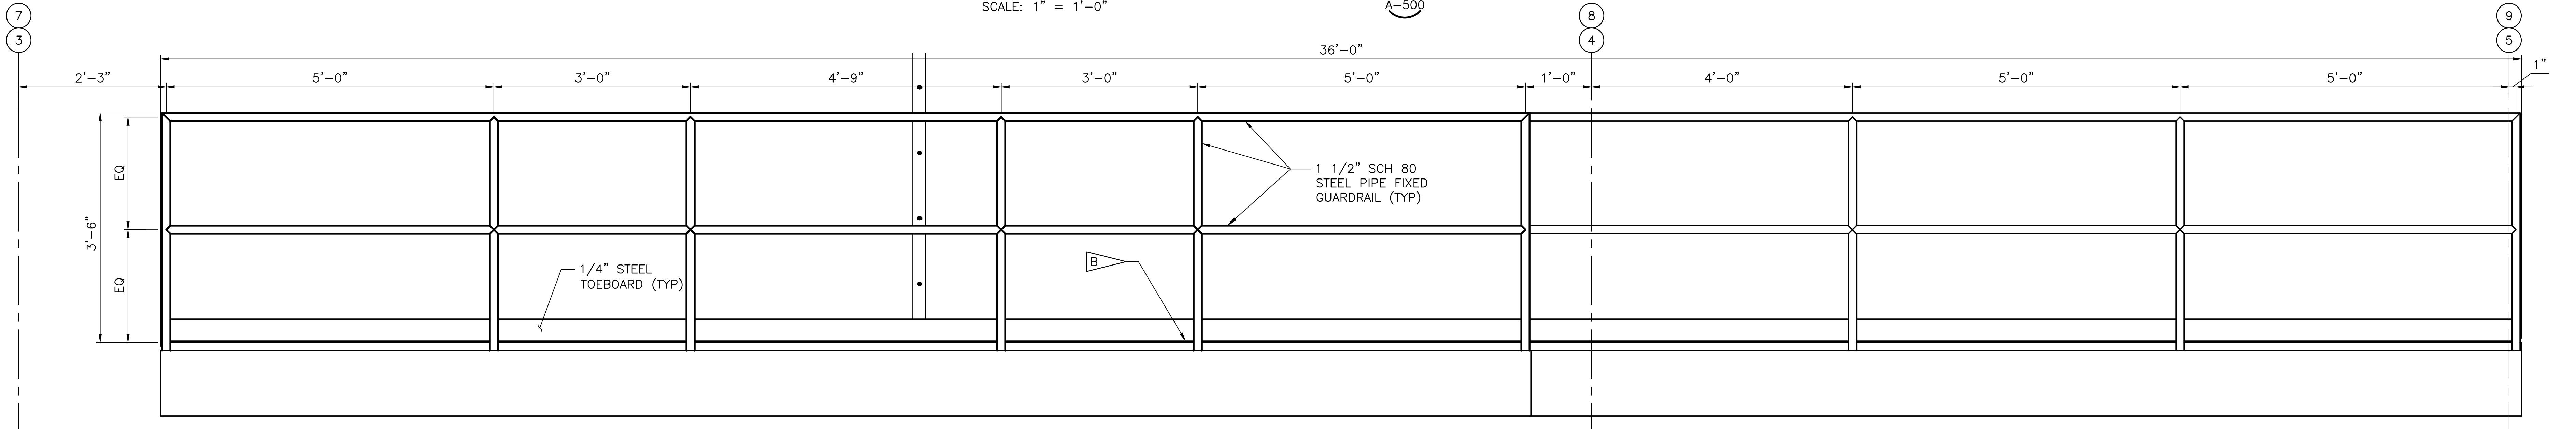

GUARDRAIL AT ELEVATOR LANDING PLATFORM **D**
SCALE: 1" = 1'-0"


SPECIFIC NOTES:

- A. SEE DETAIL A/A-503 FOR GUARDRAIL DETAILS.
B. STEEL DECK PLATES, SEE SHEETS S-401 AND S-402.


1 9" 6" 3" 0 1 2
1 IN = 1 FT

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FILED UNDER THE DRAWING NUMBER


A-502

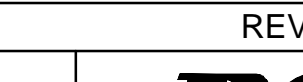SYM	ZONE	DESCRIPTION		DATE	APPROVAL
REVISIONS					
SIGNATURES		DATE	<div></div> <div>Reynolds, Smith and Hills, Inc. 115 Alma Blvd, Suite 101 Merritt Island, Florida 32953-4101 (321) 453-0212 (321) 453-0223 FAX www.rsandh.com</div> <div>NATIONAL AERONAUTICS AND SPACE ADMINISTRATION JOHN F. KENNEDY SPACE CENTER, NASA KENNEDY SPACE CENTER, FLORIDA</div> <div>LAUNCH COMPLEX 39 VEHICLE ASSEMBLY BUILDING</div> <div>MODIFY VEHICLE ASSEMBLY BUILDING HIGH BAY 3 FOR SLS – HOISTS GUARDRAIL ELEVATIONS AND DETAILS</div> <div>FILE NO. 302-6058-043</div> <div>SIZE E</div> <div>DWG. NO. 79K39667</div> <div>REV</div>		
DRAWN: BRIAN CURTIS	08-20-2013				
CHECKED: ALICE SCHULTZ	08-20-2013				
SUBMITTED ARCHIVING OF RECORD					
TONY MAZZA					
ST OF LICENSURE: FL					
LICENSE NO:					
APPROVED:					
JOHN KERSHAW					
MIKE HARTNETT					

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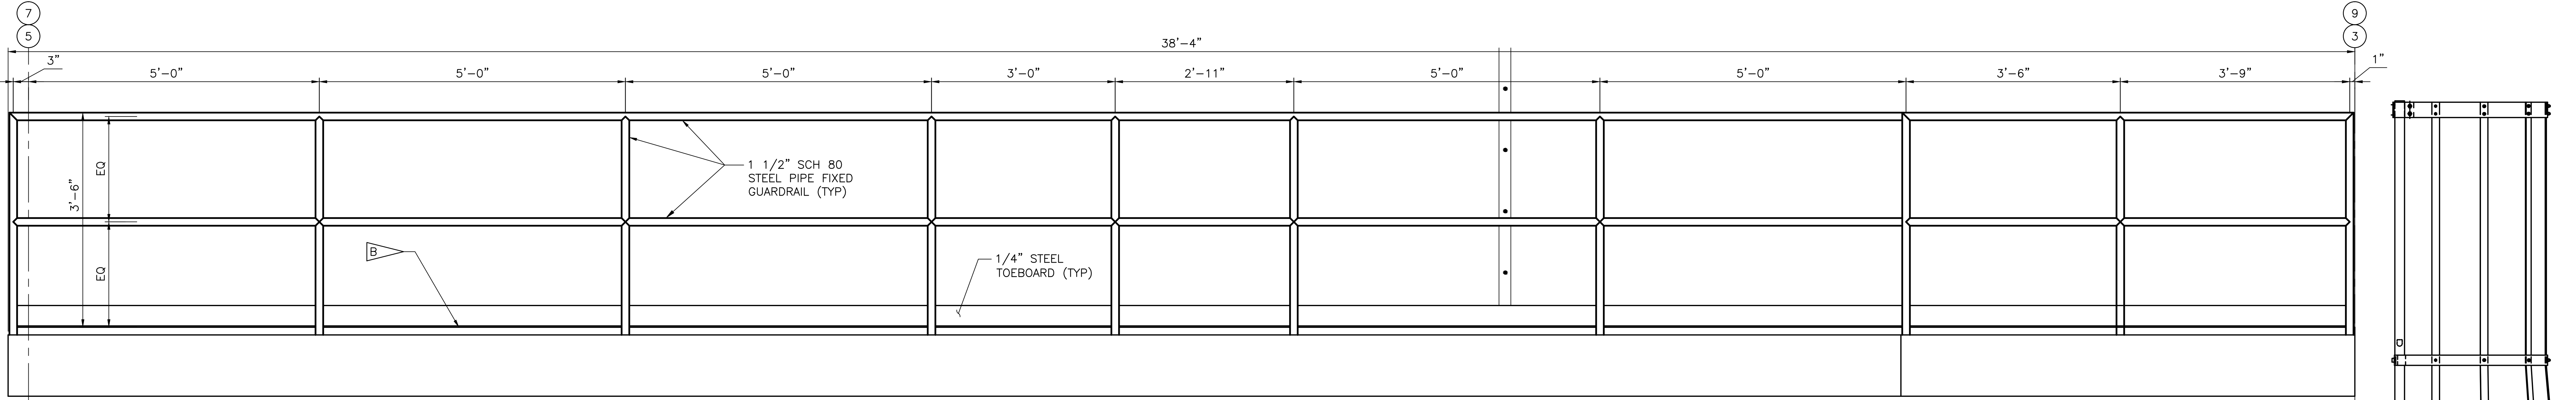
GUARDRAIL AT NEW SERVICE PLATFORM (F)
SCALE: 1" = 1'-0"

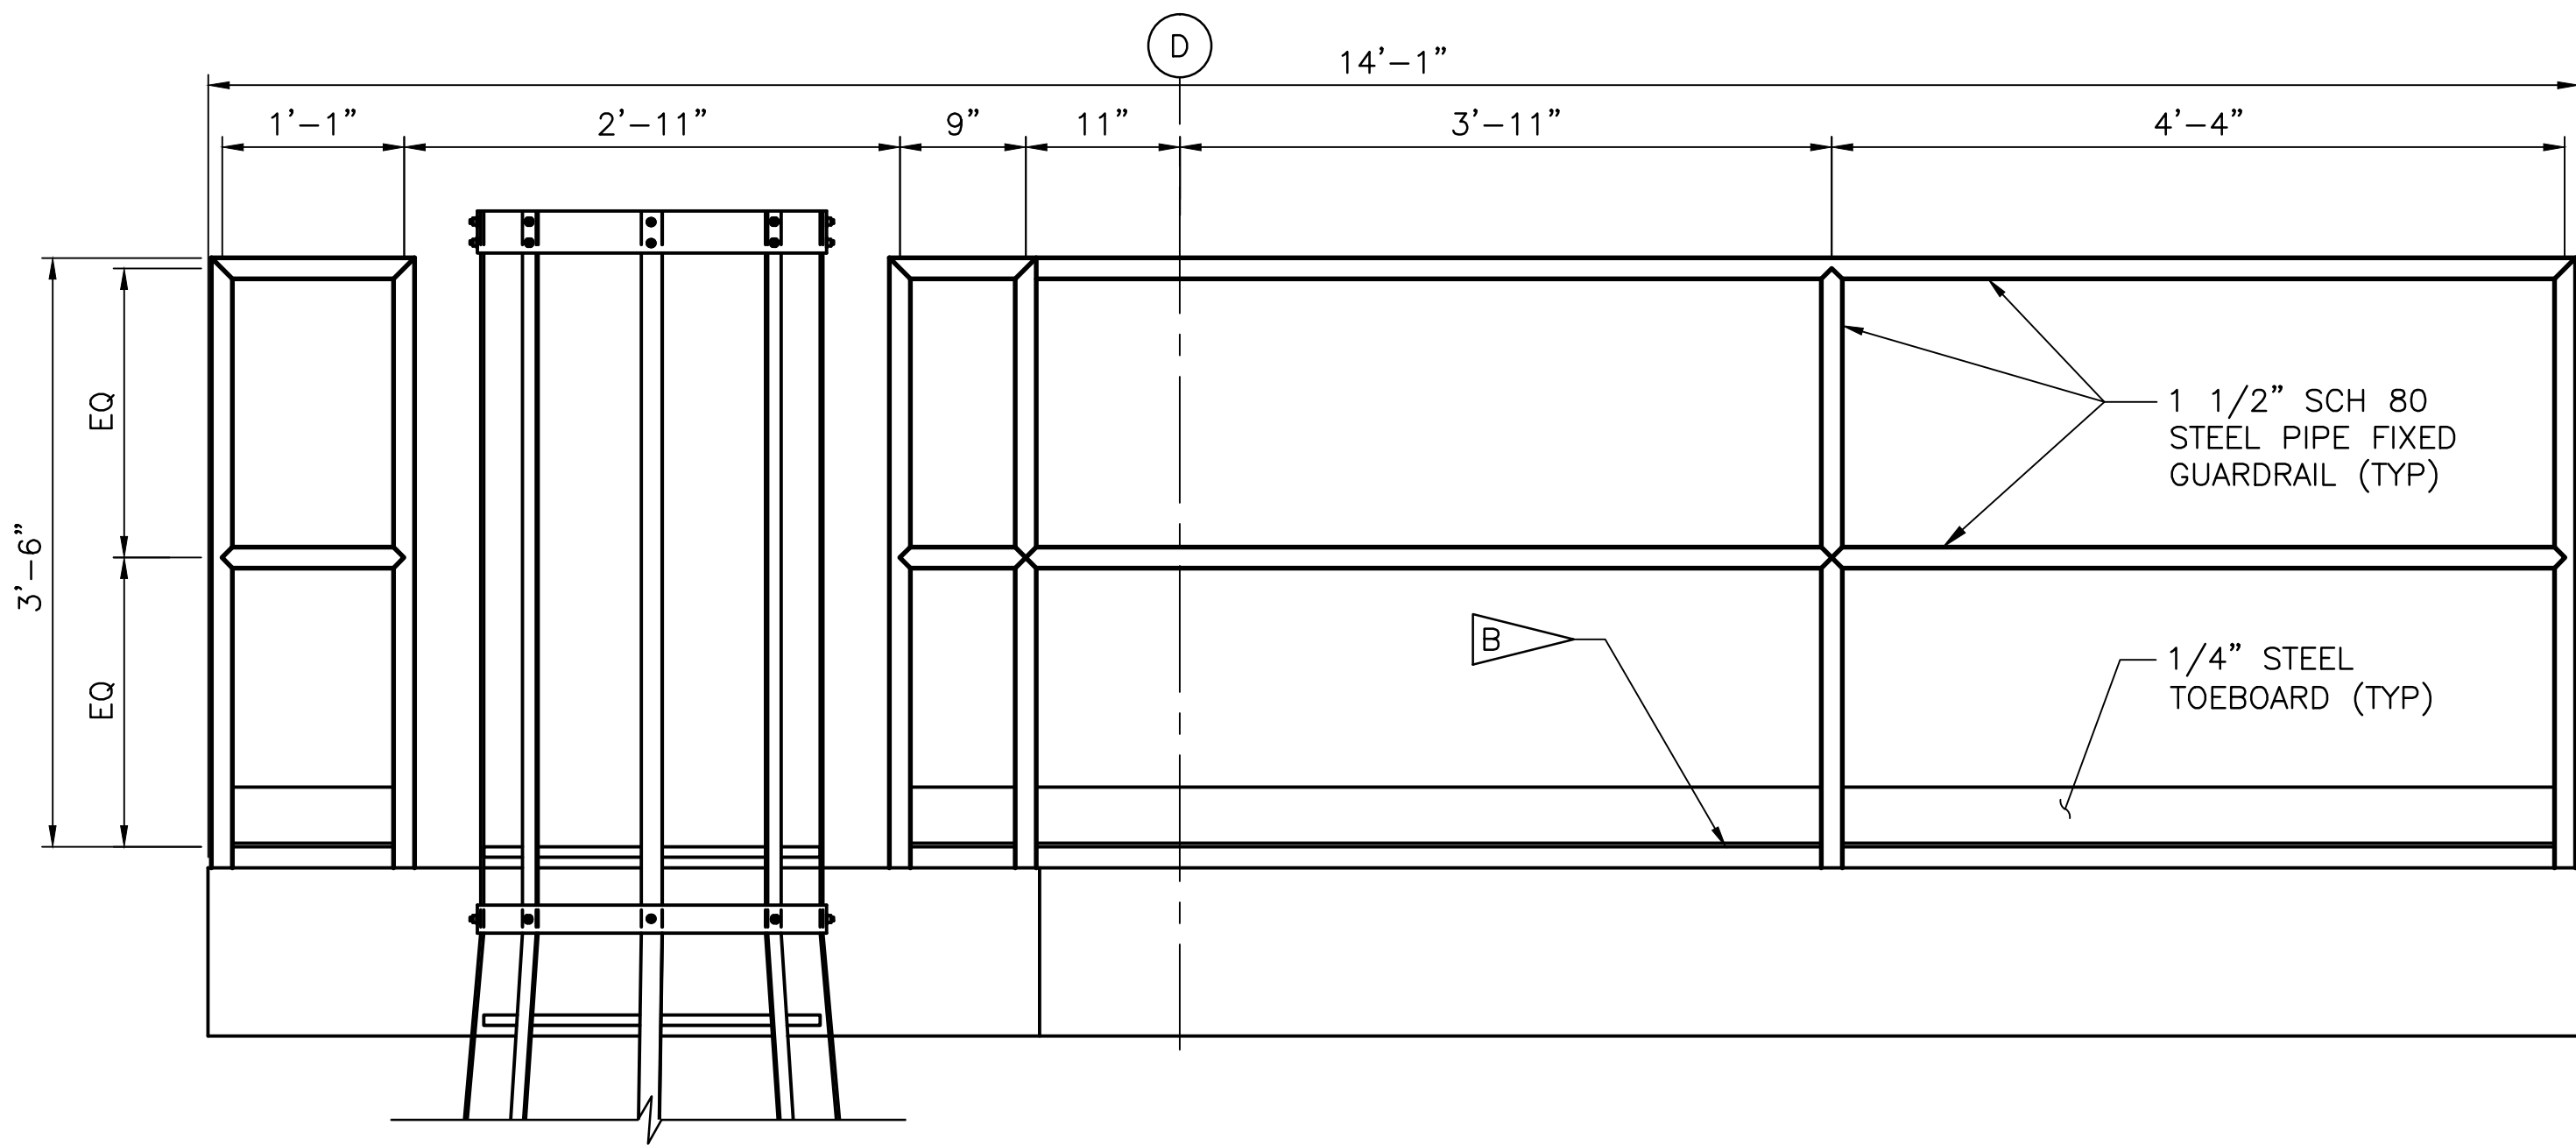


GUARDRAIL AT NEW SERVICE PLATFORM (G)
SCALE: 1" = 1'-0"

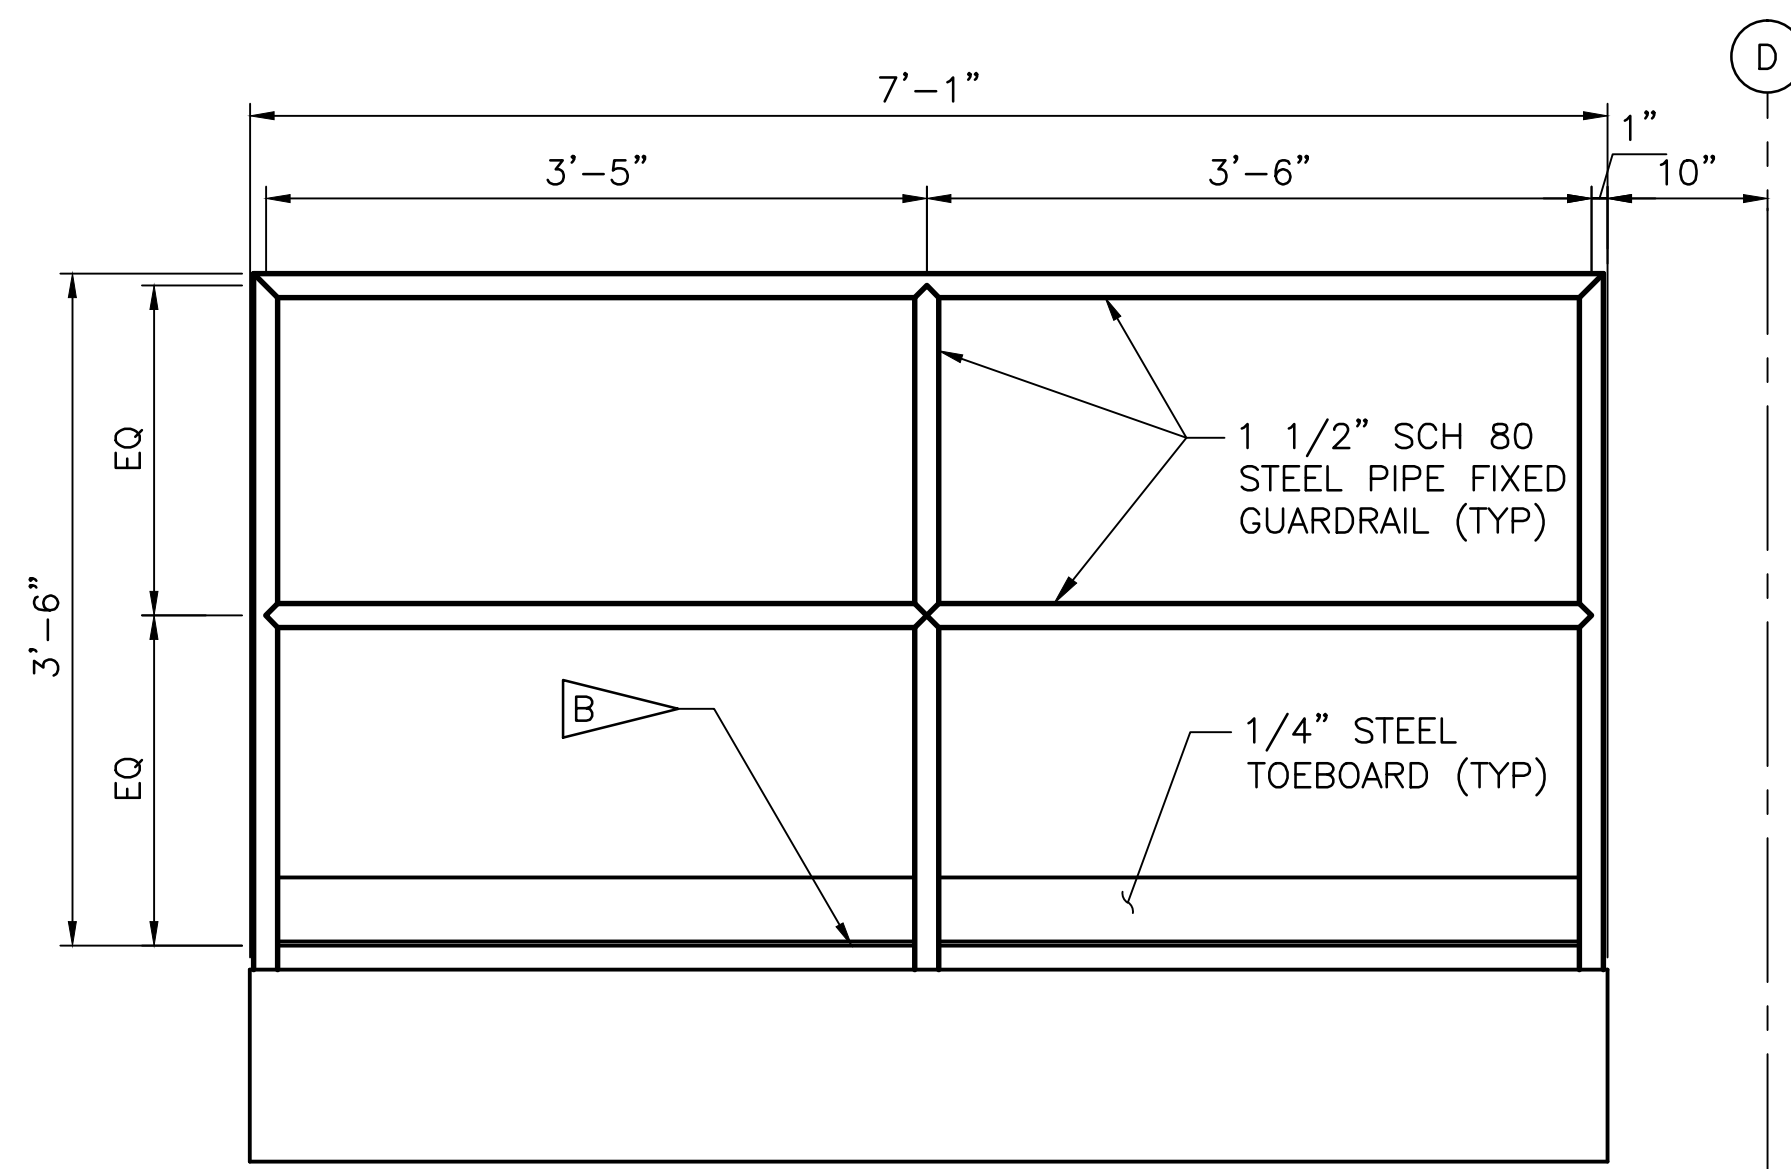SPECIFIC NOTES:


- A. SEE DETAIL A FOR GUARDRAIL DETAILS.
B. STEEL DECK PLATES, SEE SHEETS S-401 AND S-402.



GUARDRAIL AT NEW SERVICE PLATFORM (E)
SCALE: 1" = 1'-0"

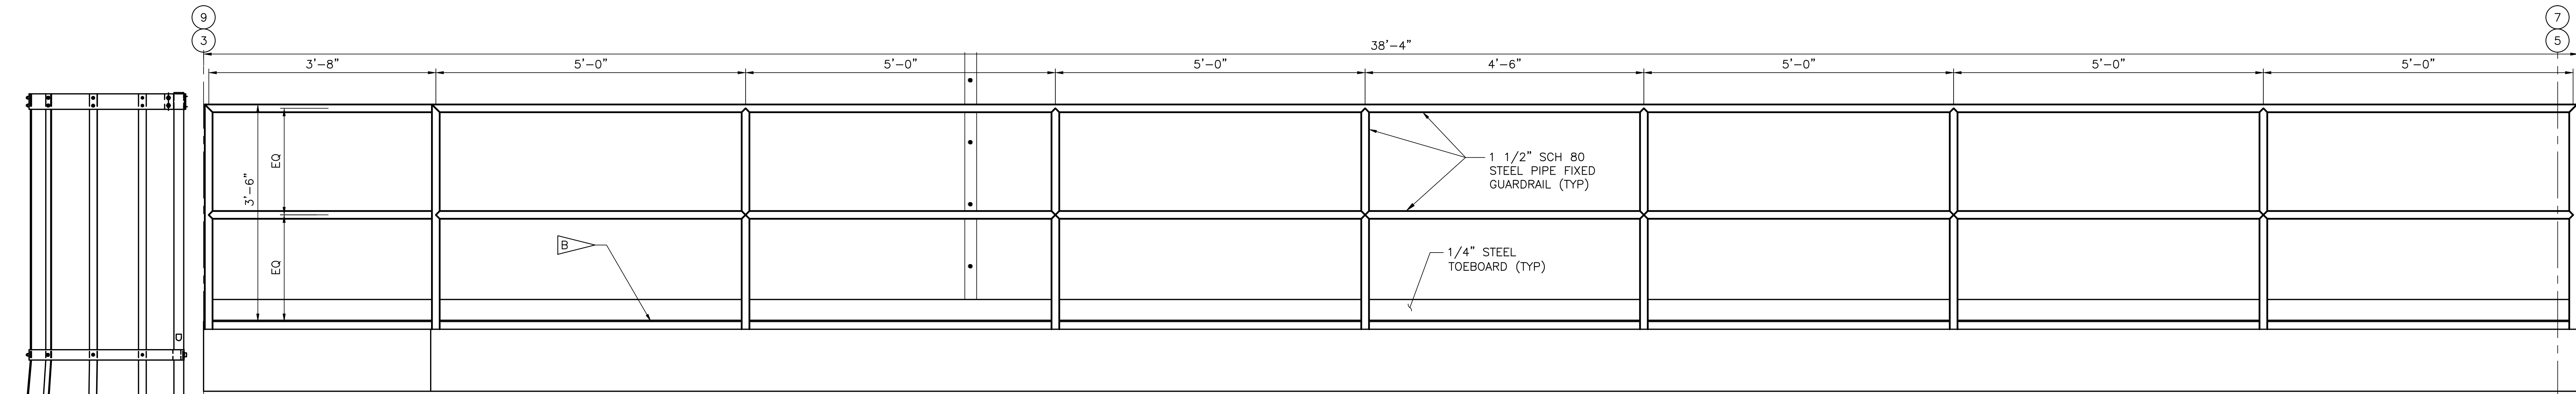

GUARDRAIL AT NEW SERVICE PLATFORM (H)
SCALE: 1" = 1'-0"

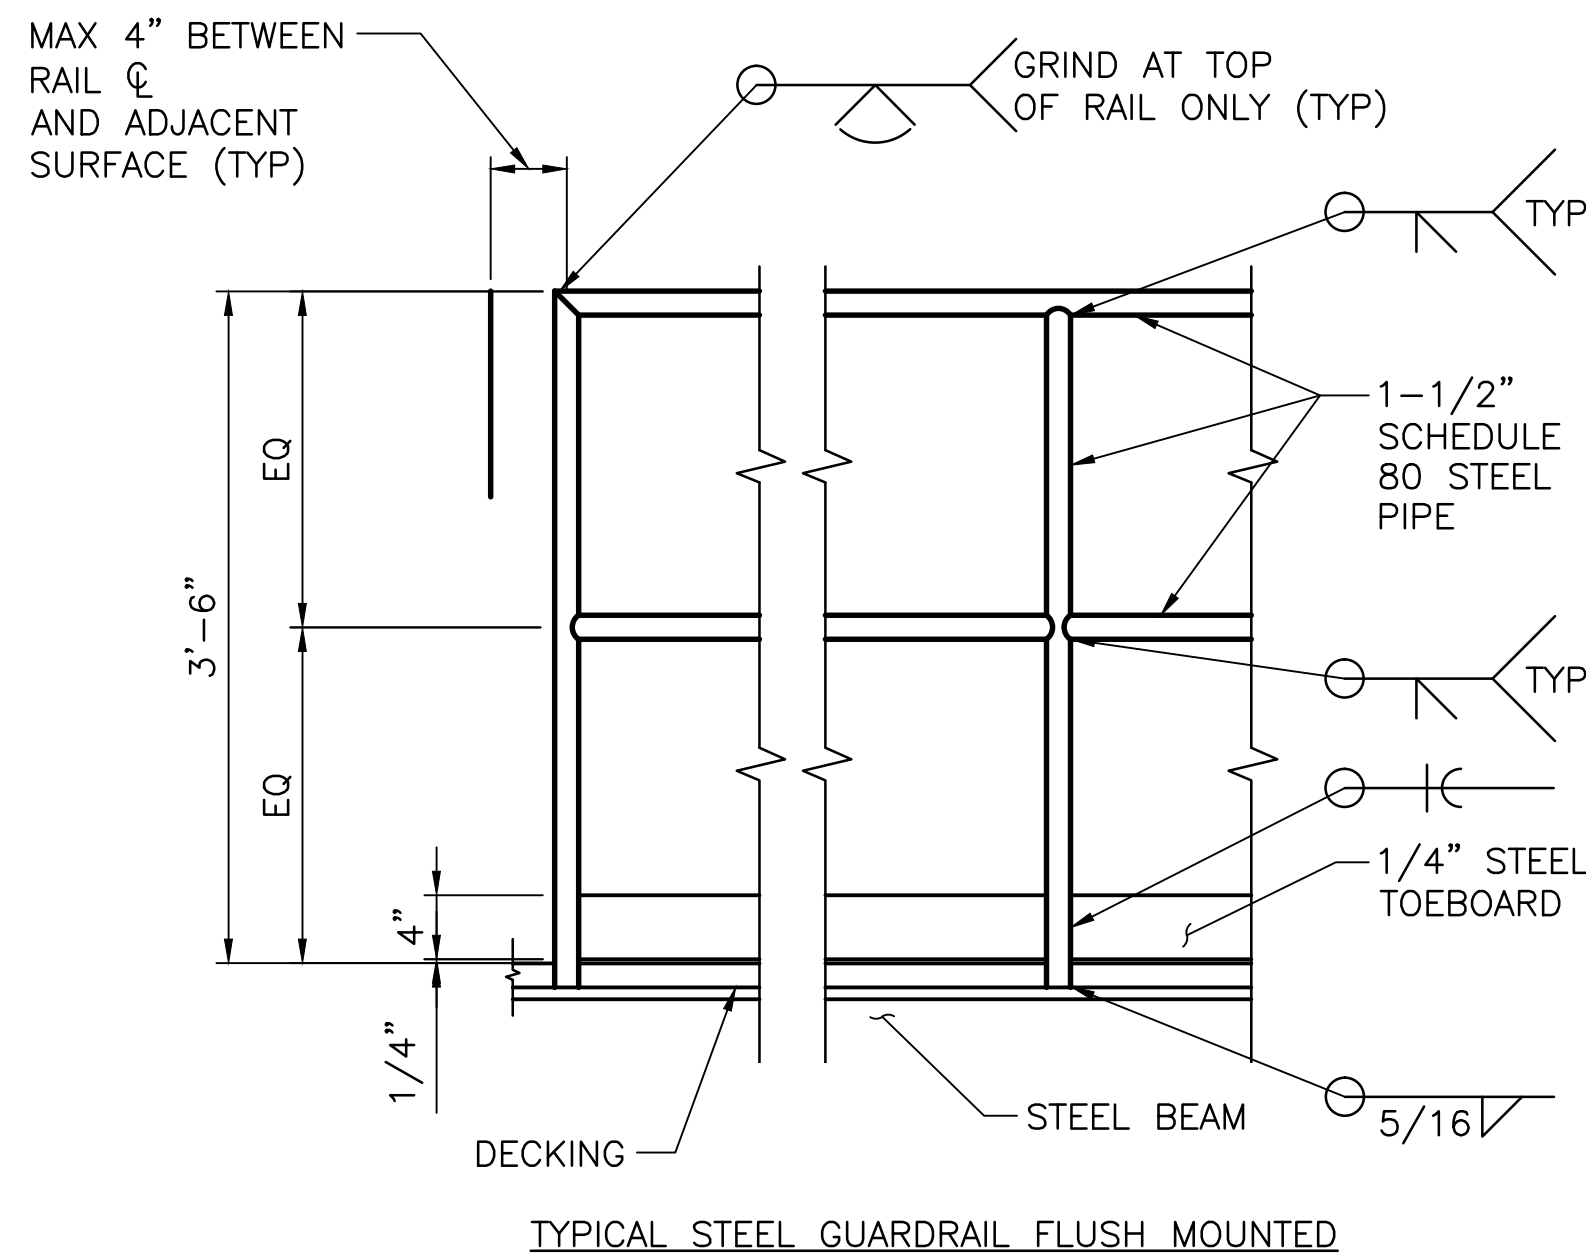

DETAIL (A)
SCALE: 1" = 1'-0"


1 9" 6" 3" 0 1 2
1 IN = 1 FT

WHEN PRINTED FULL SIZE, THIS SHEET IS 34"x44"
THIS COMPUTER DRAWING WAS
CREATED IN AUTOCAD AND
FILED UNDER THE DRAWING NUMBER


A-503

SYM	ZONE	DESCRIPTION	DATE	APPROVAL
REVISIONS				
RSH IMPROVING YOUR WORLD				
Reynolds, Smith and Hills, Inc. 115 Alma Blvd., Suite 101 Merritt Island, Florida 32953-4101 (321) 453-0212 (321) 453-0223 FAX www.rsandh.com				
NATIONAL AERONAUTICS AND SPACE ADMINISTRATION JOHN F. KENNEDY SPACE CENTER, NASA KENNEDY SPACE CENTER, FLORIDA				
LAUNCH COMPLEX 39 VEHICLE ASSEMBLY BUILDING MODIFY VEHICLE ASSEMBLY BUILDING HIGH BAY 3 FOR SLS - HOISTS GUARDRAIL ELEVATIONS AND DETAILS				
SIGNATURES	DATE			
DRAWN: BRIAN CURTIS	08-20-2013			
CHECKED: ALICE SCHULTZ	08-20-2013			
SUBMITTED ARCHIVING OF RECORDS				
TONY MAZZA				
ST. OF LICENSE: FL				
LICENSE NO:				
APPROVED:				
JOHN KERESMAR				
MIKE HARTNETT				
FILE NO.	302-6058-043	SIZE	11	REV
PROJ. NO.	PCN 99000.5	SHEET	12	OF

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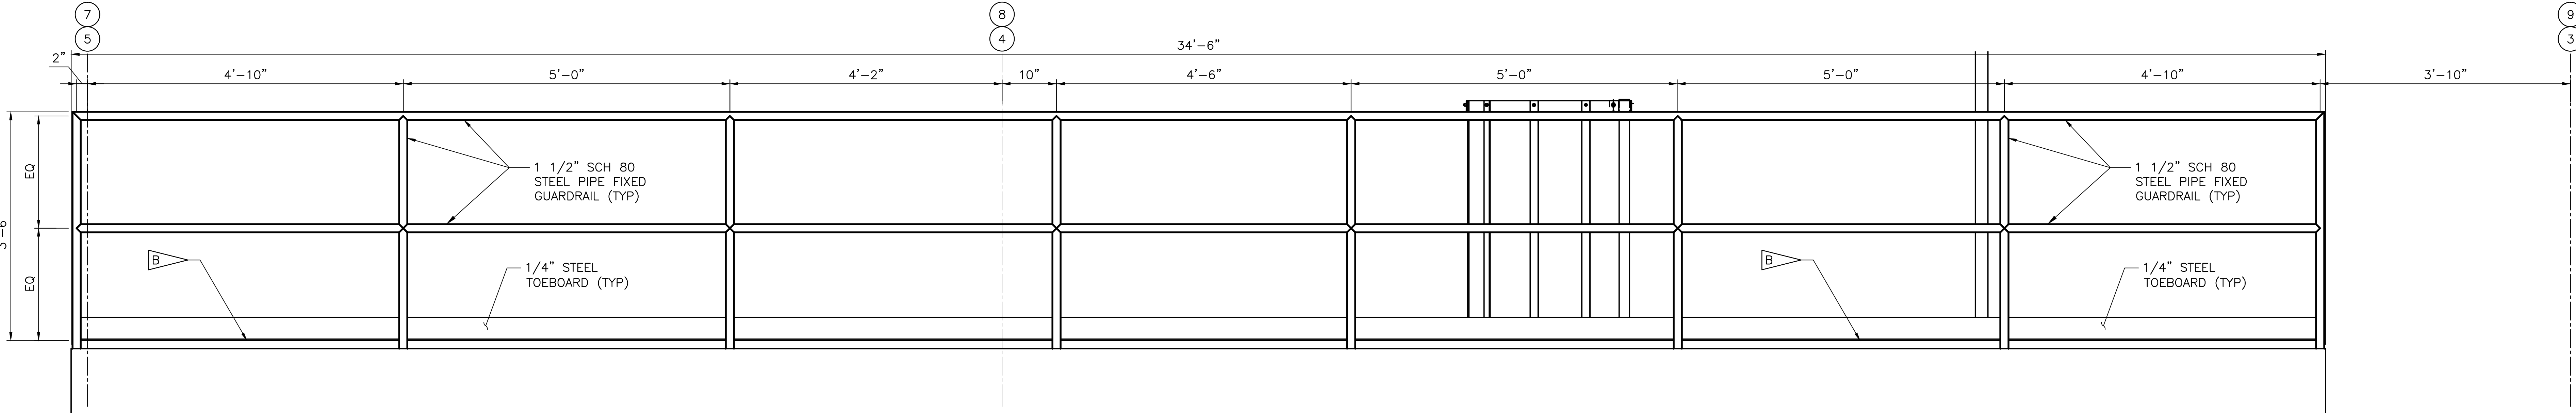


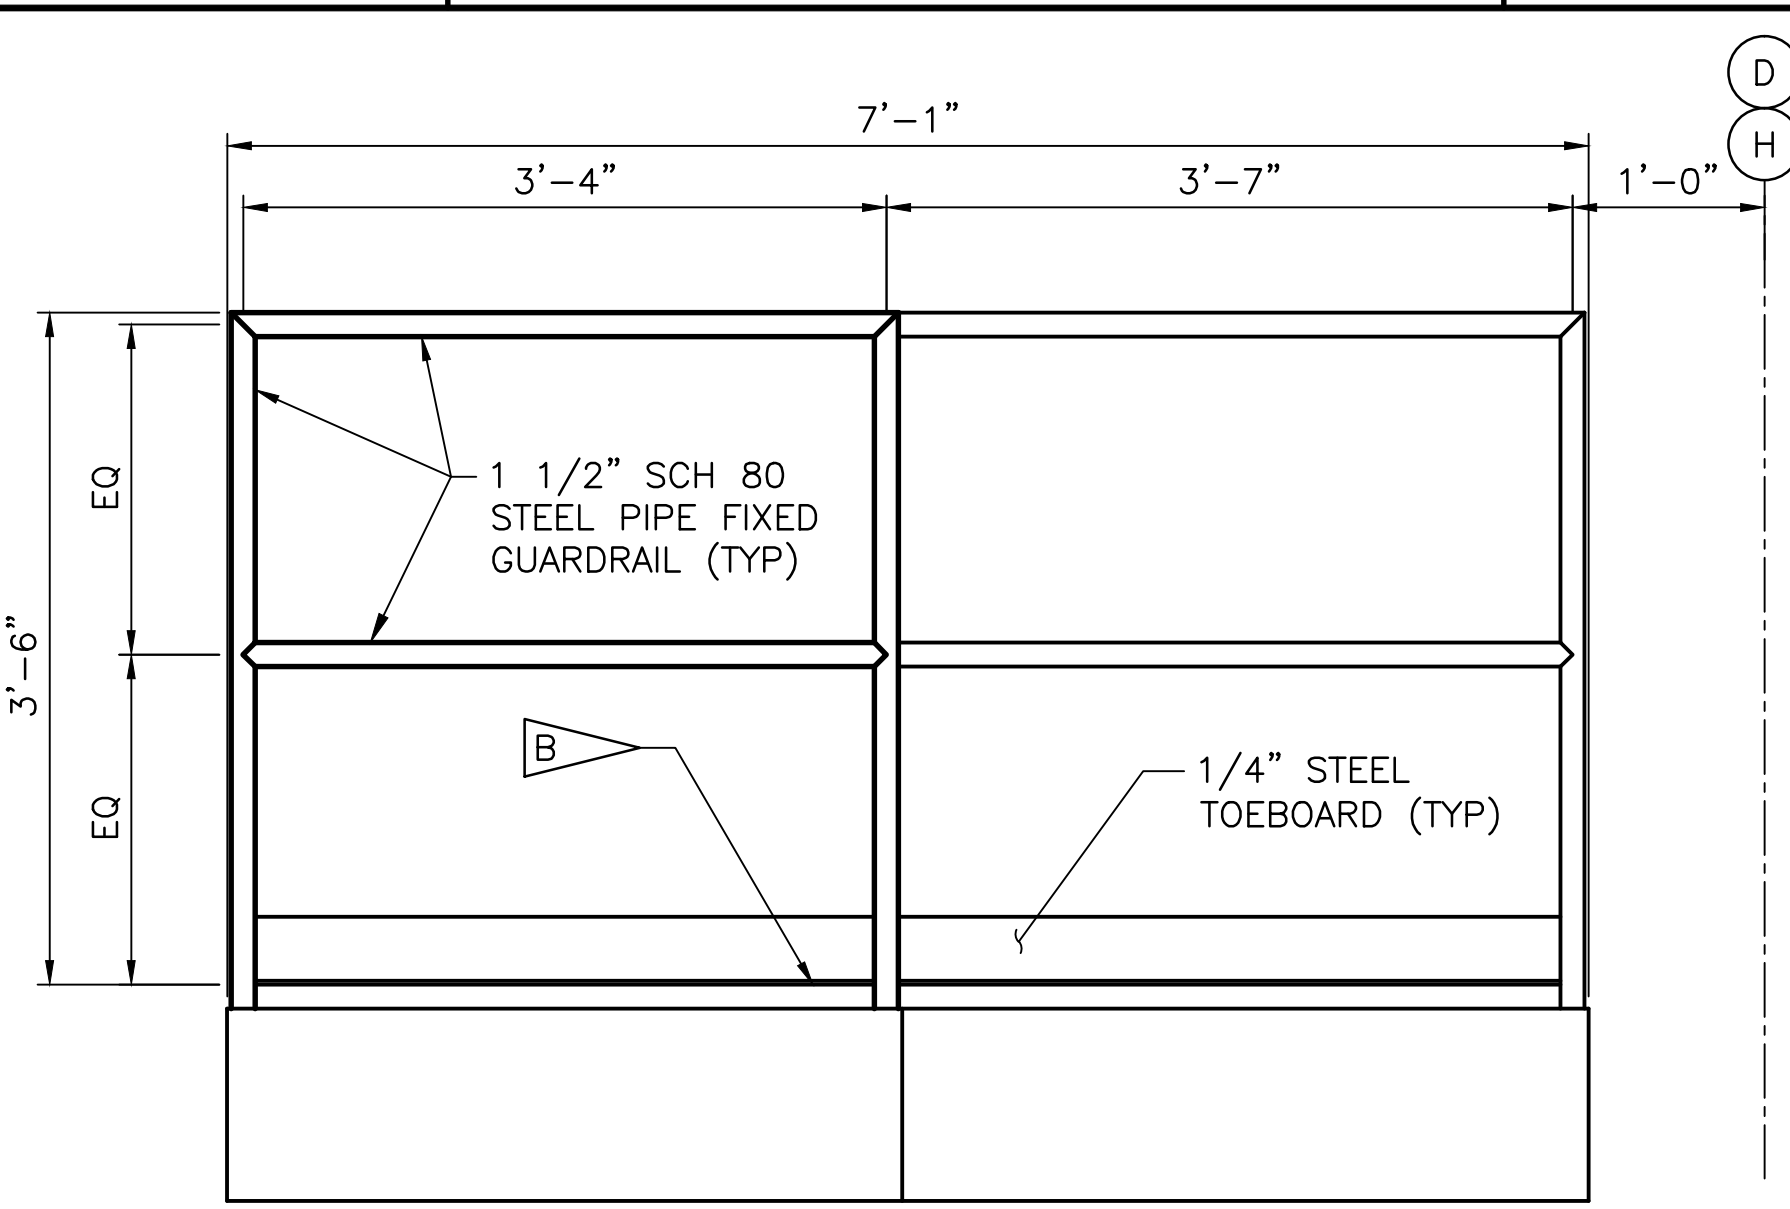GUARDRAIL AT NEW SERVICE PLATFORM (B)
SCALE: 1" = 1'-0"

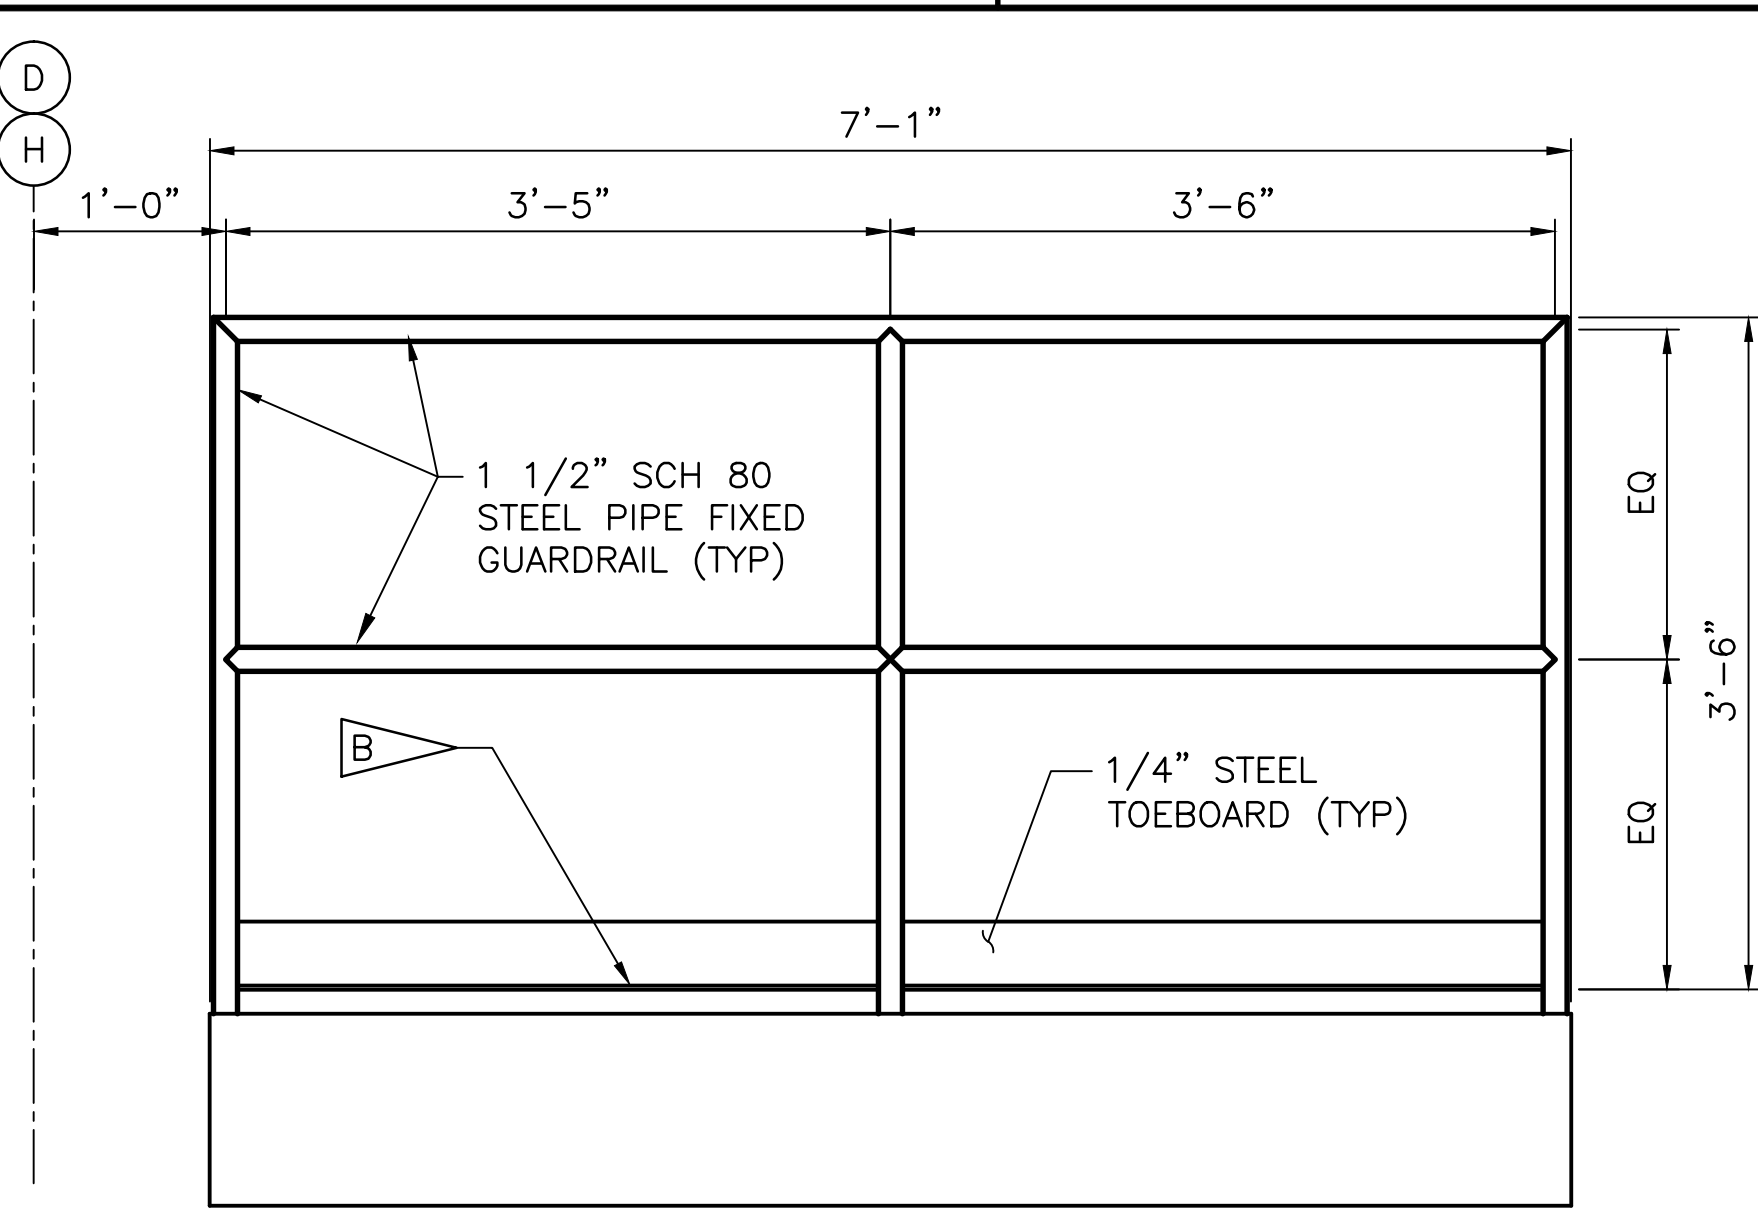


GUARDRAIL AT NEW SERVICE PLATFORM (E)
SCALE: 1" = 1'-0"


SPECIFIC NOTES:
A. SEE DETAIL A/A-503 FOR GUARDRAIL DETAILS.
B. STEEL DECK PLATES, SEE SHEETS S-401 AND S-402.



GUARDRAIL AT NEW SERVICE PLATFORM (A)
SCALE: 1" = 1'-0"

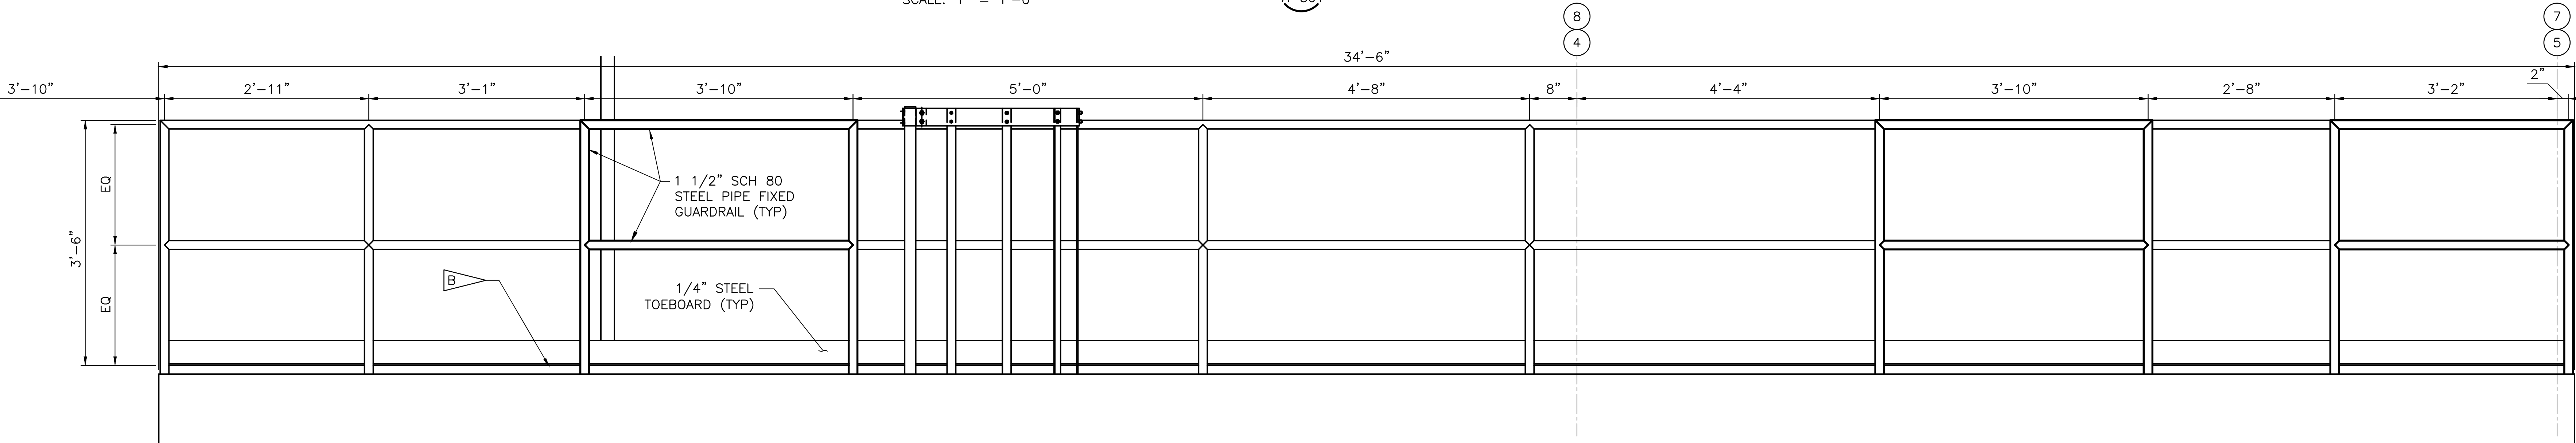

GUARDRAIL AT NEW SERVICE PLATFORM (C)
SCALE: 1" = 1'-0"

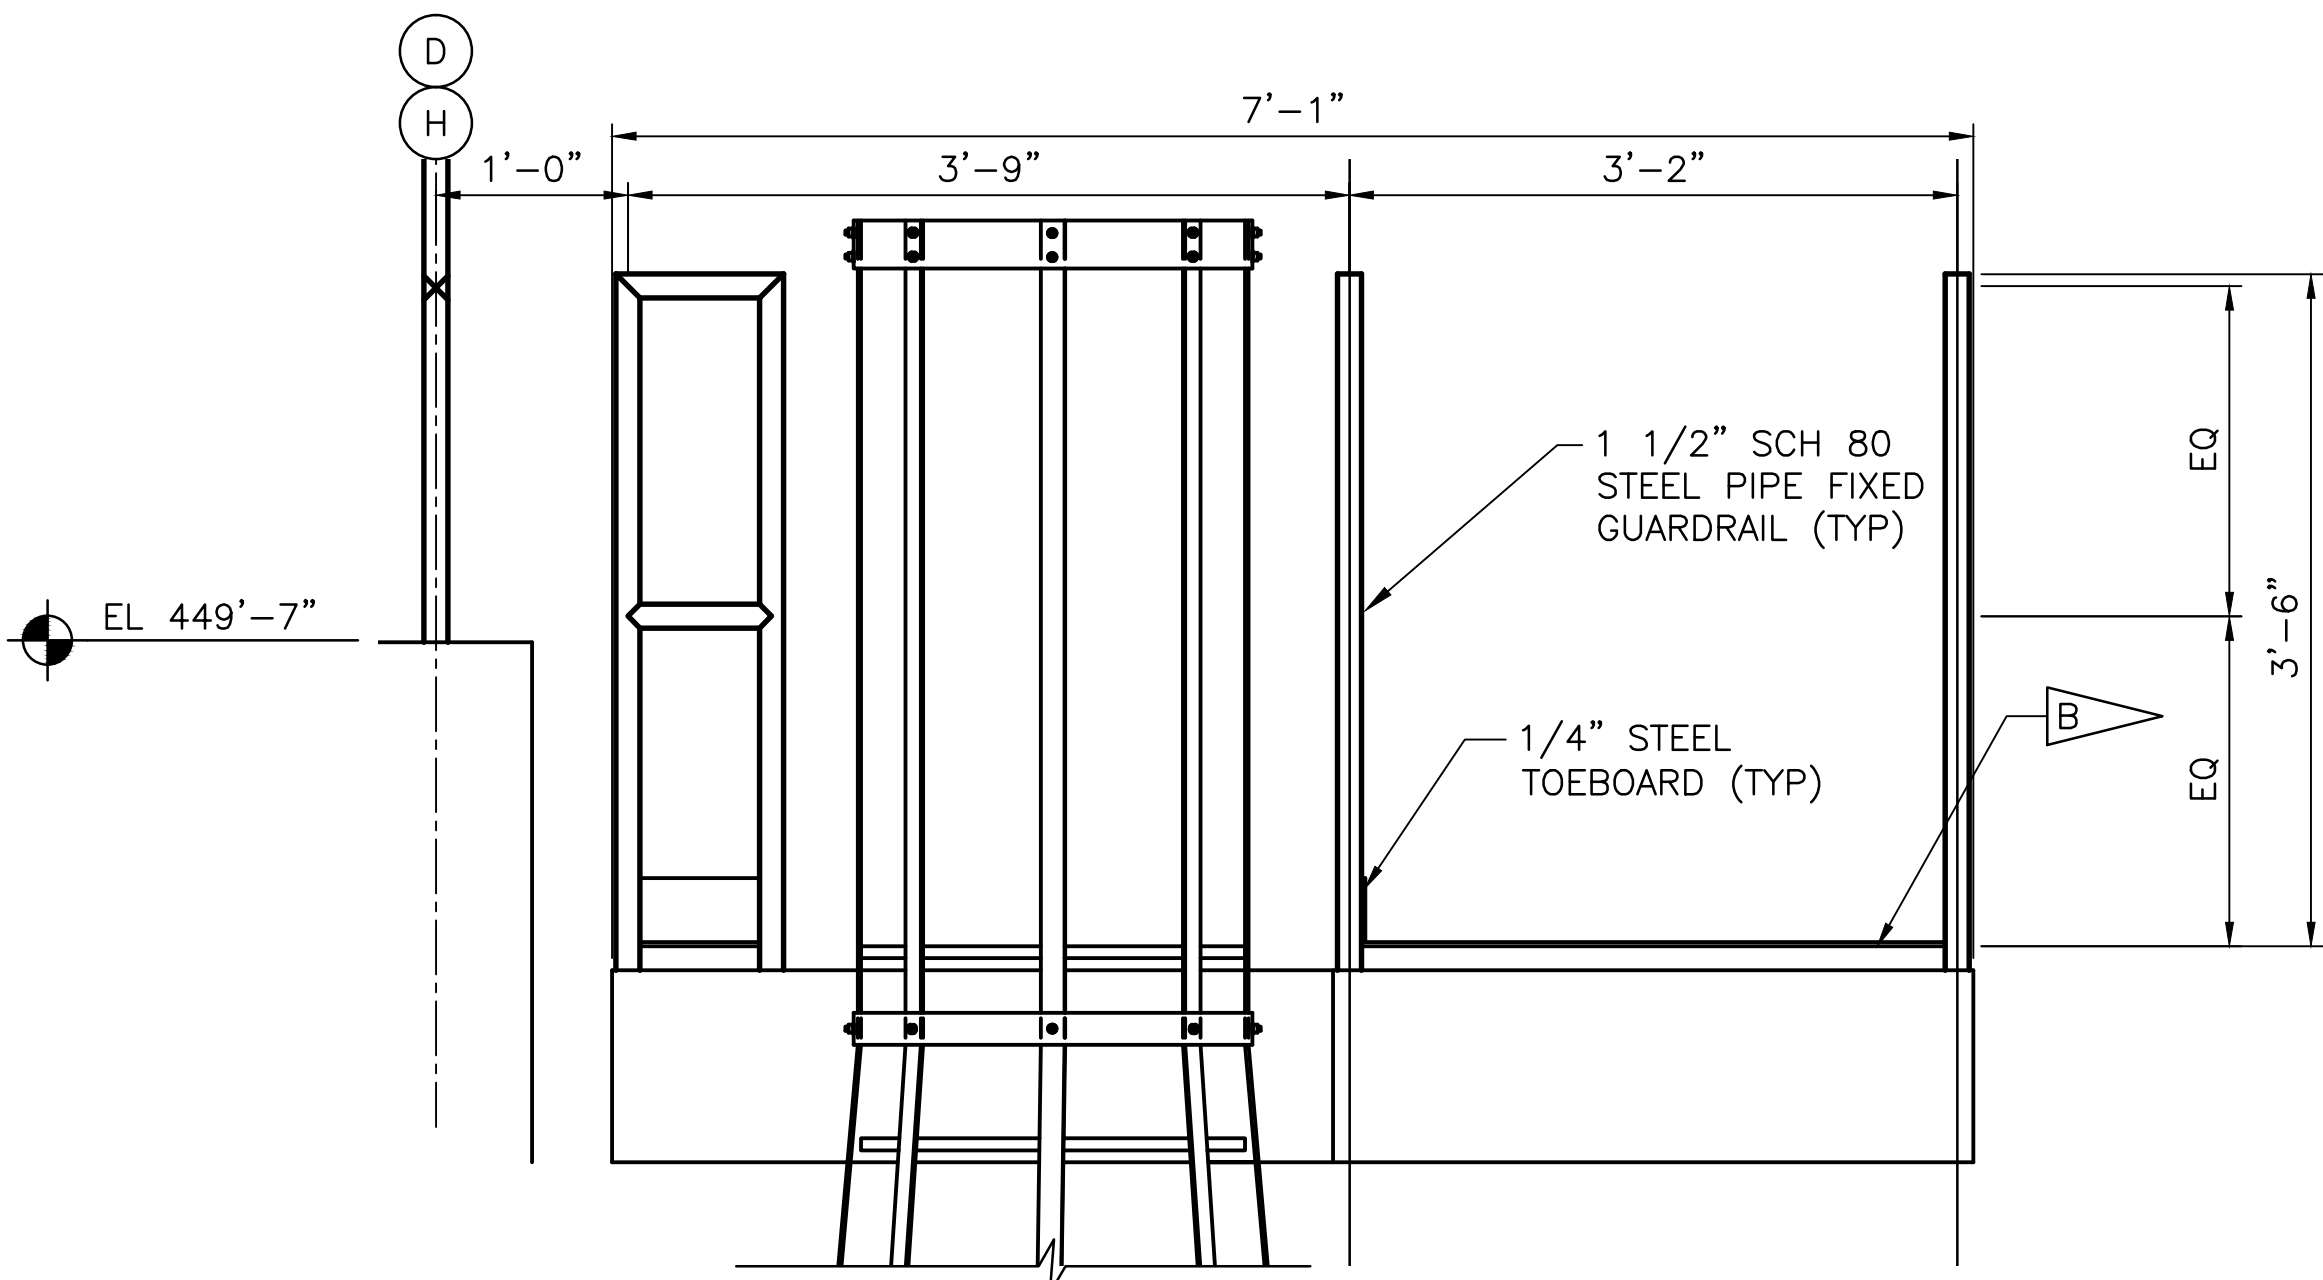

GUARDRAIL AT NEW SERVICE PLATFORM (D)
SCALE: 1" = 1'-0"


1 9" 6" 3" 0 1 2
1 IN = 1 FT

WHEN PRINTED FULL SIZE, THIS SHEET IS 34"x44"
THIS COMPUTER DRAWING WAS
CREATED IN AUTOCAD AND
FILED UNDER THE DRAWING NUMBER



A-504

SYM	ZONE	DESCRIPTION		DATE	APPROVAL
REVISIONS					
SIGNATURES		DATE	NATIONAL AERONAUTICS AND SPACE ADMINISTRATION JOHN F. KENNEDY SPACE CENTER, NASA KENNEDY SPACE CENTER, FLORIDA LAUNCH COMPLEX 39 VEHICLE ASSEMBLY BUILDING MODIFY VEHICLE ASSEMBLY BUILDING HIGH BAY 3 FOR SLS - HOISTS GUARDRAIL ELEVATIONS		
DRAWN: BRIAN CURTIS	08-20-2013	08-20-2013	REYNOLDS, SMITH AND HILLS, INC. 115 ALMA BLVD, SUITE 101 MERRIT ISLAND, FLORIDA 32953-4101 (321) 453-0212 (321) 453-0223 FAX www.rsandh.com		
CHECKED: ALICE SCHULTZ	08-20-2013				
SUBMITTED ARCHIVING OF RECORD:					
TONY MAZZA					
ST OF LICENSE: FL					
LICENSE NO:					
APPROVED:					
JOHN KERCHMAR					
MIKE HARTNETT					
FILE NO.		302-6058-043	SIZE	DWG. NO.	REV
			E	79K39667	
PROJ. NO.		PCN	99000.5	SHEET	13 OF


NOTE: -- WHEN GOVERNMENT DRAWING SPECIFICATIONS OR OTHER DATA ARE USED FOR ANY PURPOSE OTHER THAN IN CONNECTION WITH A SPECIFIC GOVERNMENT PROCUREMENT CONTRACT, THE USER STATES GOVERNMENT PROPERTY RIGHTS NO RESPONSIBILITY FOR ANY OMISSIONS, ERRORS, AND THE FACT THAT THE GOVERNMENT HAS CONSIDERED, THROUGHOUT, OF ANY REFERENCE TO THE DRAWING SPECIFICATIONS OR ANY OTHER DATA IS NOT TO BE REGARDED BY MANUFACTURER OR USER AS ANY WARRANTY, ENDORSEMENT, OR ANY OTHER FORM OF CORROBORATION, OR CONFIRMATION OF ANY RIGHT OF INVENTION TO MANUFACTURE, USE, OR SELL ANY PATENTED INVENTION THAT IS ANY WAY BE RELATED THEREIN.

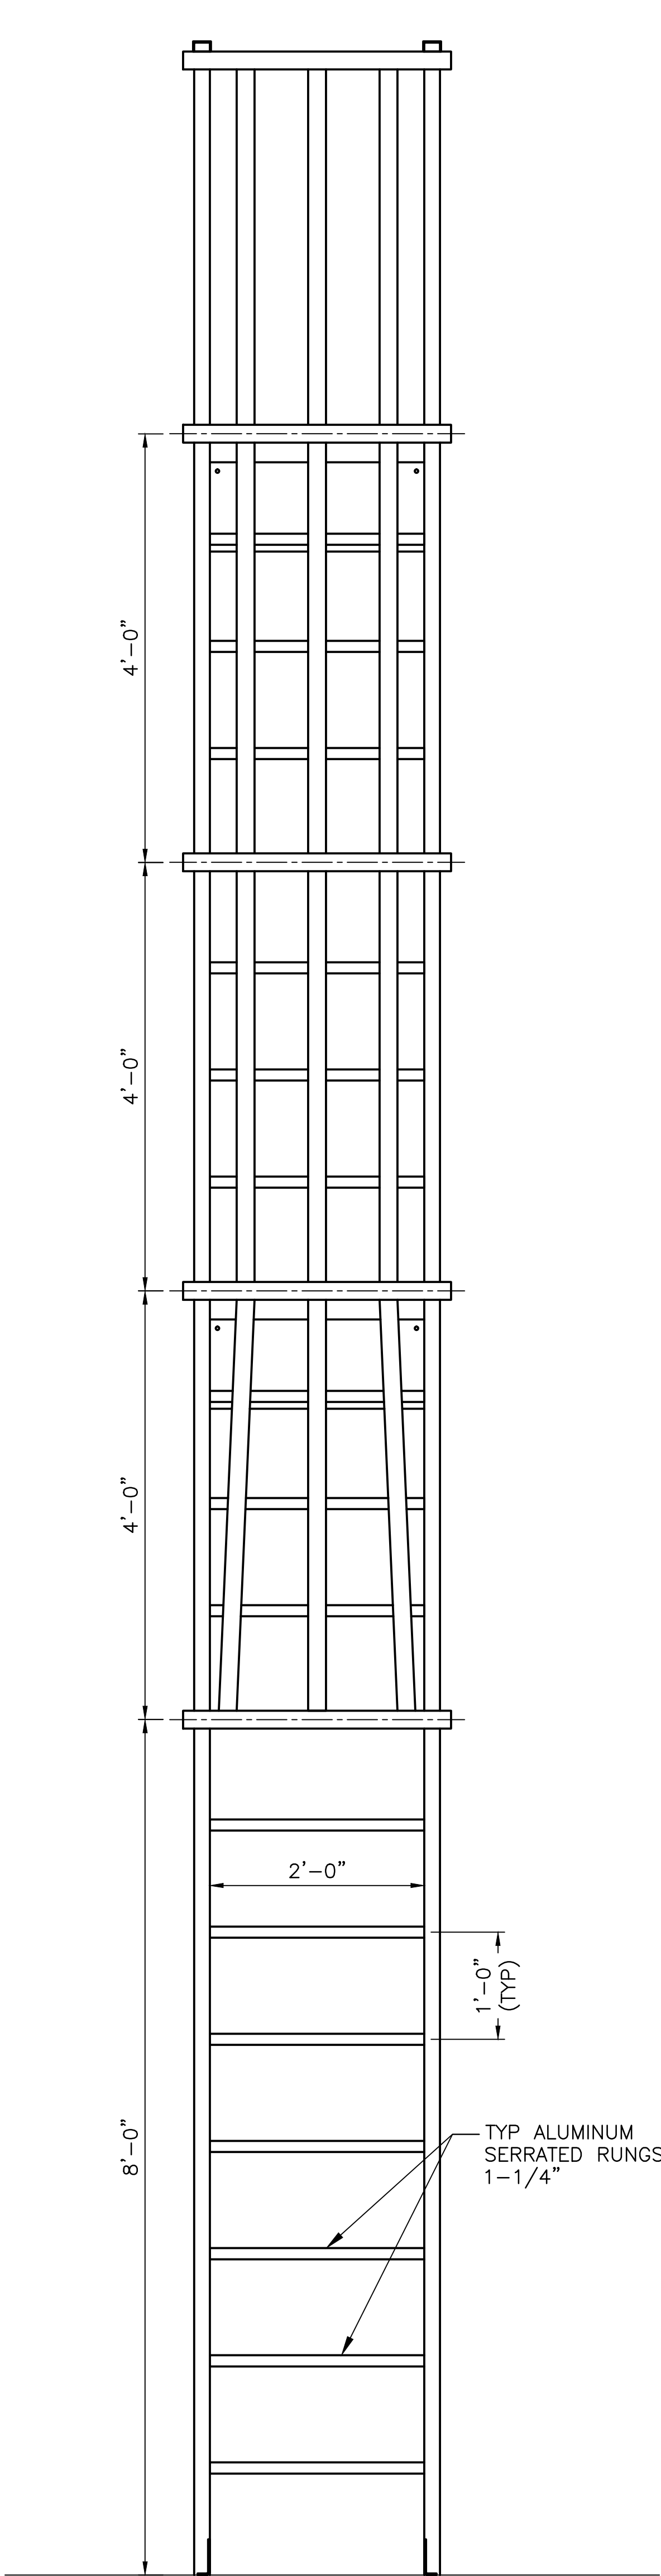


TYPICAL CAGED LADDER DETAIL
SCALE: 1" = 1'-0"

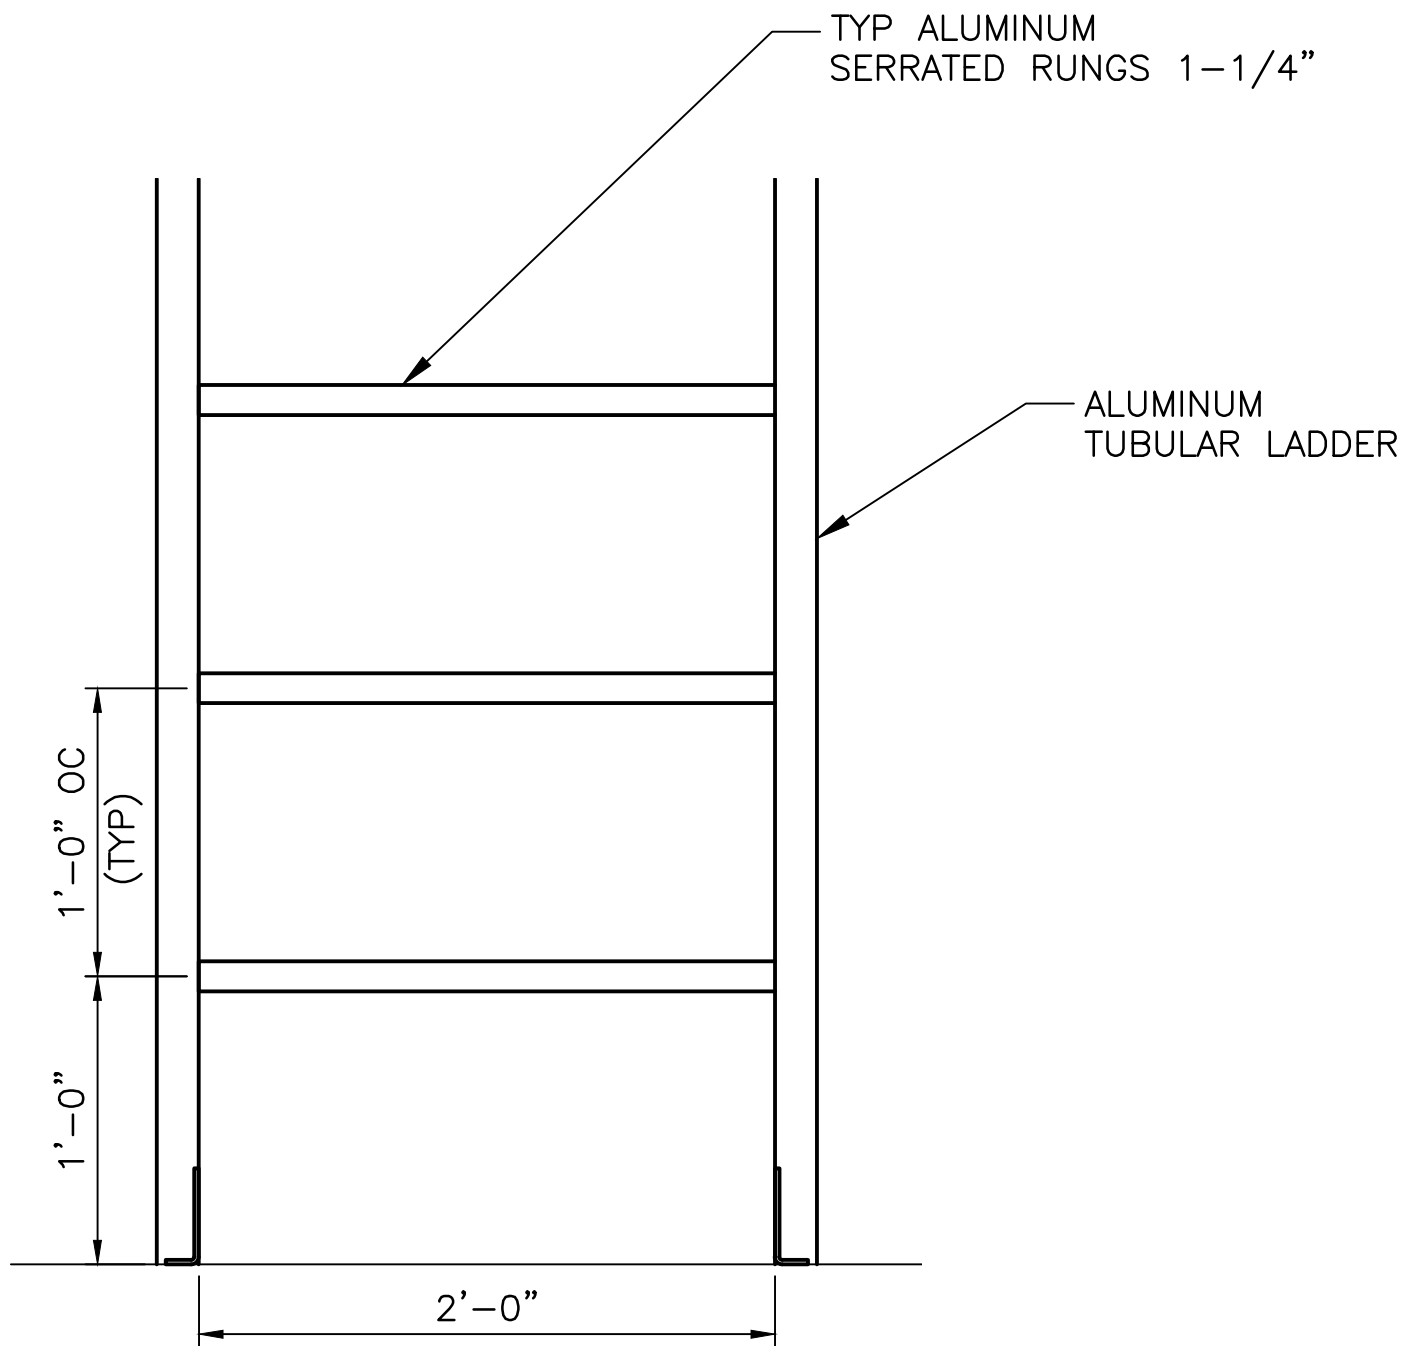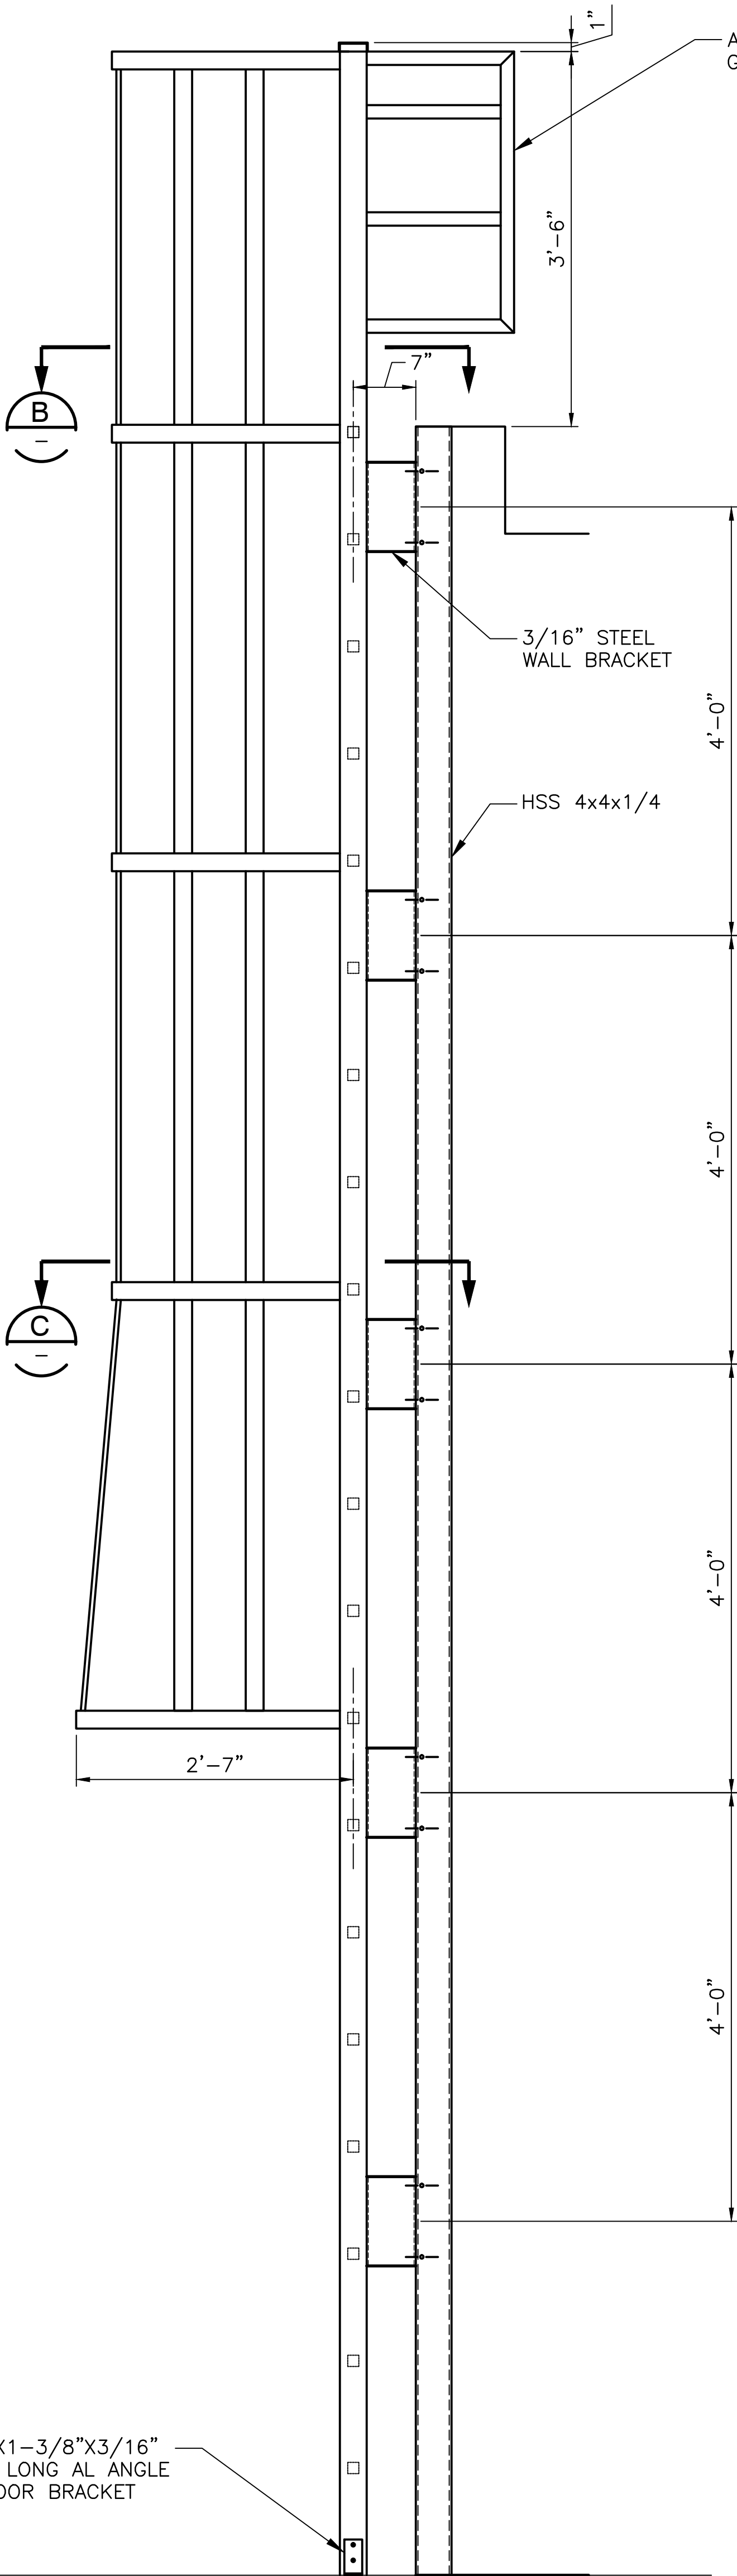


TYPICAL RUNG DETAIL
SCALE: 1 1/2" = 1'-0"

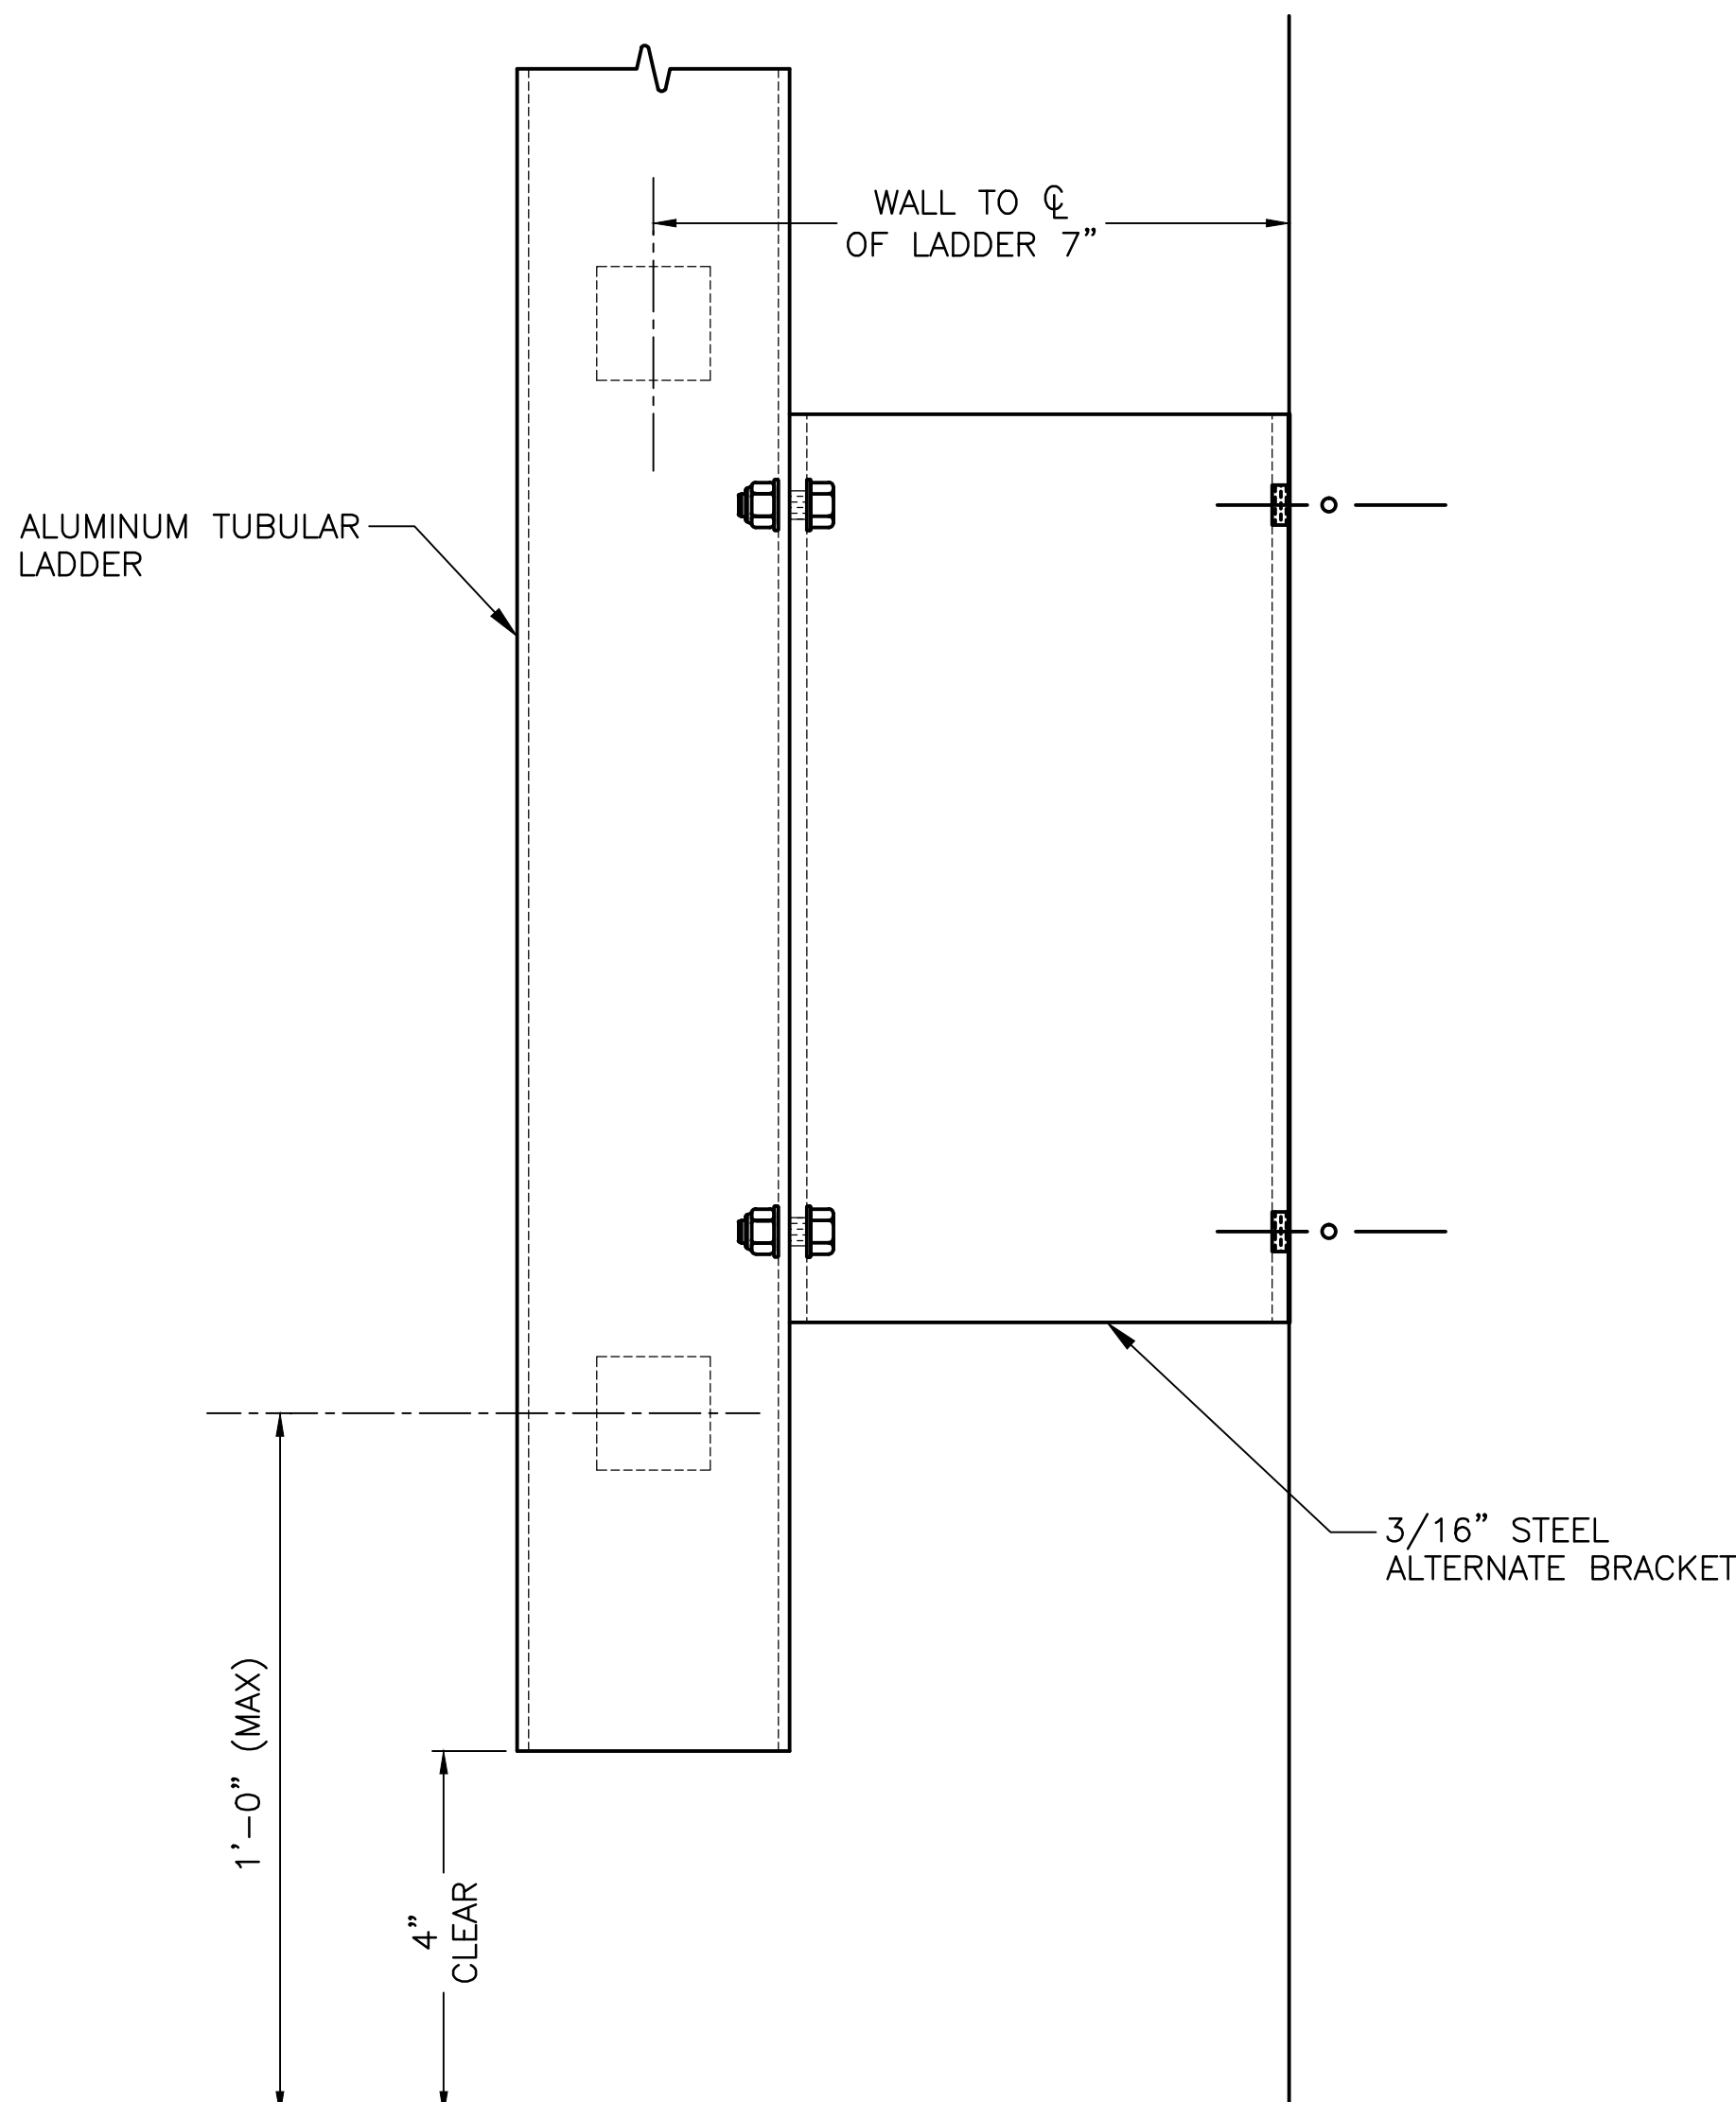


ALTERNATE OFF FLOOR SUPPORT
SCALE: 6" = 1'-0"

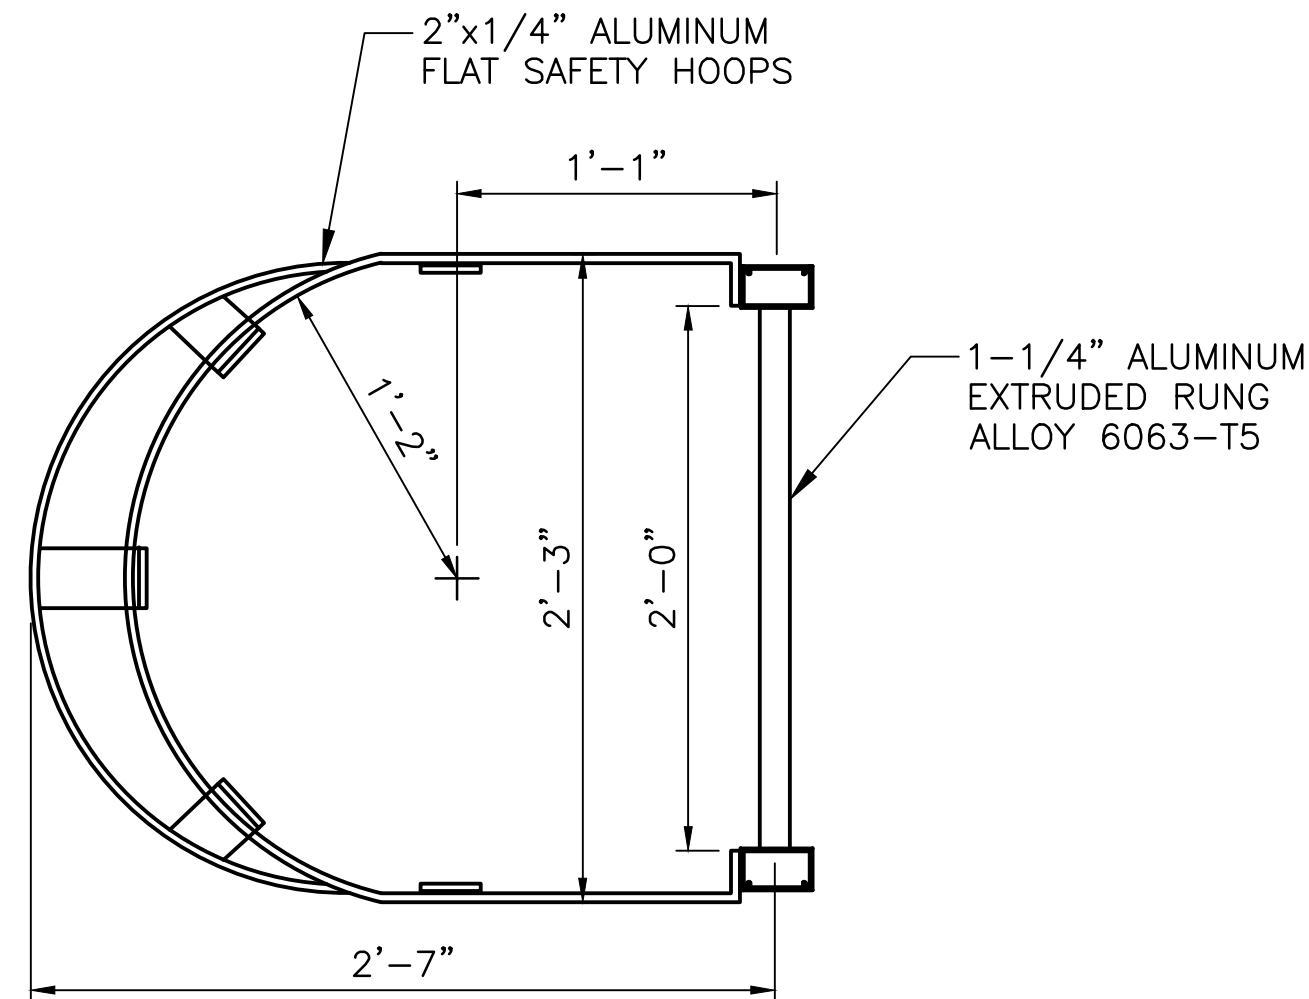


SECTION
SCALE: 1 1/2" = 1'-0"

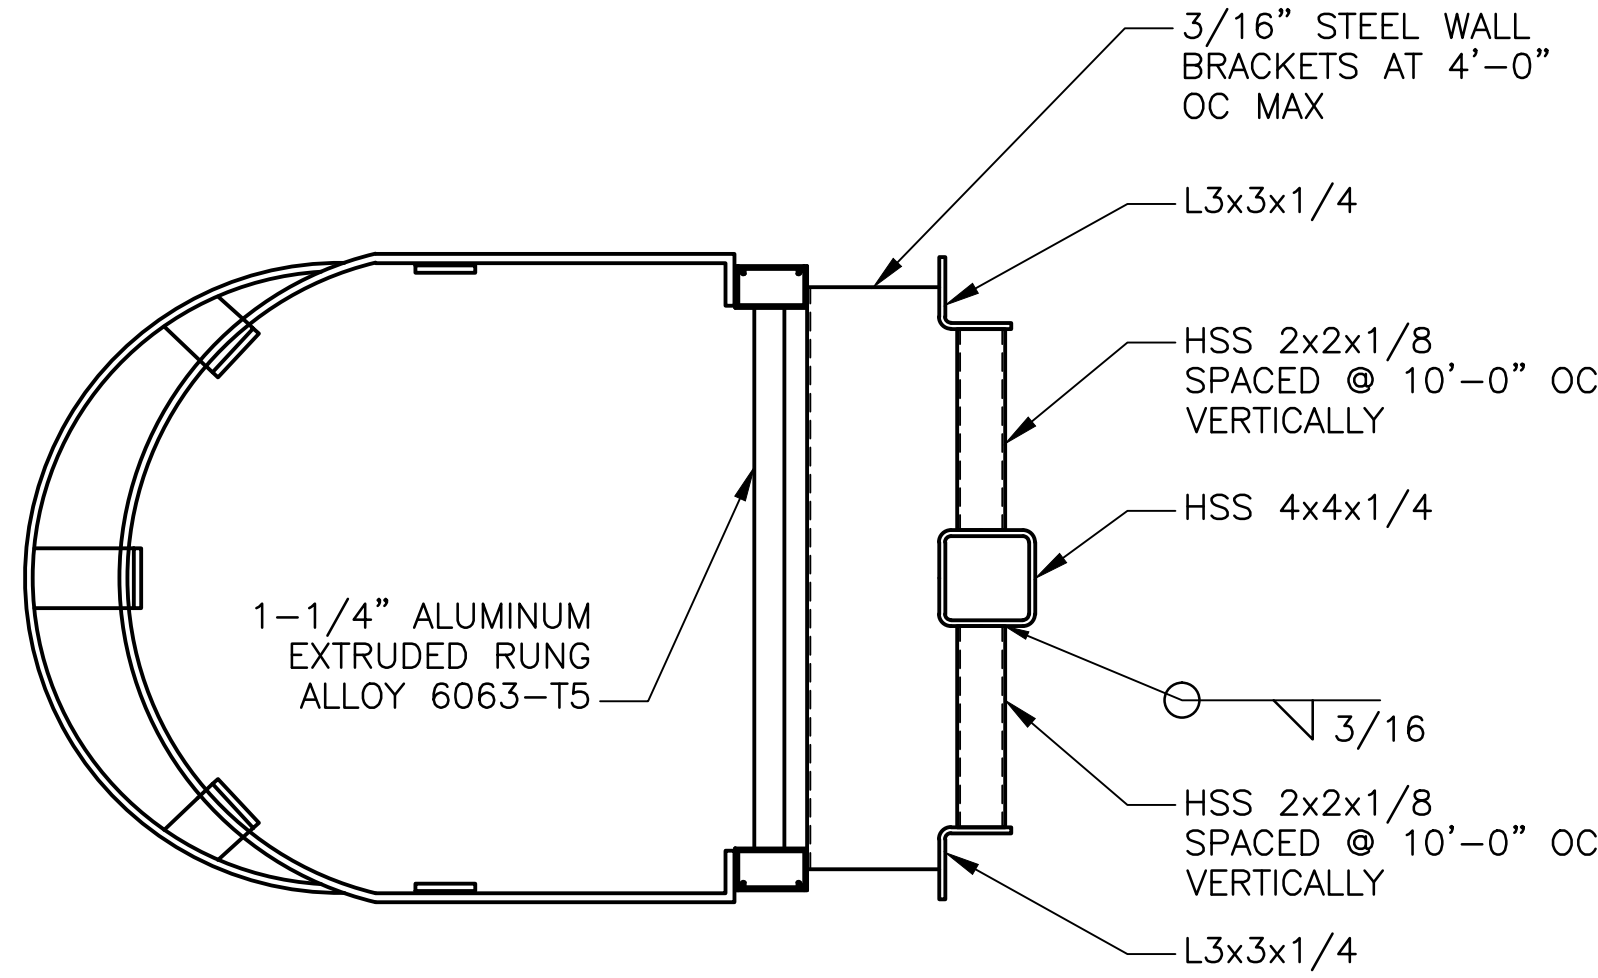

SECTION
SCALE: 1 1/2" = 1'-0"

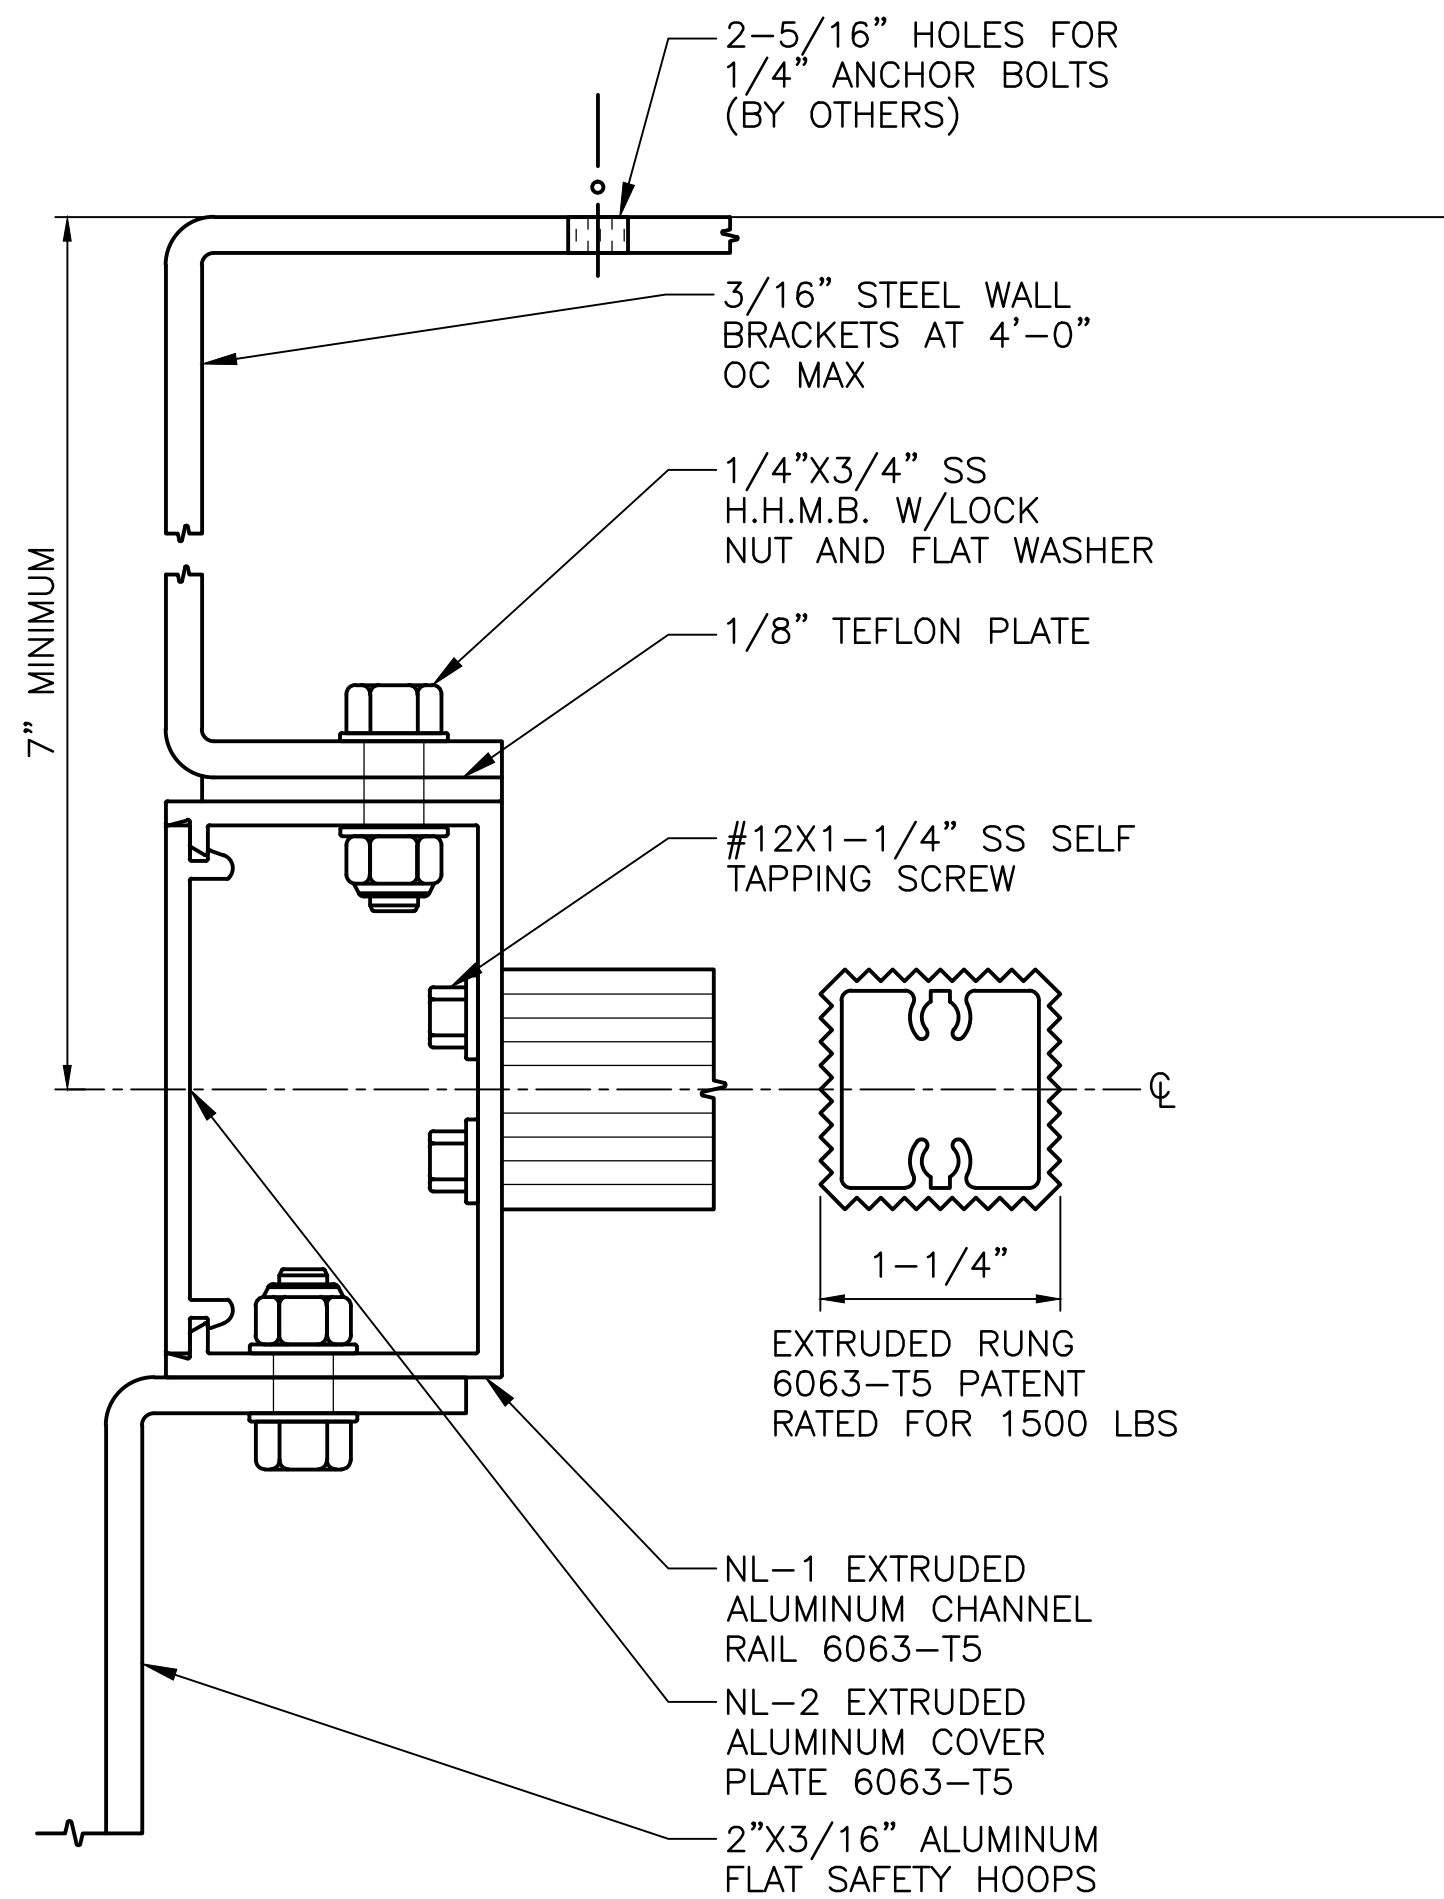

LADDER DETAILS
SCALE: 1" = 1'-0"

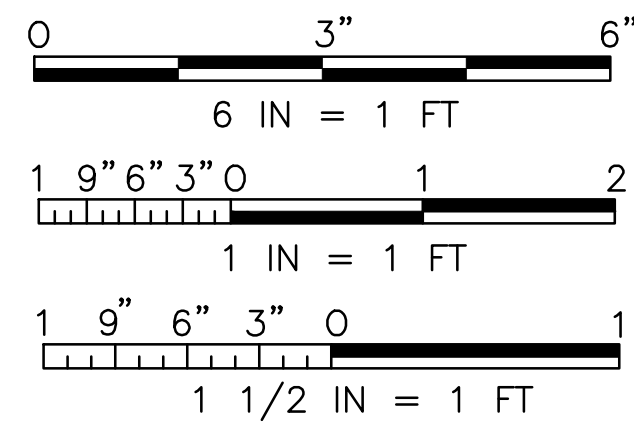

WHEN PRINTED FULL SIZE, THIS SHEET IS 34"X44"
THIS COMPUTER DRAWING WAS
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FILED UNDER THE DRAWING NUMBER

A-505

SYM	ZONE	DESCRIPTION	DATE	APPROVAL
REVISIONS				
RSH IMPROVING YOUR WORLD				
Reynolds, Smith and Hills, Inc. 115 Alma Blvd, Suite 101 Merritt Island, Florida 32953-4101 (321) 453-0212 (321) 453-0223 FAX www.rsandh.com				
NATIONAL AERONAUTICS AND SPACE ADMINISTRATION				
JOHN F. KENNEDY SPACE CENTER, NASA KENNEDY SPACE CENTER, FLORIDA				
LAUNCH COMPLEX 39				
VEHICLE ASSEMBLY BUILDING				
MODIFY VEHICLE ASSEMBLY BUILDING				
HIGH BAY 3 FOR SLS - HOISTS				
LADDER				
DETAILS				
SIGNATURES	DATE			
DRAWN: BRIAN CURTIS	08-20-2013			
CHECKED: ALICE SCHULTZ	08-20-2013			
SUBMITTED ARCHIVING OF RECORD				
TONY MAZZA				
ST OF LICENSURE: FL				
LICENSE NO:				
APPROVED:				
JOHN KERESMAR		FILE NO.	SIZE	TOWNS NO.
		302-6058-043	E	79K39667
MIKE HARTNETT		PROJ. NO.	PCN	99000.5
				SHEET 14 OF

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SPECIFIC NOTES:

A REMOVE EXISTING W14X142 COLUMN AND SUPPORTING TUBE SHAPED CONNECTORS DETAILED ON SHEET S-3-172 OF VOL. 5 OF AS-BUILT DRAWINGS. FILE NO. 203-28,297 FROM EL. 430' TO EL. 457'.

B EXTENSIBLE PLATFORM HOIST HOOK.

EXIST LEVEL 35
TOS EL=432'-1"

EXIST LEVEL 35
TOS EL=432'-1"

SEE ENLARGED
VIEW
1
S-401

SEE ENLARGED
VIEW
1
S-401 (SIM), (OPP HAND)

TURNING
SHEAVE
SUPPORT
BEAM
B

TURNING
SHEAVE
SUPPORT
BEAM
B

VEHICLE
SYMM ABOUT

SEE ENLARGED
VIEW
4
S-502

EXIST LEVEL 35
TOS EL=432'-1"


EXIST LEVEL 35
TOS EL=432'-1"

FRAMING PLAN (TOS EL=438'-6" UON)
SCALE: 1/8"=1'-0"

4 2 0 4 8 12 16 20
1/8" IN = 1 FT

WHEN PRINTED FULL SIZE, THIS SHEET IS 34"x44"
THIS COMPUTER DRAWING WAS
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FILED UNDER THE DRAWING NUMBER

S-135

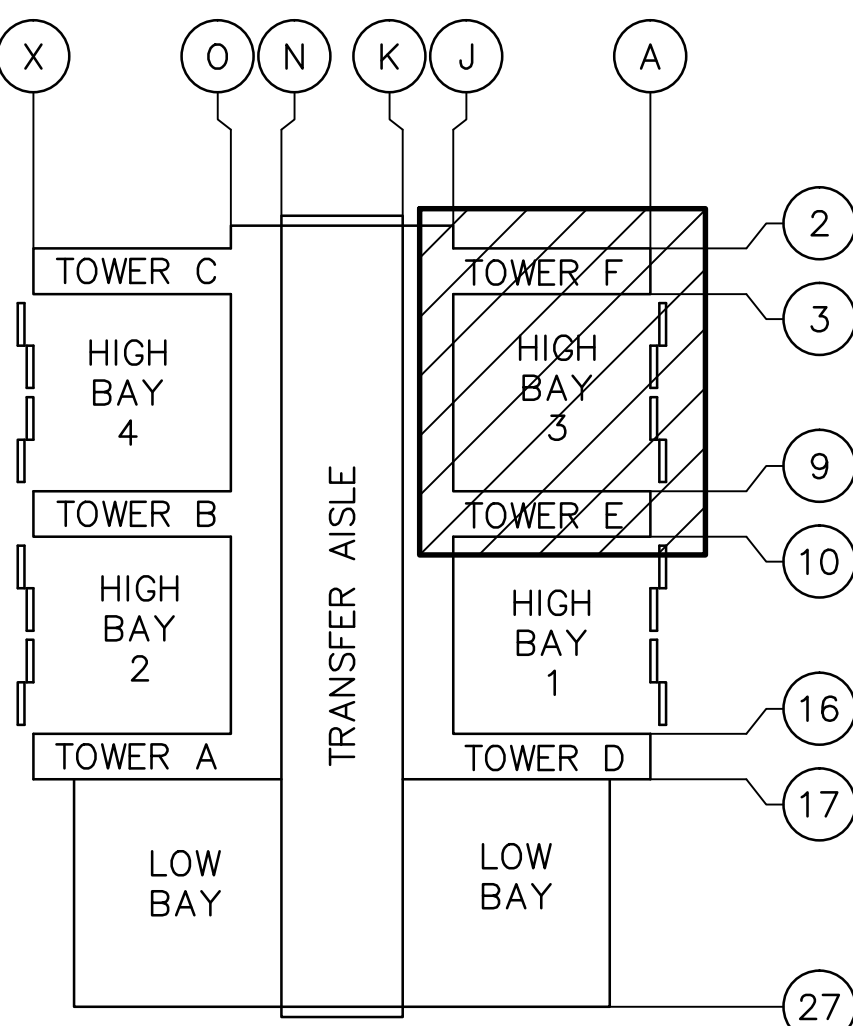

VAB KEY PLAN
SCALE: NTS



SYM	ZONE	DESCRIPTION	DATE	APPROVAL
REVISIONS				
SIGNATURES		DATE	REYNOLDS, Smith and Hills, Inc. 115 Alma Blvd, Suite 101 Merriett Island, Florida 32953-4101 (321) 453-0212 (321) 453-0223 FAX www.rsandh.com	
DRAWN: JOSEPH HAUER		08-20-2013	NATIONAL AERONAUTICS AND SPACE ADMINISTRATION	
CHECKED: PAUL TAYLOR		08-20-2013	JOHN F. KENNEDY SPACE CENTER, NASA KENNEDY SPACE CENTER, FLORIDA	
SUBMITTED ARCHIVING OF RECORD			LAUNCH COMPLEX 39	
JAMES BALMER			VEHICLE ASSEMBLY BUILDING	
ST. OF LICENSURE: FL			MODIFY VEHICLE ASSEMBLY BUILDING	
LICENSE NO:			HIGH BAY 3 FOR SLS -- HOISTS	
APPROVED:			PLAN	
JOHN KEROSMAR			LEVEL 35	
MIKE HARTNETT			FILE NO. 302-6058-043 SIZE E TOWNSHIP NO. 79K39667	
PROJ. NO. PCN 99000.5		SHEET 17 OF		REV

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SPECIFIC NOTES:

A REMOVE EXISTING W14X142 COLUMN AND SUPPORTING TUBE SHAPED CONNECTORS, DETAILED ON SHEET S-3-172 OF VOL. 5 OF AS-BUILT DRAWINGS, FILE NO. 203-28,297 FROM EL. 430' TO EL. 457'.

B EXTENSIBLE PLATFORM HOIST HOOK.

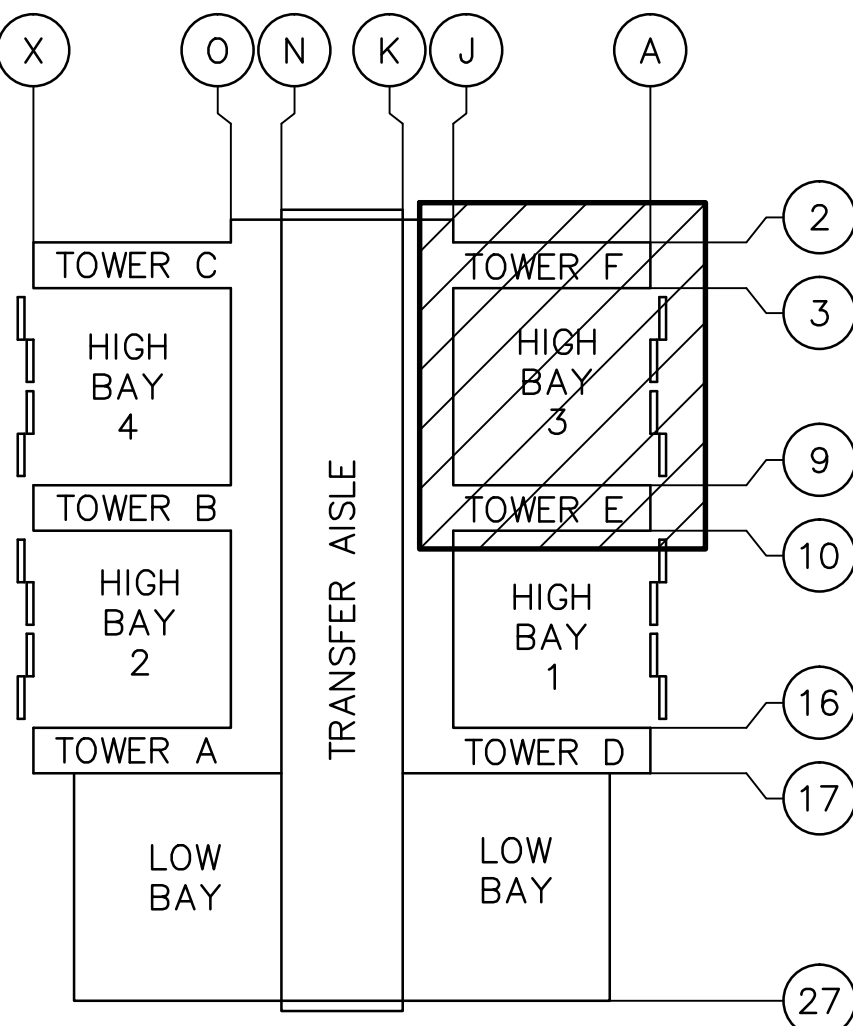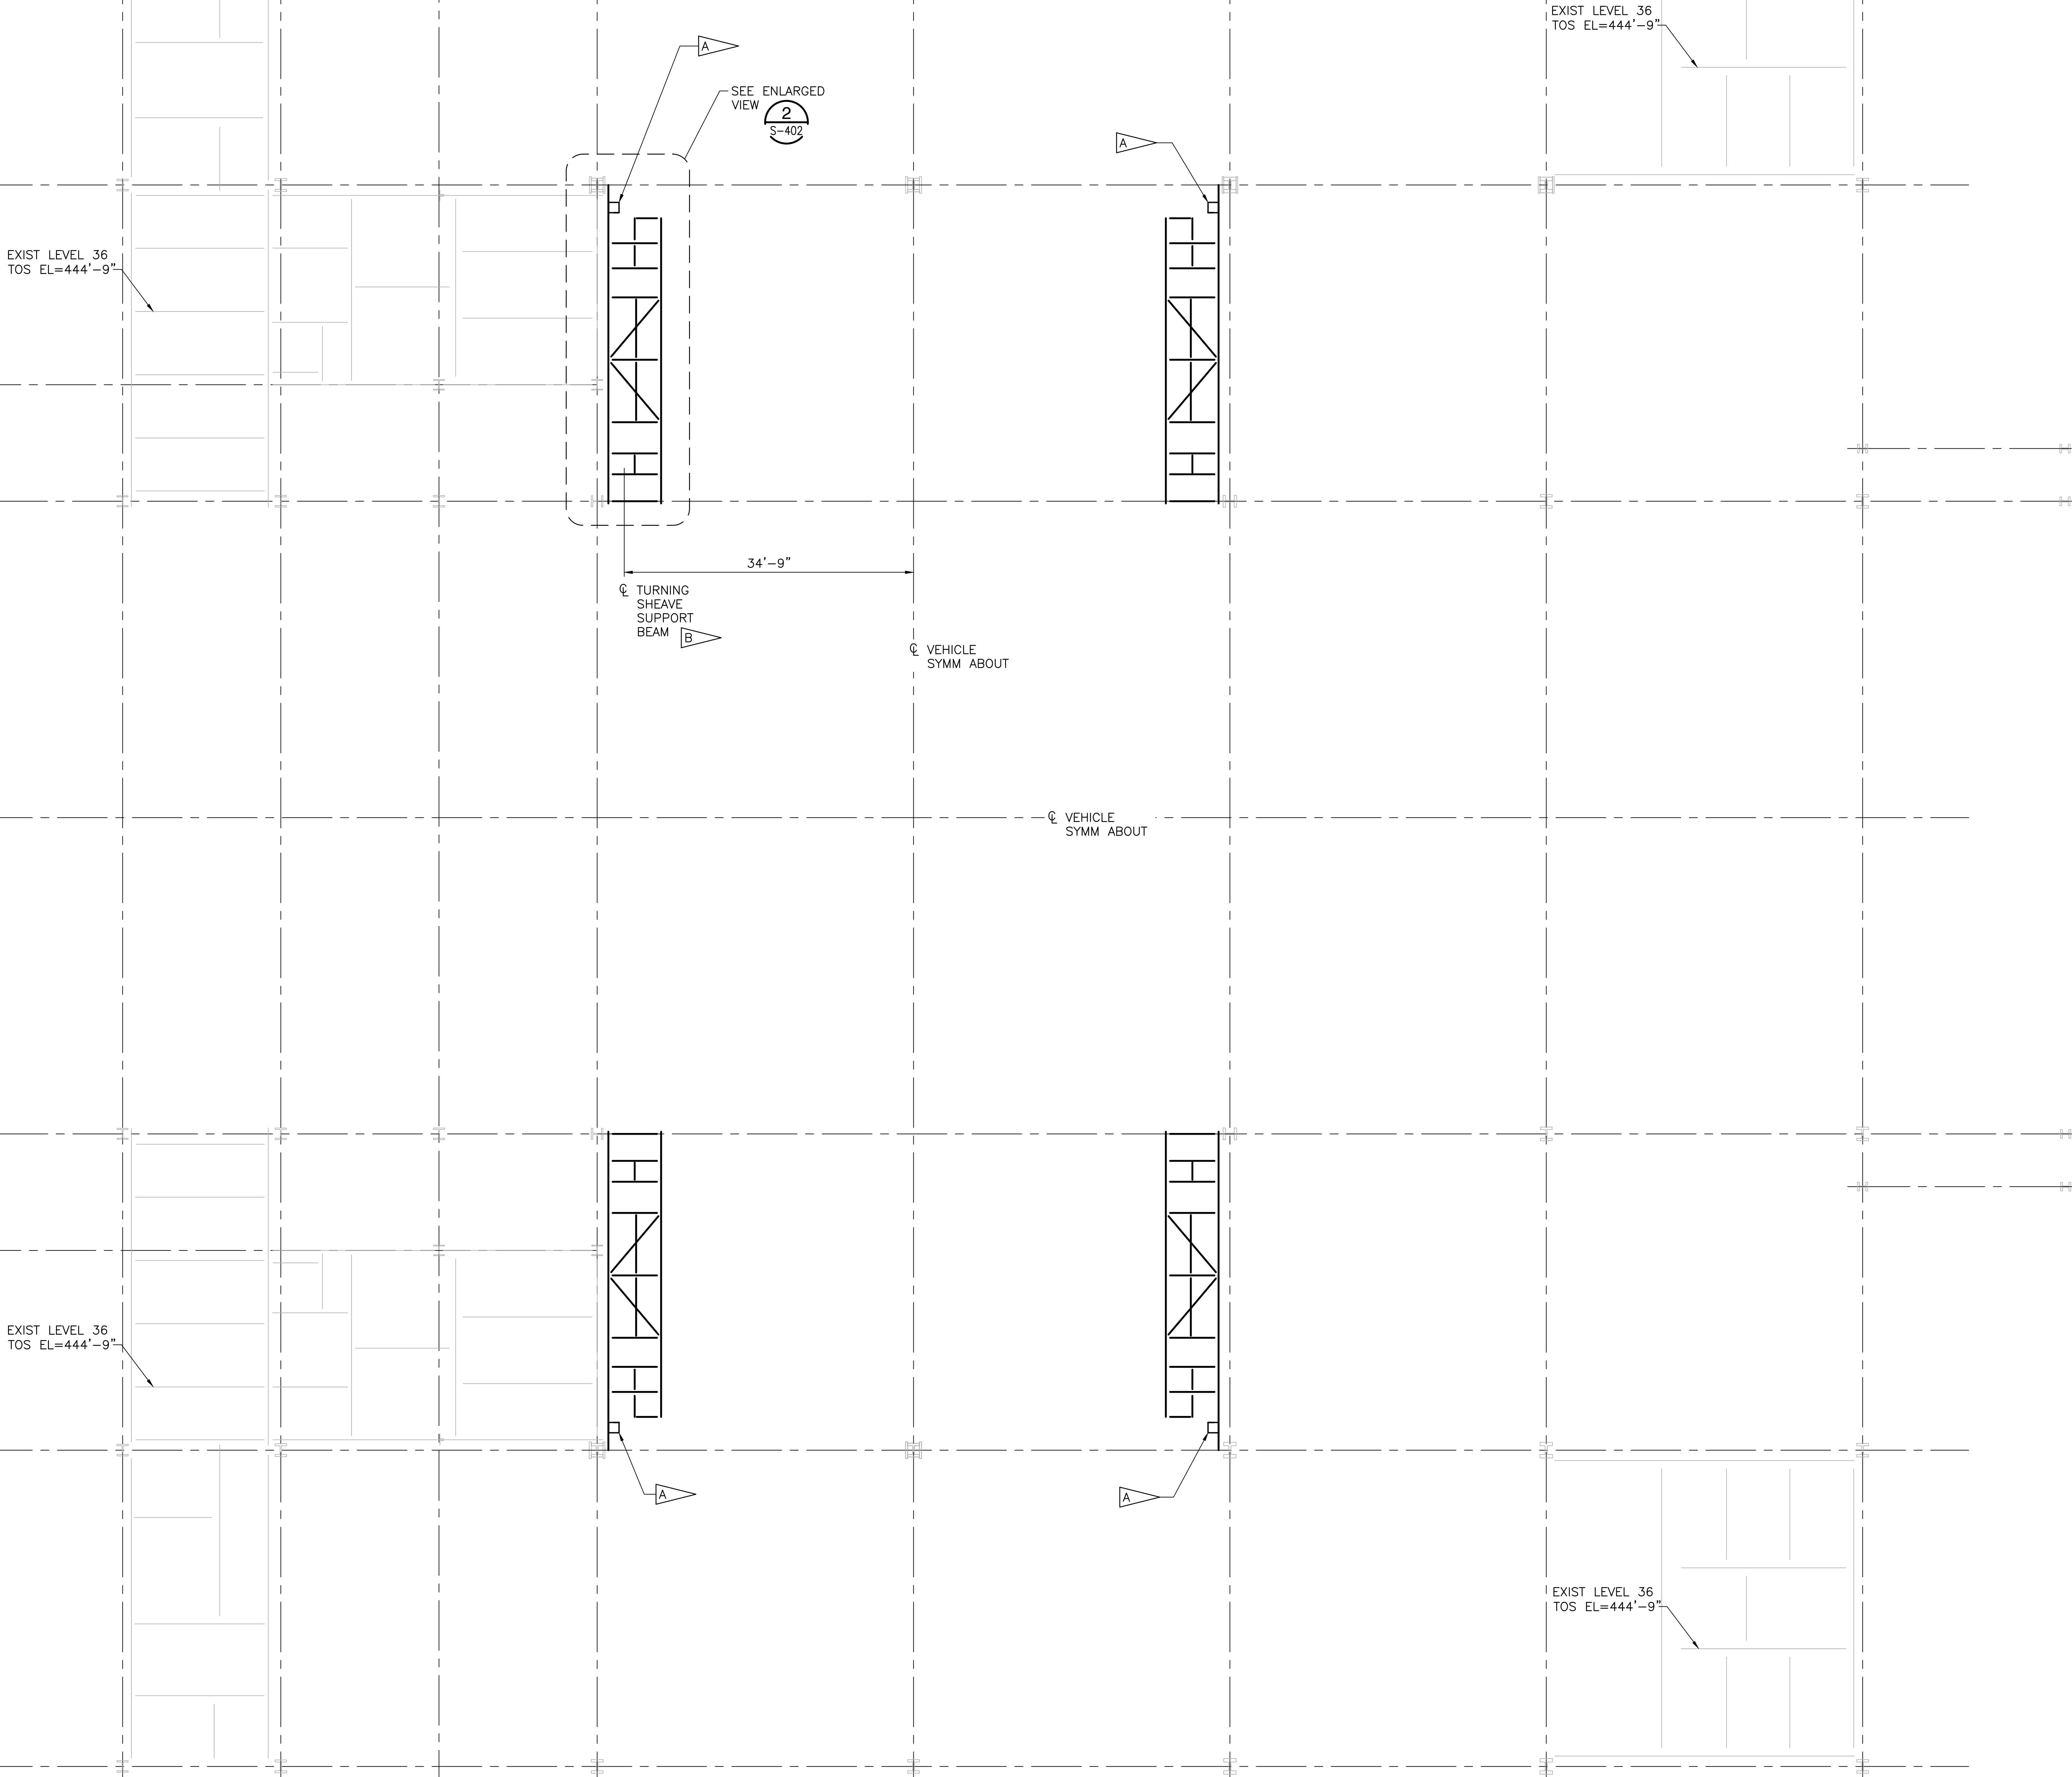

VAB KEY PLAN
SCALE: NTS



FRAMING PLAN
SCALE: 1/8"=1'-0" (TOS EL=447'-9" UON)

WHEN PRINTED FULL SIZE, THIS SHEET IS 34"x44"
THIS COMPUTER DRAWING WAS
CREATED IN AUTOCAD AND
FILED UNDER THE DRAWING NUMBER


S-136

SYM	ZONE	DESCRIPTION	DATE	APPROVAL
REVISIONS				
SIGNATURES		DATE	<div>RSH IMPROVING YOUR WORLD</div> <div>Reynolds, Smith and Hills, Inc. 115 Alma Blvd., Suite 101 Merritt Island, Florida 32953-4101 (321) 453-0212 (321) 453-0223 FAX www.rsandh.com</div> <div>NATIONAL AERONAUTICS AND SPACE ADMINISTRATION JOHN F. KENNEDY SPACE CENTER, NASA KENNEDY SPACE CENTER, FLORIDA</div> <div>LAUNCH COMPLEX 39 VEHICLE ASSEMBLY BUILDING MODIFY VEHICLE ASSEMBLY BUILDING HIGH BAY 3 FOR SLS - HOISTS PLAN LEVEL 36</div>	
DRAWN:	JOSEPH HAUER	08-20-2013		
CHECKED:	PAUL TAYLOR	08-20-2013		
SUBMITTED ARCHIVING OF RECORD				
JAMES BALMER				
ST. OF LICENSURE:	FL			
LICENSE NO.:				
APPROVED:				
JOHN KERESMAR			FILE NO. 302-6058-043	SIZE E
MIKE HARTNETT			PROJ. NO. PCN 99000.5	SIZE TOWNSHIP NO. 79K39667
			SHEET 18	OF

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

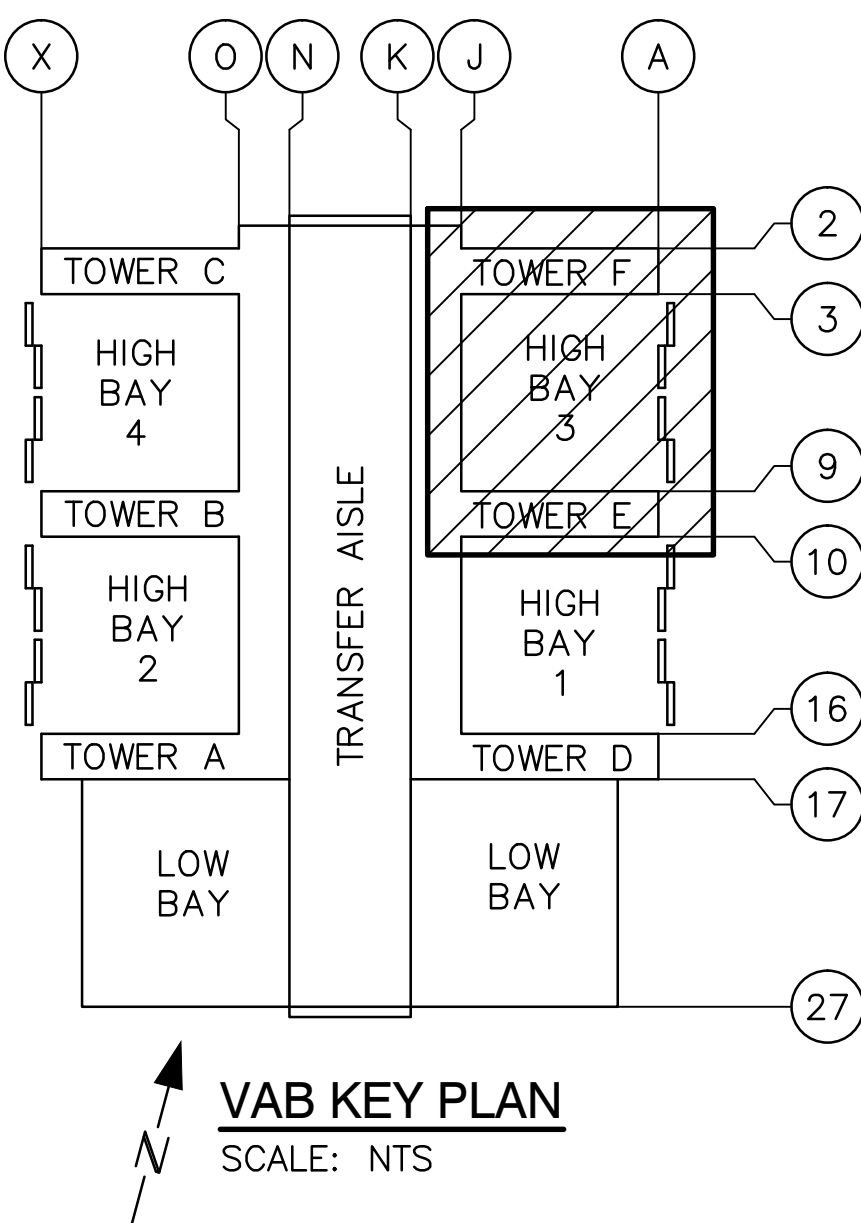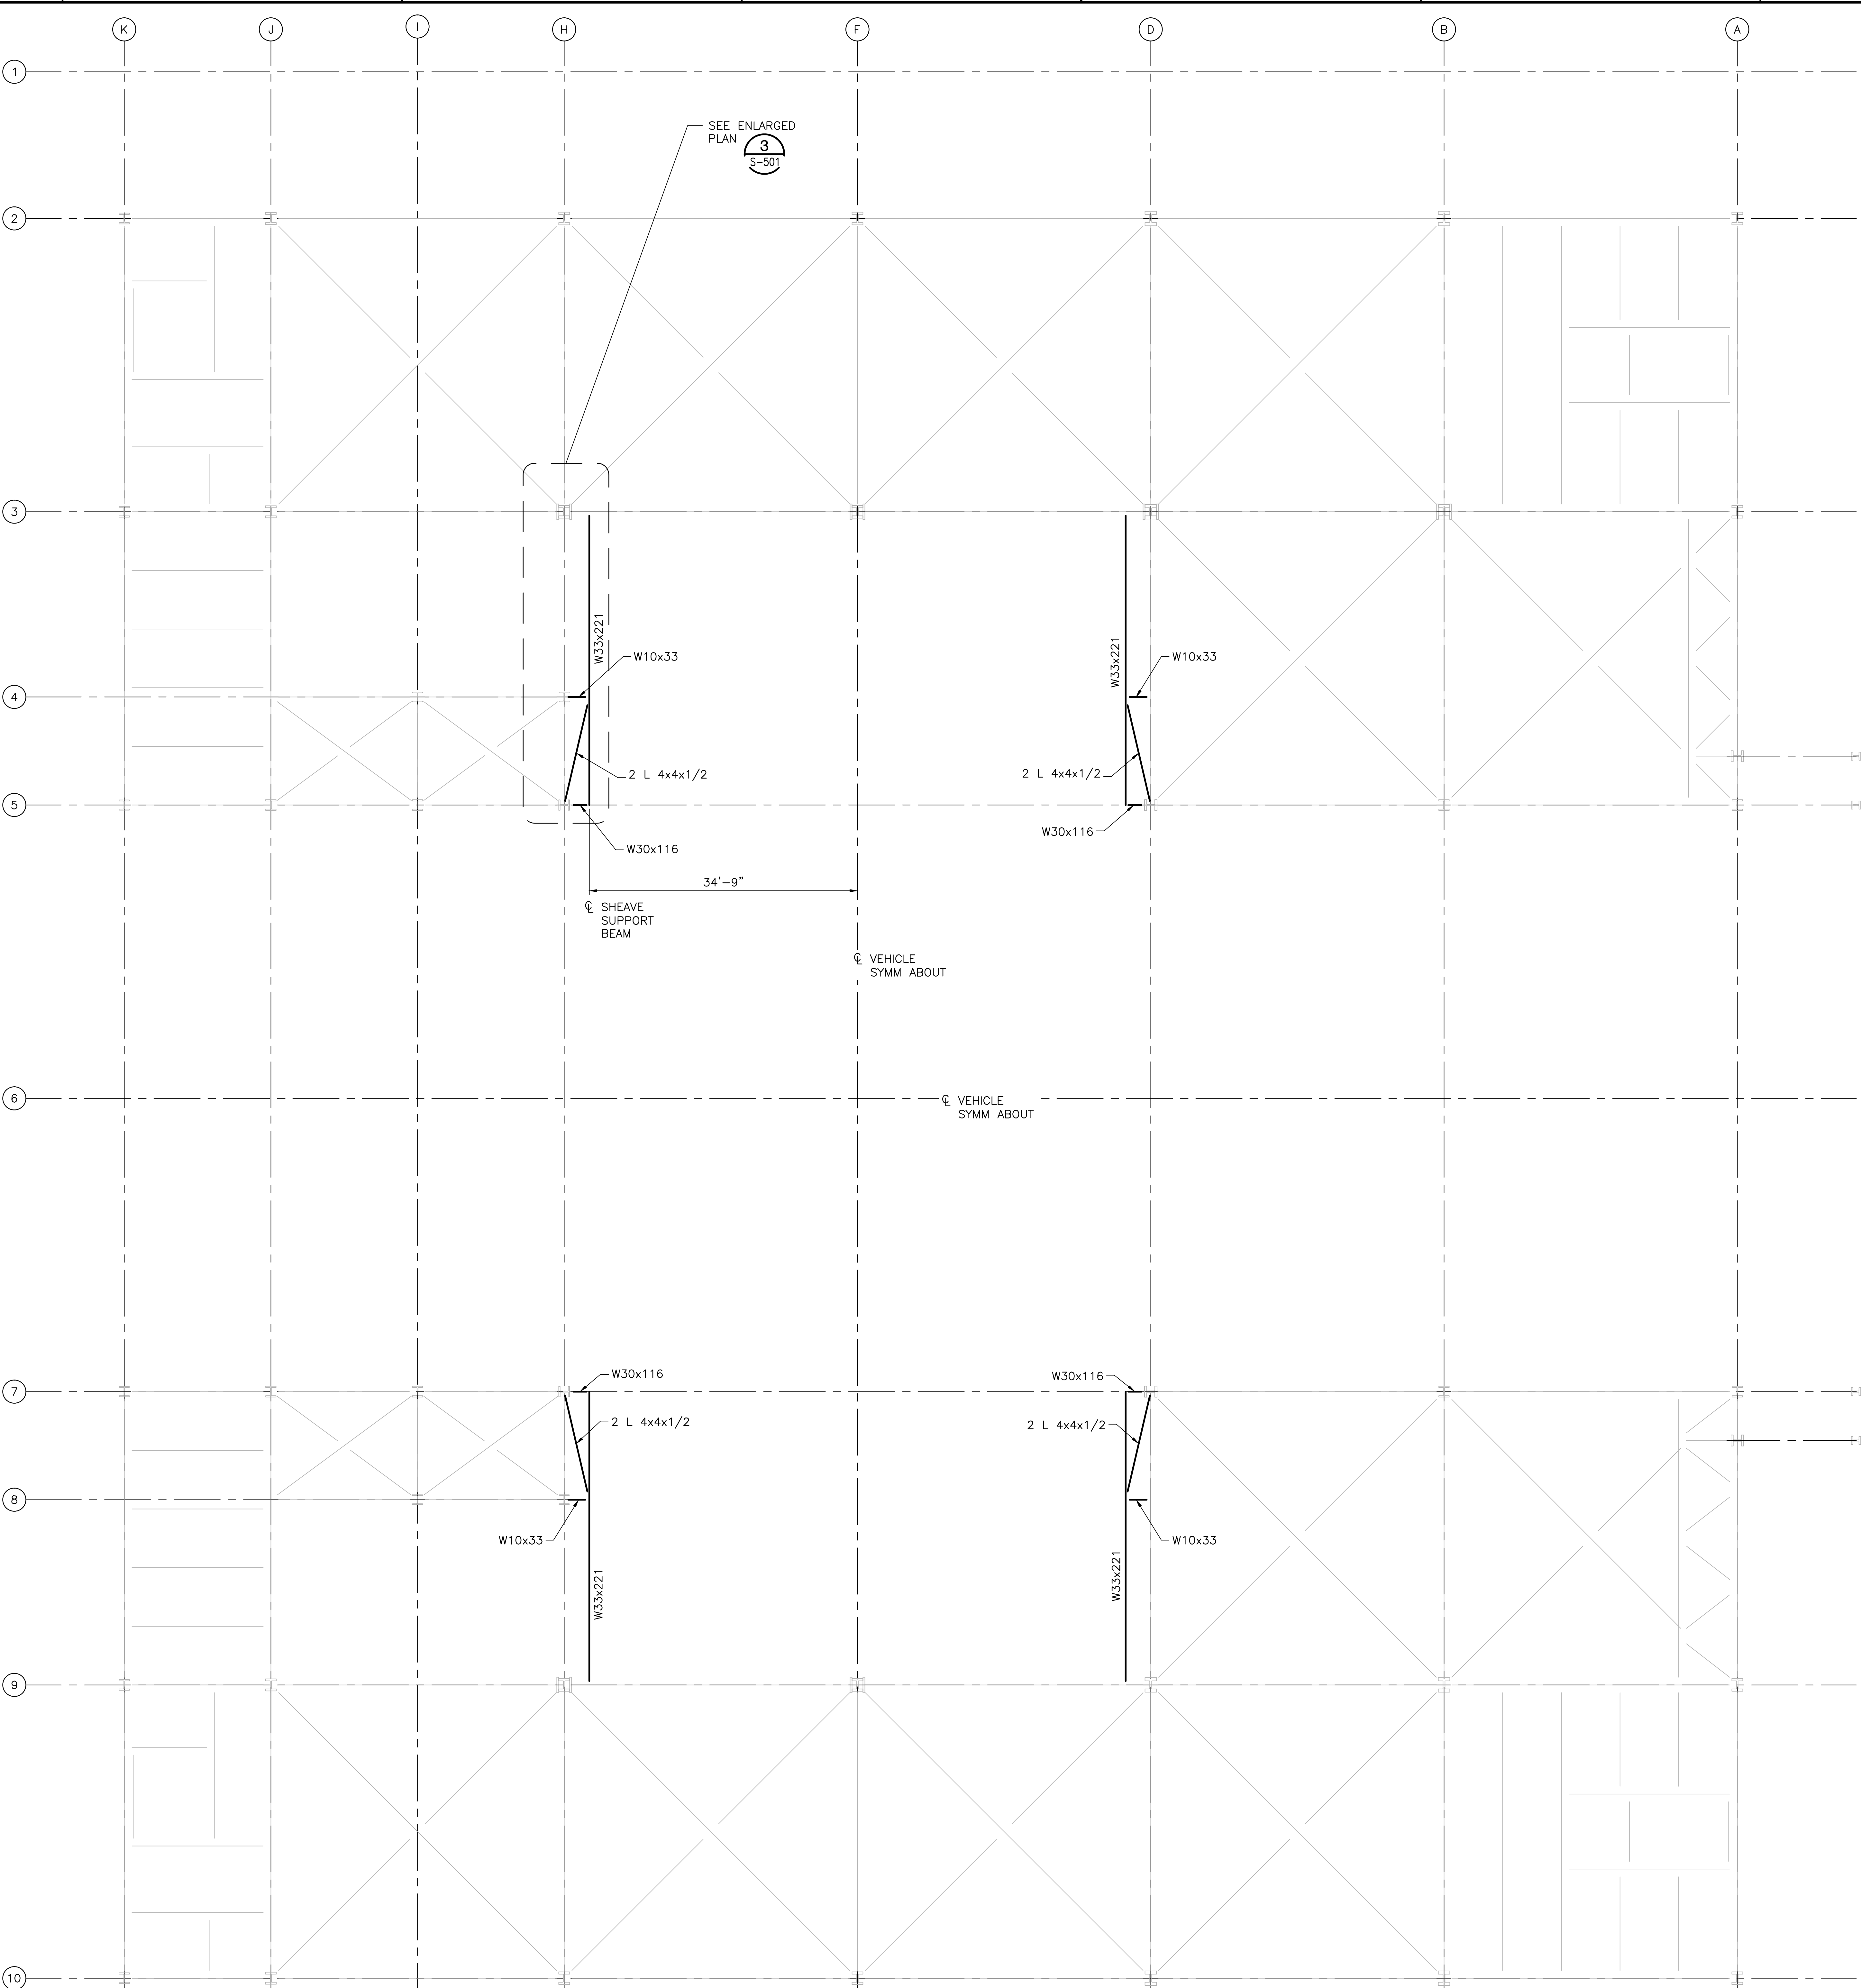
FRAMING PLAN (TOS EL=457'-5" UON)
SCALE: 1/8"=1'-0"

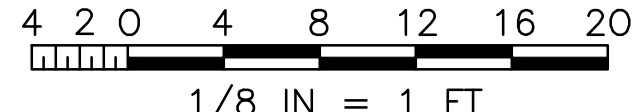


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THIS COMPUTER DRAWING WAS
CREATED IN AUTOCAD AND
FILED UNDER THE DRAWING NUMBER

S-137

SYM	ZONE	DESCRIPTION	DATE	APPROVAL
REVISIONS				
		<div></div> <div>Reynolds, Smith and Hills, Inc. 115 Alma Blvd., Suite 101 Merritt Island, Florida 32953-4101 (321) 453-0212 (321) 453-0223 FAX www.rsandh.com</div>		
SIGNATURES			DATE	NATIONAL AERONAUTICS AND SPACE ADMINISTRATION
DRAWN: LYNN SWEENEY	08-20-2013		JOHN F. KENNEDY SPACE CENTER, NASA KENNEDY SPACE CENTER, FLORIDA	
CHECKED: PAUL TAYLOR	08-20-2013		LAUNCH COMPLEX 39 VEHICLE ASSEMBLY BUILDING	
SUBMITTED ARCHIVING OF RECORD			MODIFY VEHICLE ASSEMBLY BUILDING HIGH BAY 3 FOR SLS -- HOISTS PLAN LEVEL 37	
JAMES DALMER				
ST. OF LICENSURE: FL				
LICENSE NO:				
APPROVED:				
JOHN KERESMAR			FILE NO.	SIZE DWG. NO.
		302-6058-043	E	79K39667
MIKE HARTNETT		PROJ. NO.	PCN 99000.5	SHEET 19 OF

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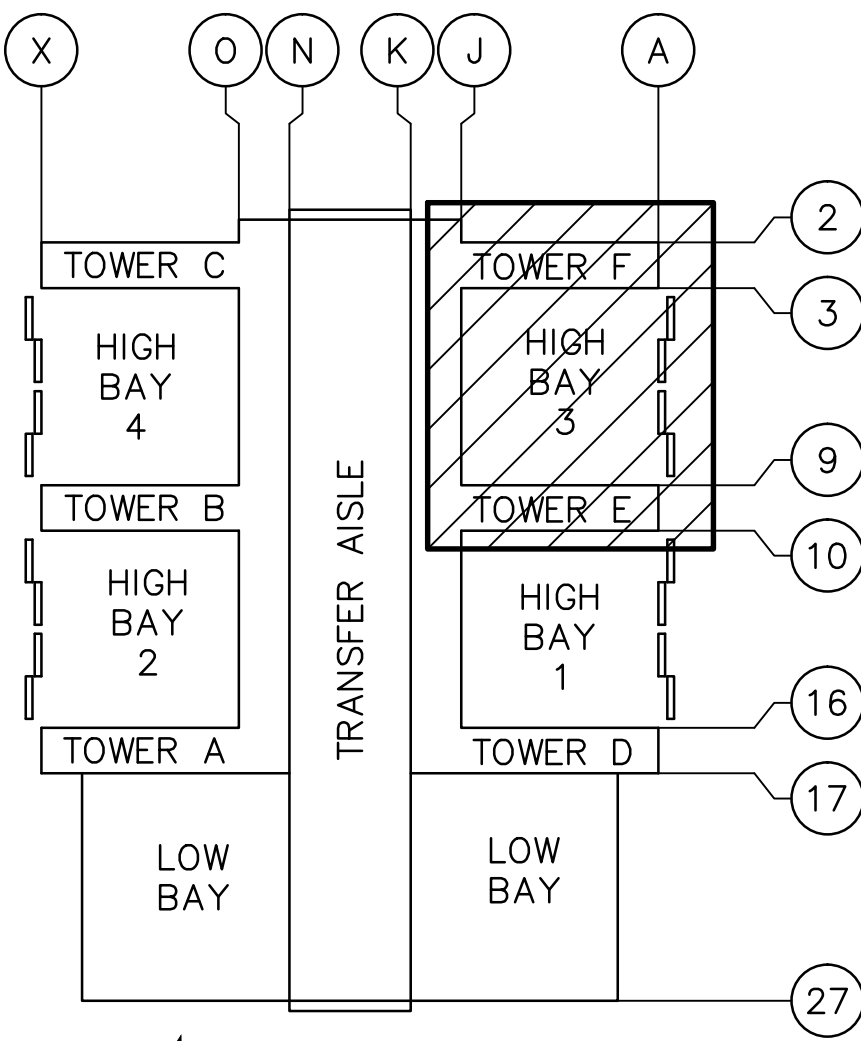


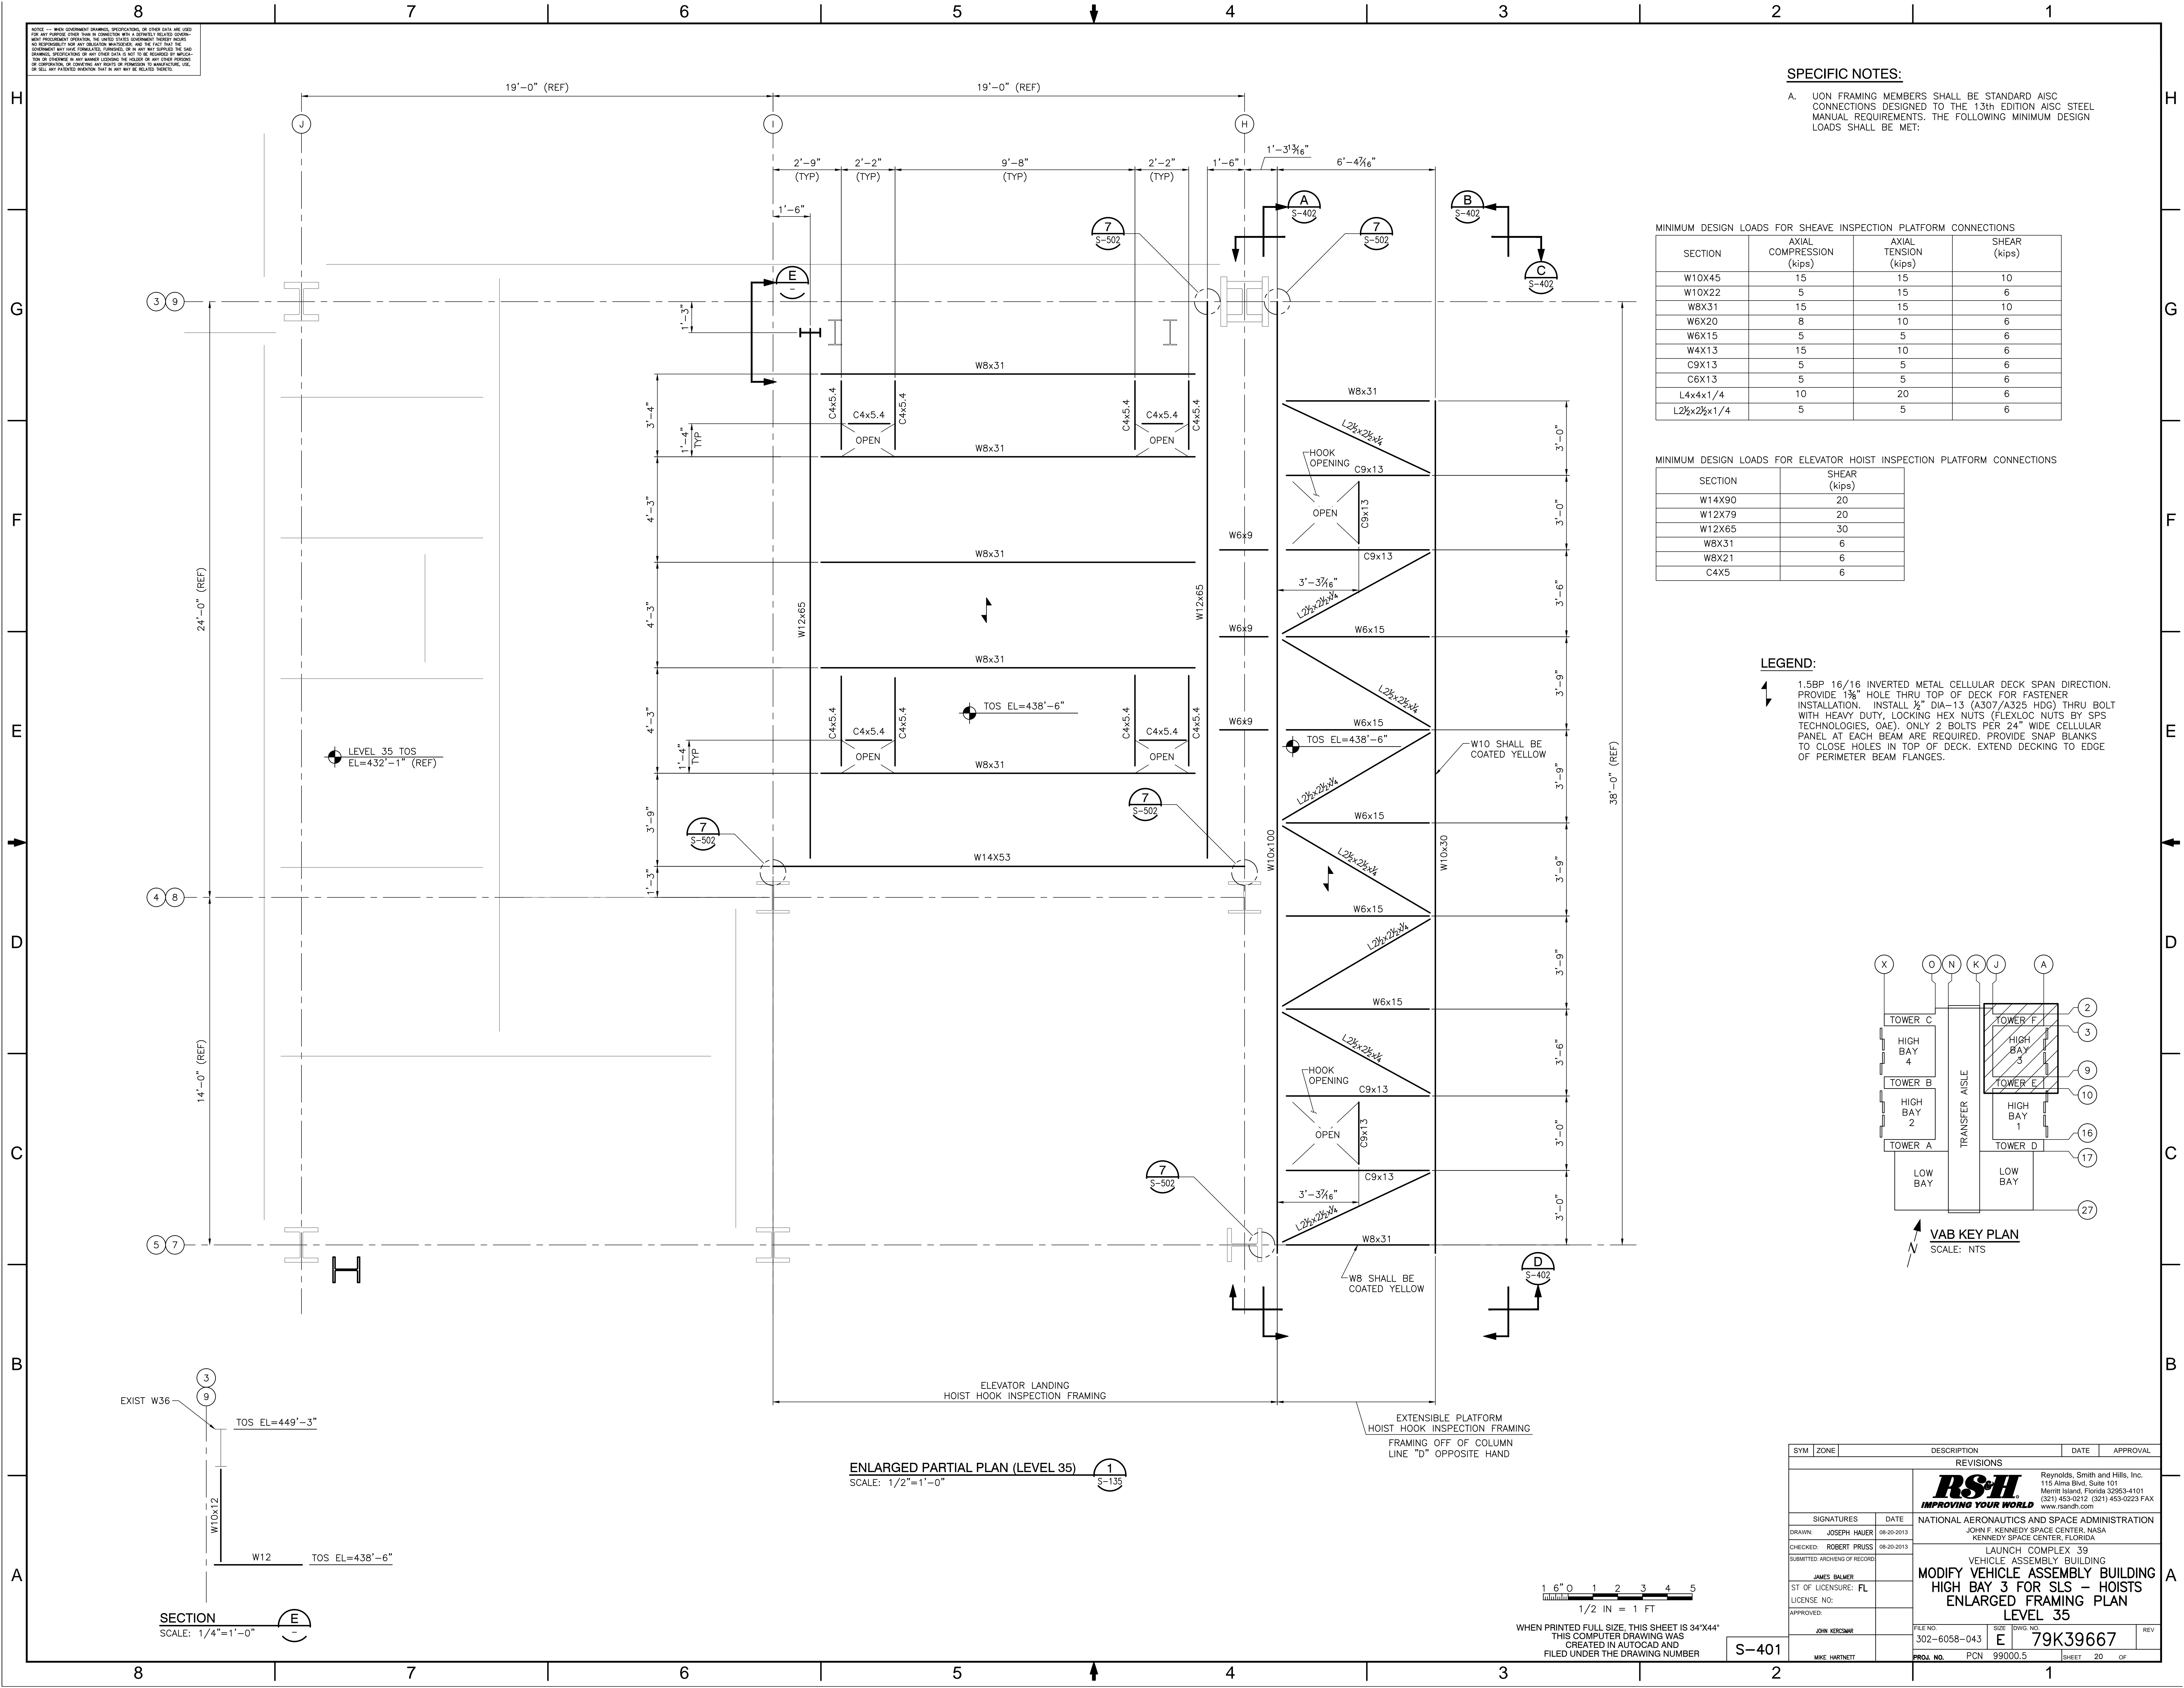MINIMUM DESIGN LOADS FOR SHEAVE		INSPECTION PLATFORM CONNECTIONS	
SECTION	AXIAL COMPRESSION (kips)	AXIAL TENSION (kips)	SHEAR (kips)
W10X45	15	15	10
W10X22	5	15	6
W8X31	15	15	10
W6X20	8	10	6
W6X15	5	5	6
W4X13	15	10	6
C9X13	5	5	6
C6X13	5	5	6
L4x4x1/4	10	20	6
L2½x2½x1/4	5	5	6


SECTION	SHEAR (kips)
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W12X79	20
W12X65	30
W8X31	6
W8X21	6
C4X5	6

LEGEND:


1.5BP 16/16 INVERTED METAL CELLULAR DECK SPAN DIRECTION.
PROVIDE 1 1/2" HOLE THRU TOP OF DECK FOR FASTENER
INSTALLATION. INSTALL 2" DIA-13 (A307/A325 HGT) THRU BOLT
WITH HEAVY DUTY, LOCKING HEX NUTS (FLEXLOC NUTS BY SPS
TECHNOLOGIES, OAE). ONLY 2 BOLTS PER 24" WIDE CELLULAR
PANEL AT EACH BEAM ARE REQUIRED. PROVIDE SNAP BLANKS
TO CLOSE HOLES IN TOP OF DECK. EXTEND DECKING TO EDGE
OF PERIMETER BEAM FLANGES.



VAB KEY PLAN
SCALE: NTS

SYM	ZONE	DESCRIPTION	DATE	APPROVAL
REVISONS				
		 Reynolds, Smith and Hills, Inc. 115 Alma Blvd, Suite 101 Merritt Island, Florida 32953-4101 (321) 453-0212 (321) 453-0223 FAX www.rsandh.com		
SIGNATURES		DATE		
DRAWN: JOSEPH HAUER		08-20-2013		
CHECKED: ROBERT PRUSS		08-20-2013		
SUBMITTED: ARCHIVING OF RECORD				
JAMES BALMER				
ST. OF LICENSENO: FL				
LICENSE NO:				
APPROVED:				
JOHN KERISMAW				
MIKE HARTNETT				
		NATIONAL AERONAUTICS AND SPACE ADMINISTRATION JOHN F. KENNEDY SPACE CENTER, NASA KENNEDY SPACE CENTER, FLORIDA LAUNCH COMPLEX 39 VEHICLE ASSEMBLY BUILDING MODIFY VEHICLE ASSEMBLY BUILDING HIGH BAY 3 FOR SLS - HOISTS ENLARGED FRAMING PLAN LEVEL 35		
FILE NO.		SIZE		DWG. NO.
302-6058-043		E		79K39667
PROJ. NO.		PCN		9900.5
		SHEET		20 OF

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NOTE: -- WHEN GOVERNMENT DRAWINGS, SPECIFICATIONS, OR OTHER DATA ARE USED FOR ANY PURPOSE OTHER THAN IN CONNECTION WITH A SPECIFIC PROJECT, THE USER SHALL BE RESPONSIBLE FOR ANY OMISSIONS, ERRORS, AND THE FACT THAT THE GOVERNMENT HAS NOT CONDUCTED, THROUGHOUT, OF ANY PART THEREOF, THE SAME. SPECIFICATIONS OF ANY OTHER DATA IS NOT TO BE REQUIRED BY REFERENCE TO SPECIFICATIONS IN ANY MANNER, INCLUDING THE OMISSION OF ANY OTHER PORTION OF CONTRACT, OR CONVEYING ANY RIGHT OF INFRINGEMENT TO MANUFACTURE, USE, OR SELL ANY PATENTED INVENTION THAT IS ANY WAY BE RELATED THEREOF.

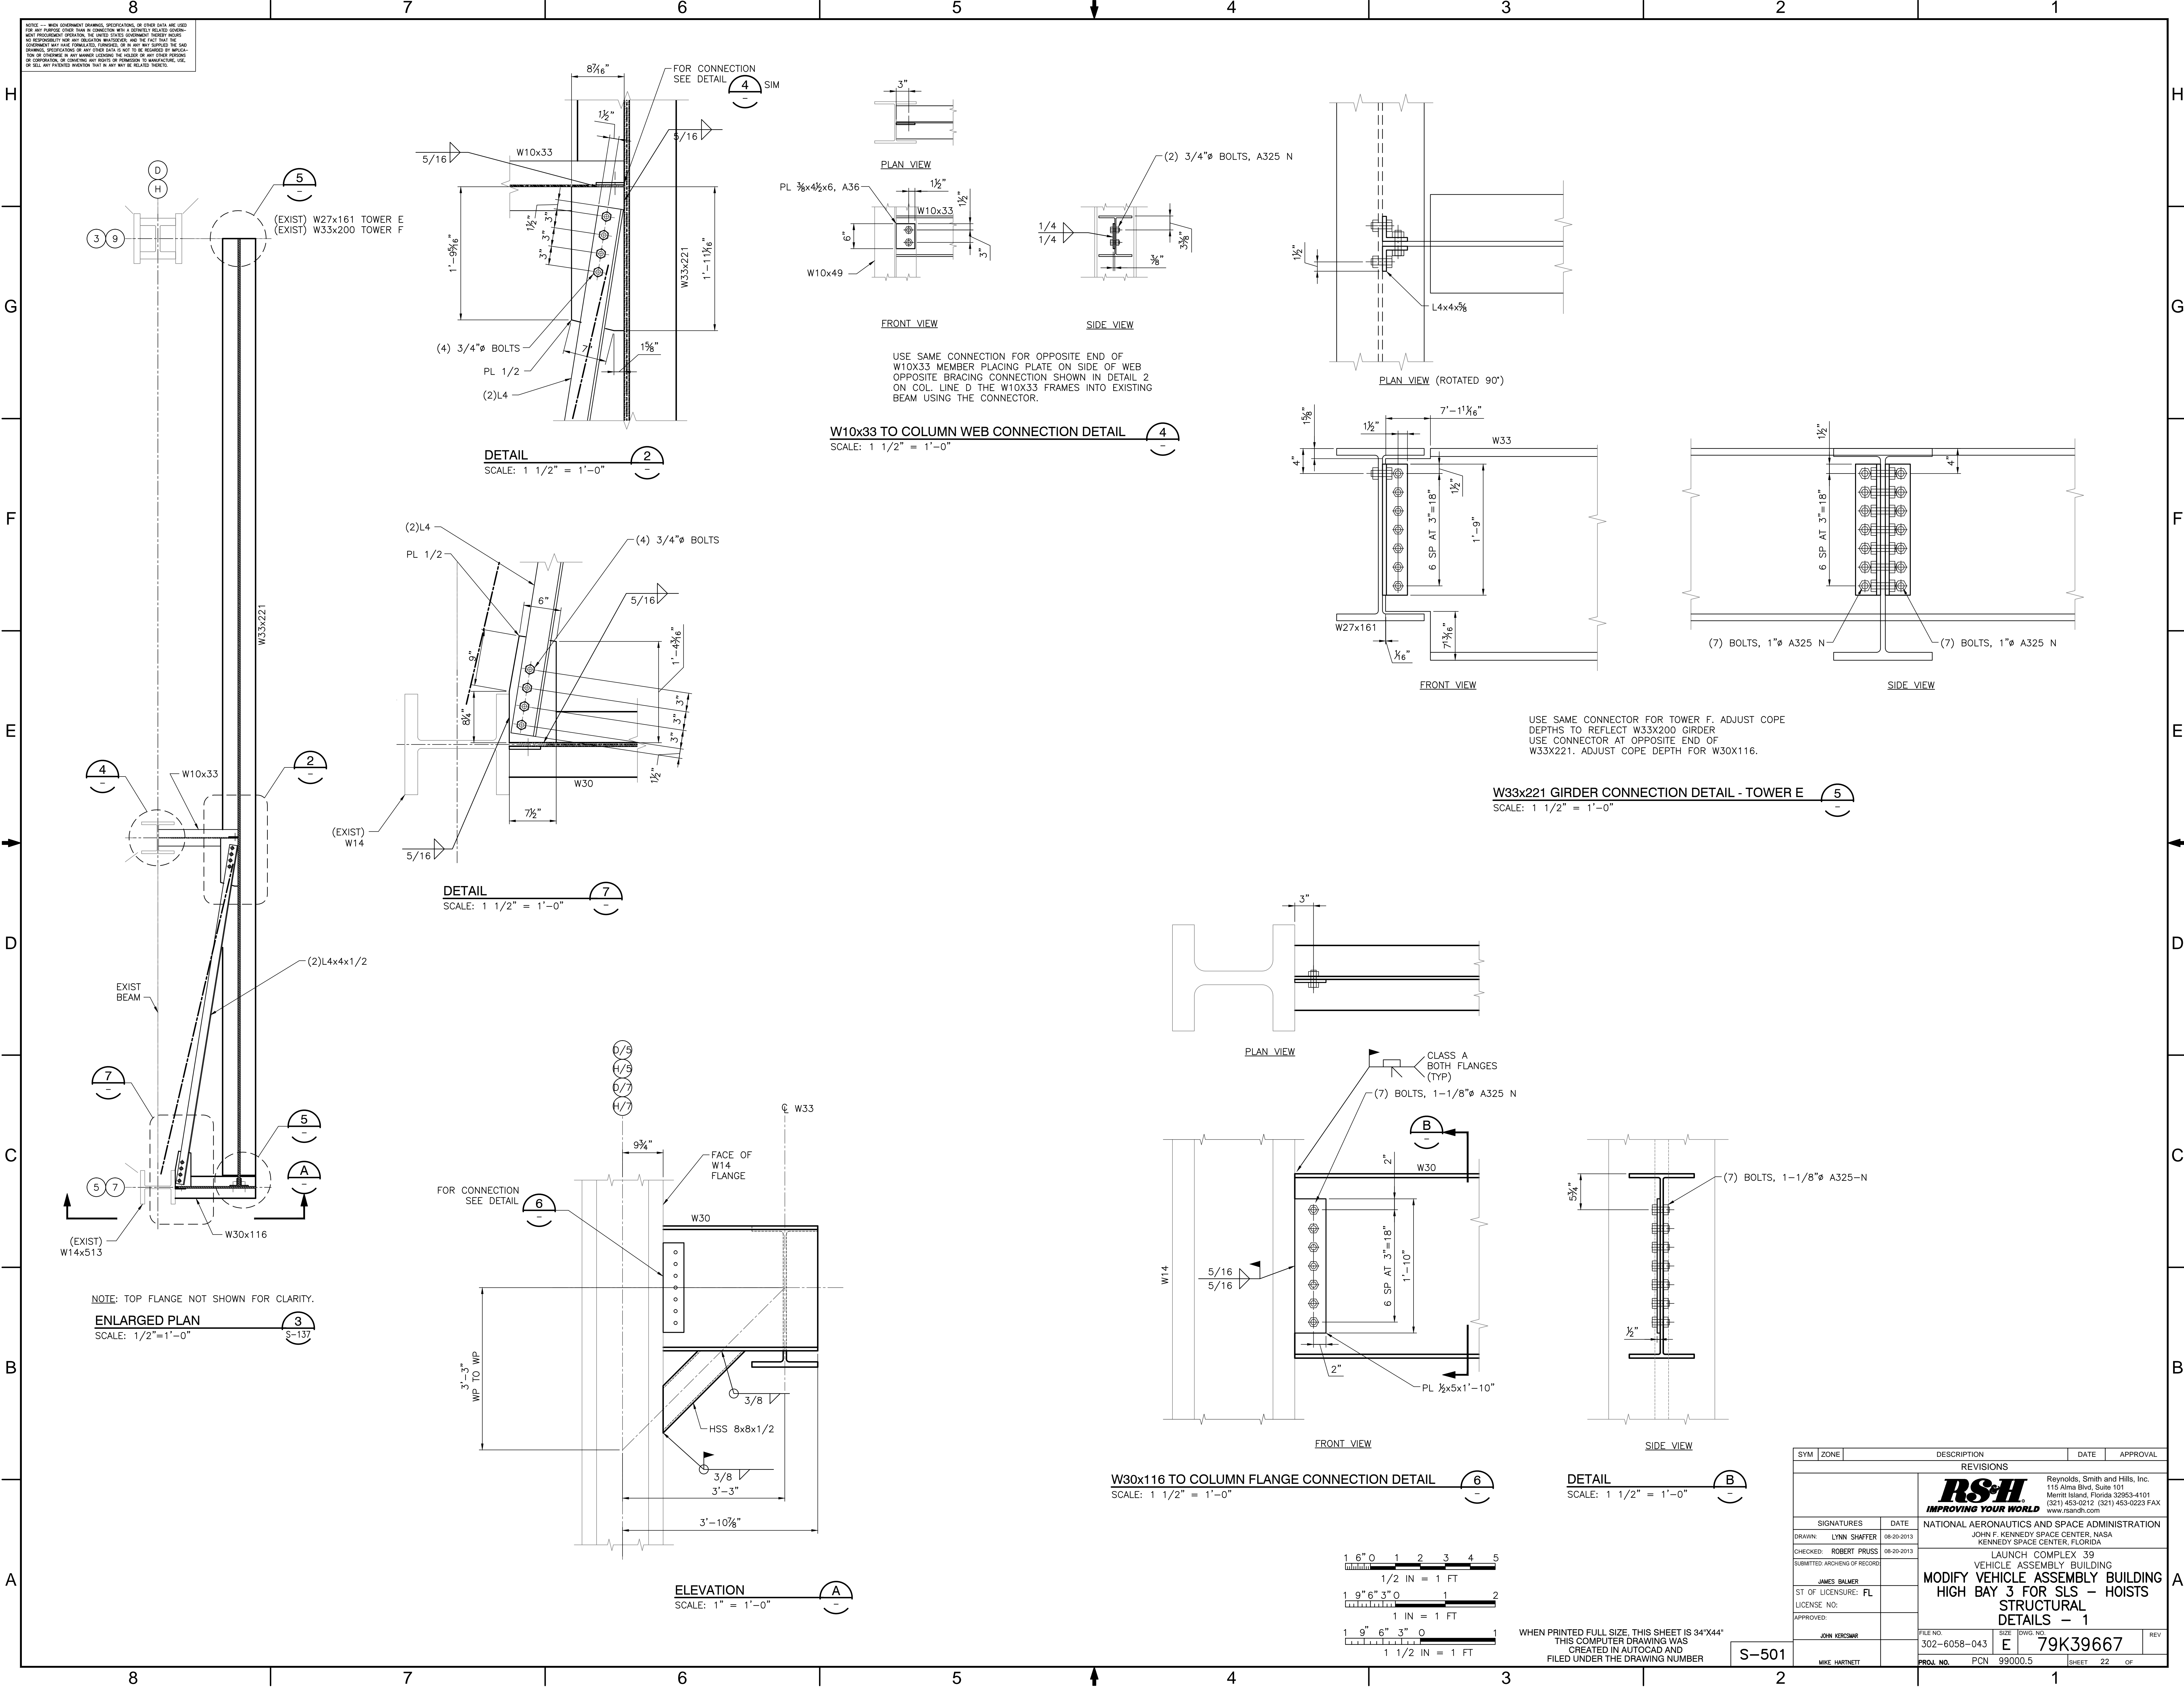H

G

F


E

D


C

B


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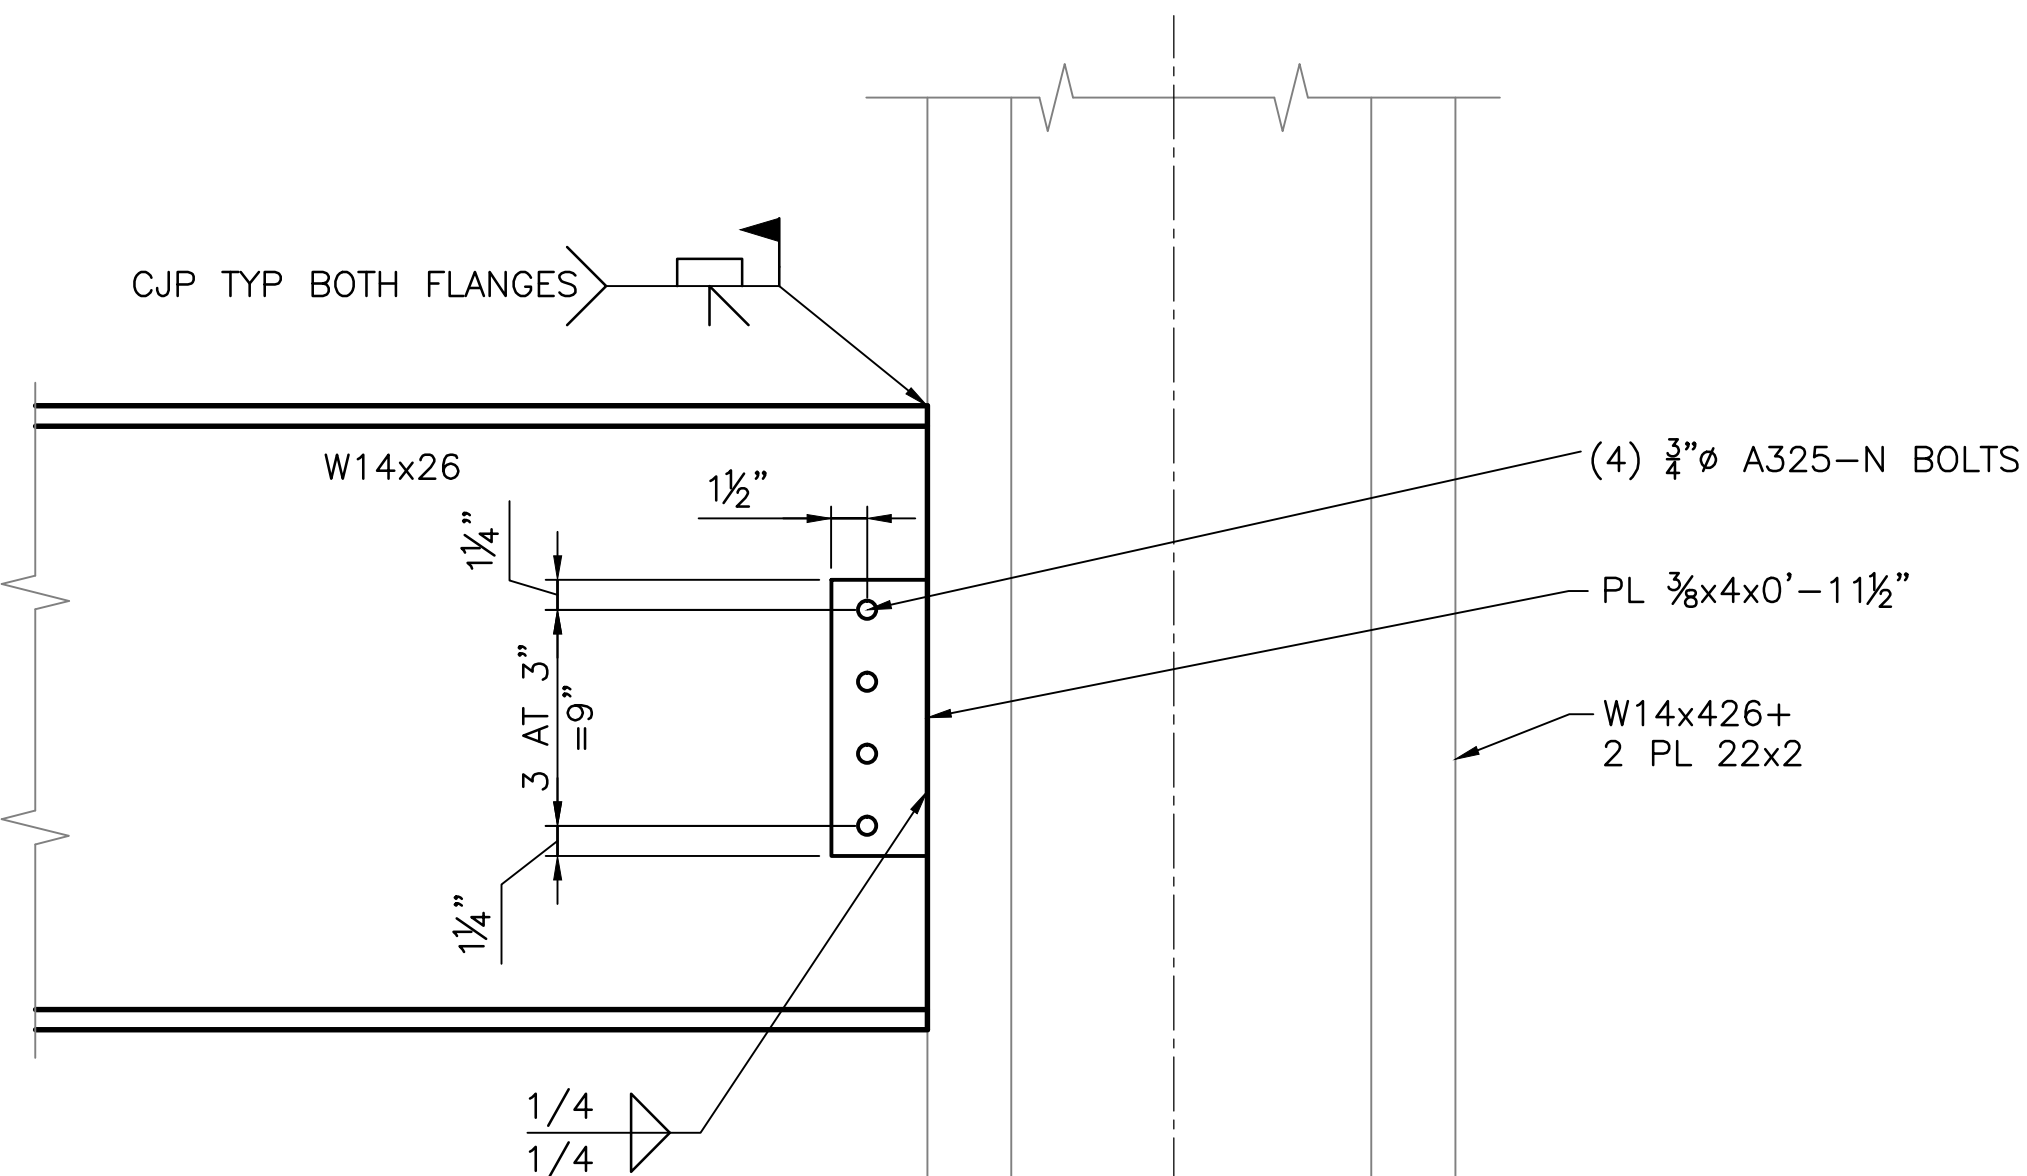
DETAIL 4
SCALE: 1/2" = 1'-0" S-135

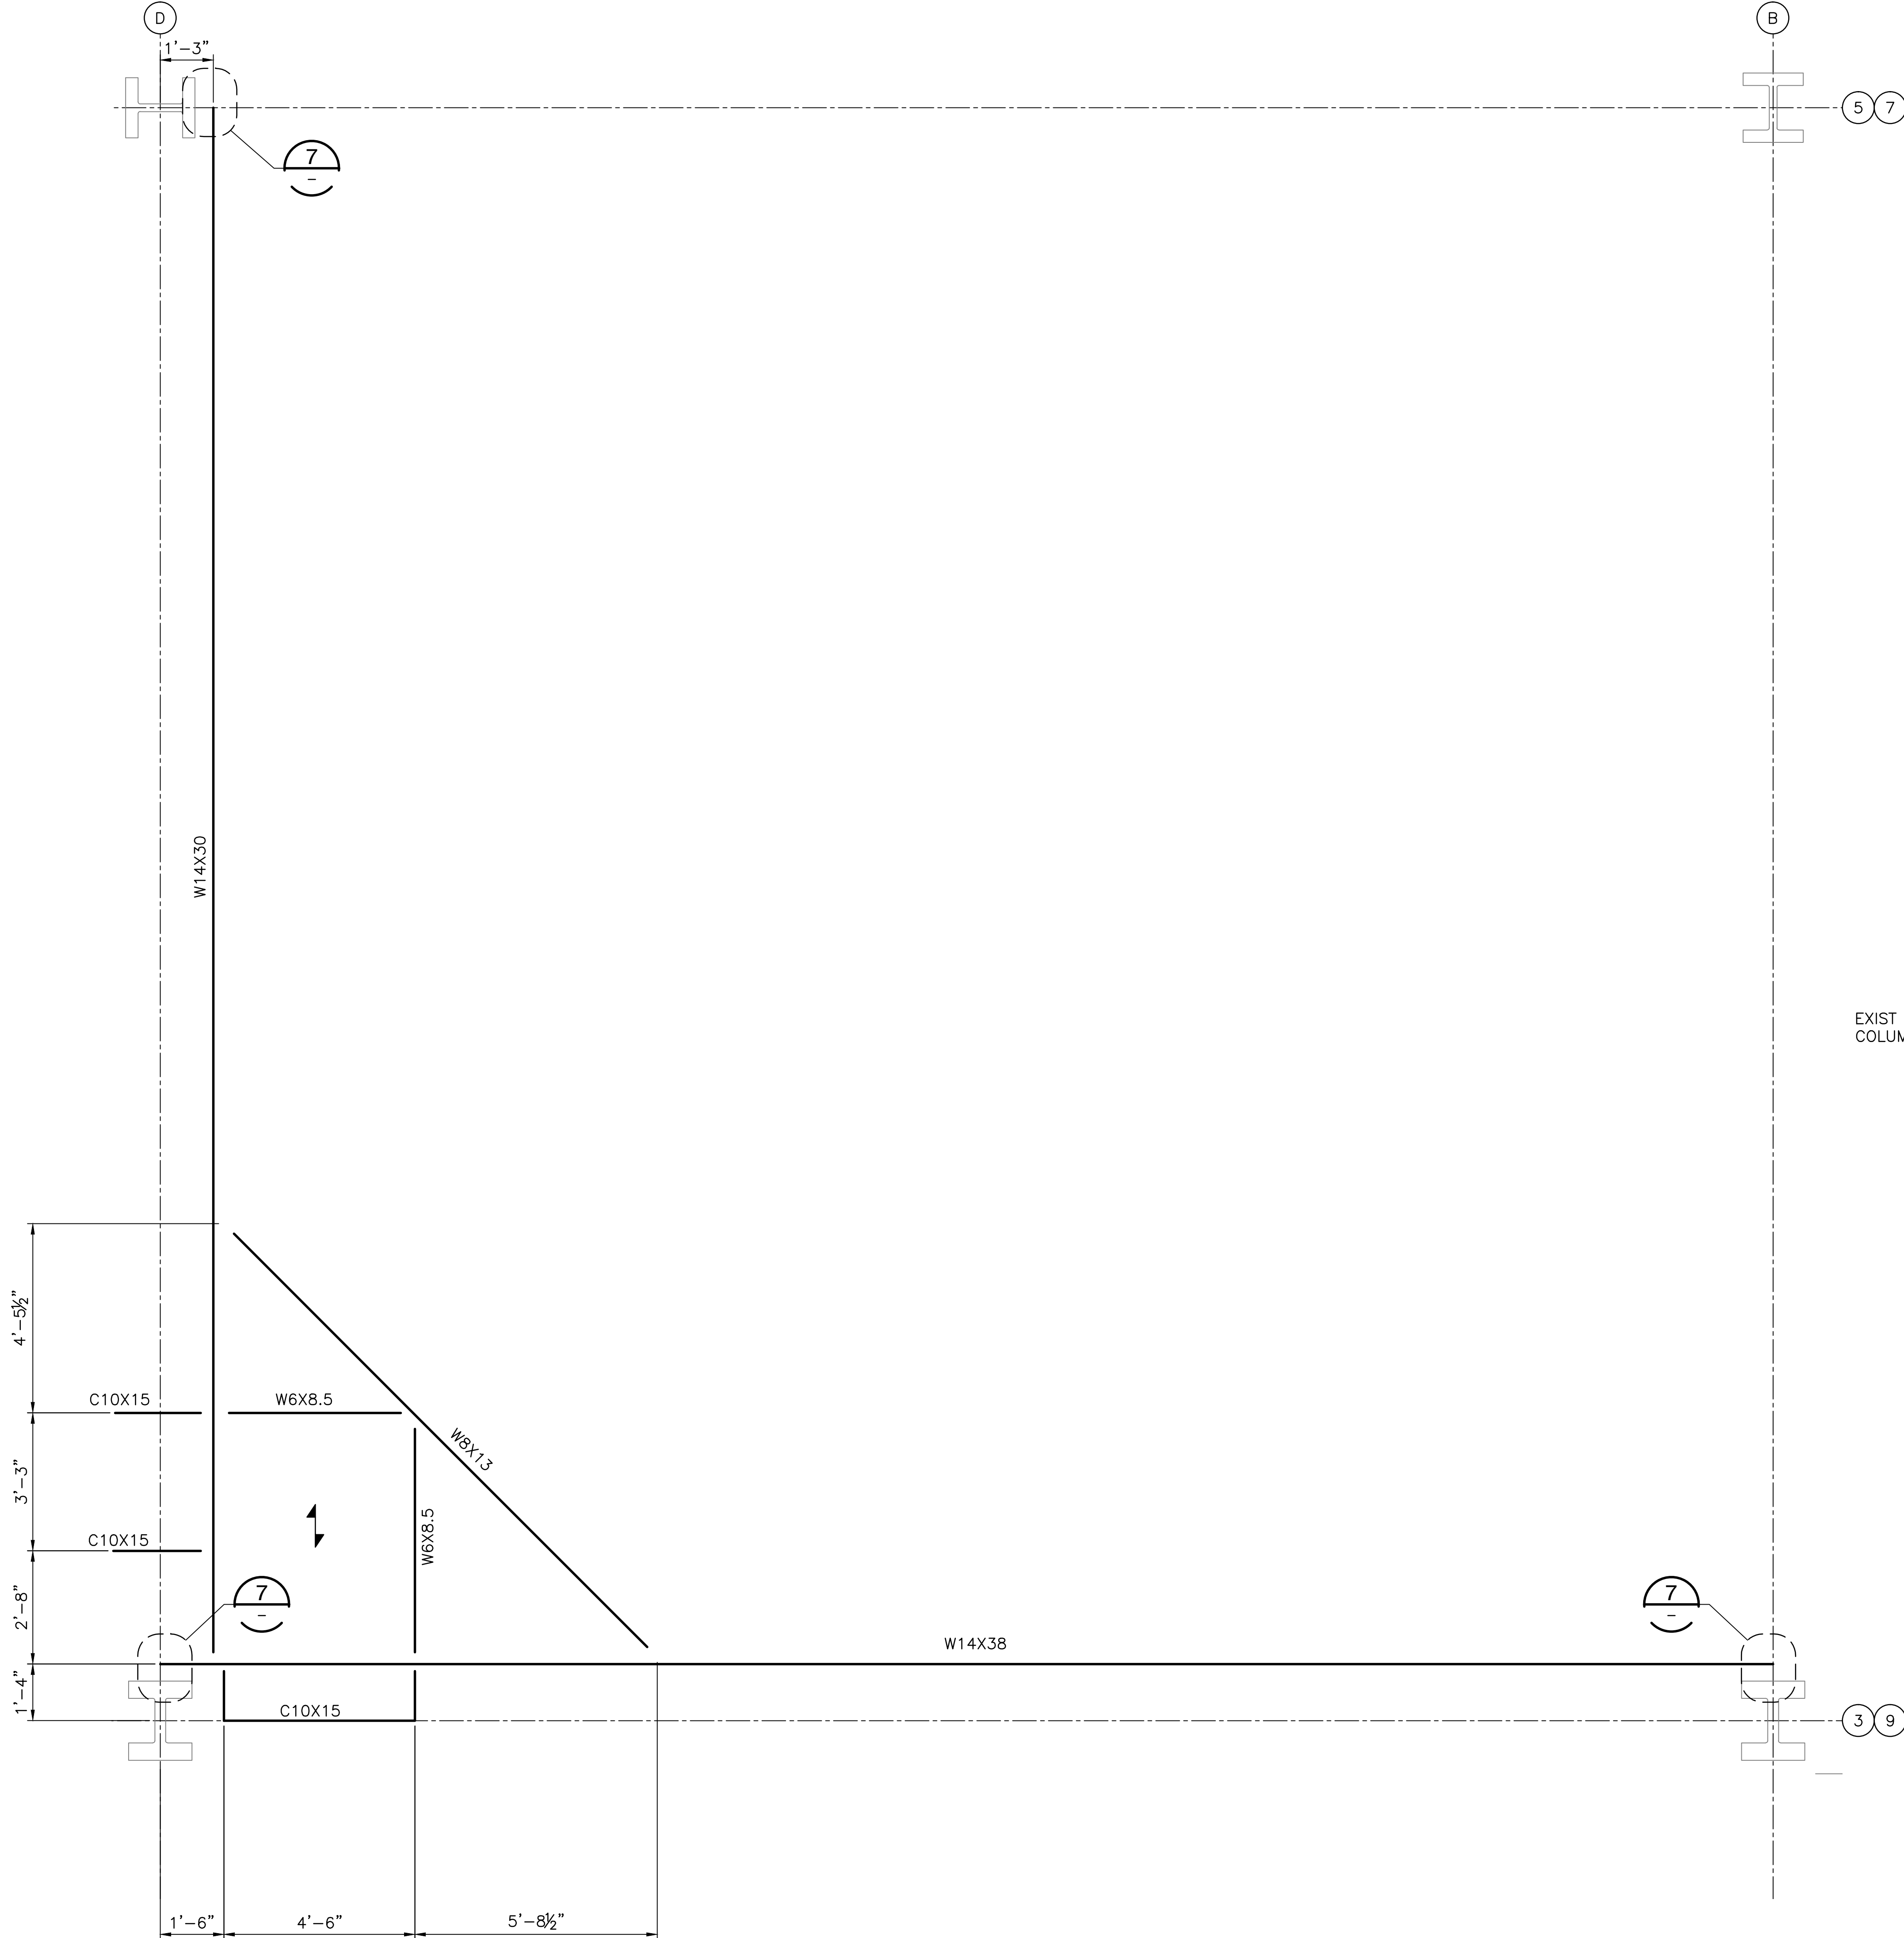


SECTION B
SCALE: 1 1/2"=1'-0"

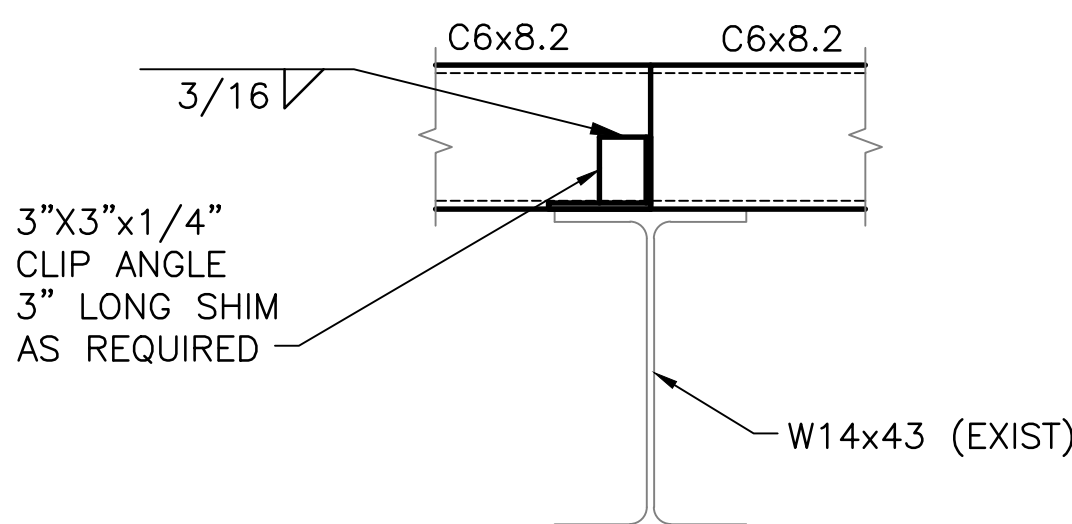


DETAIL PLAN A
SCALE: 1 1/2"=1'-0"

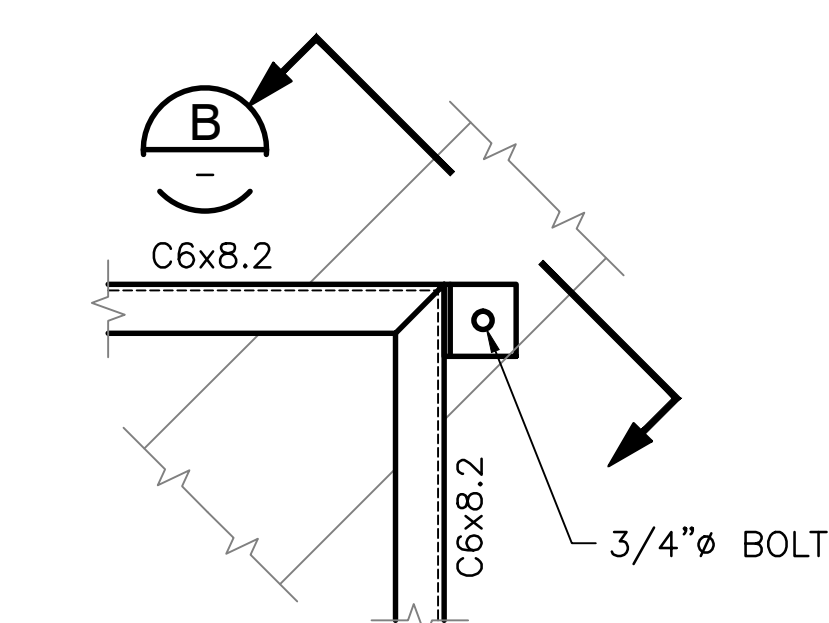


COLUMN CONNECTION DETAIL 8
SCALE: 1 1/2"=1'-0" S-401

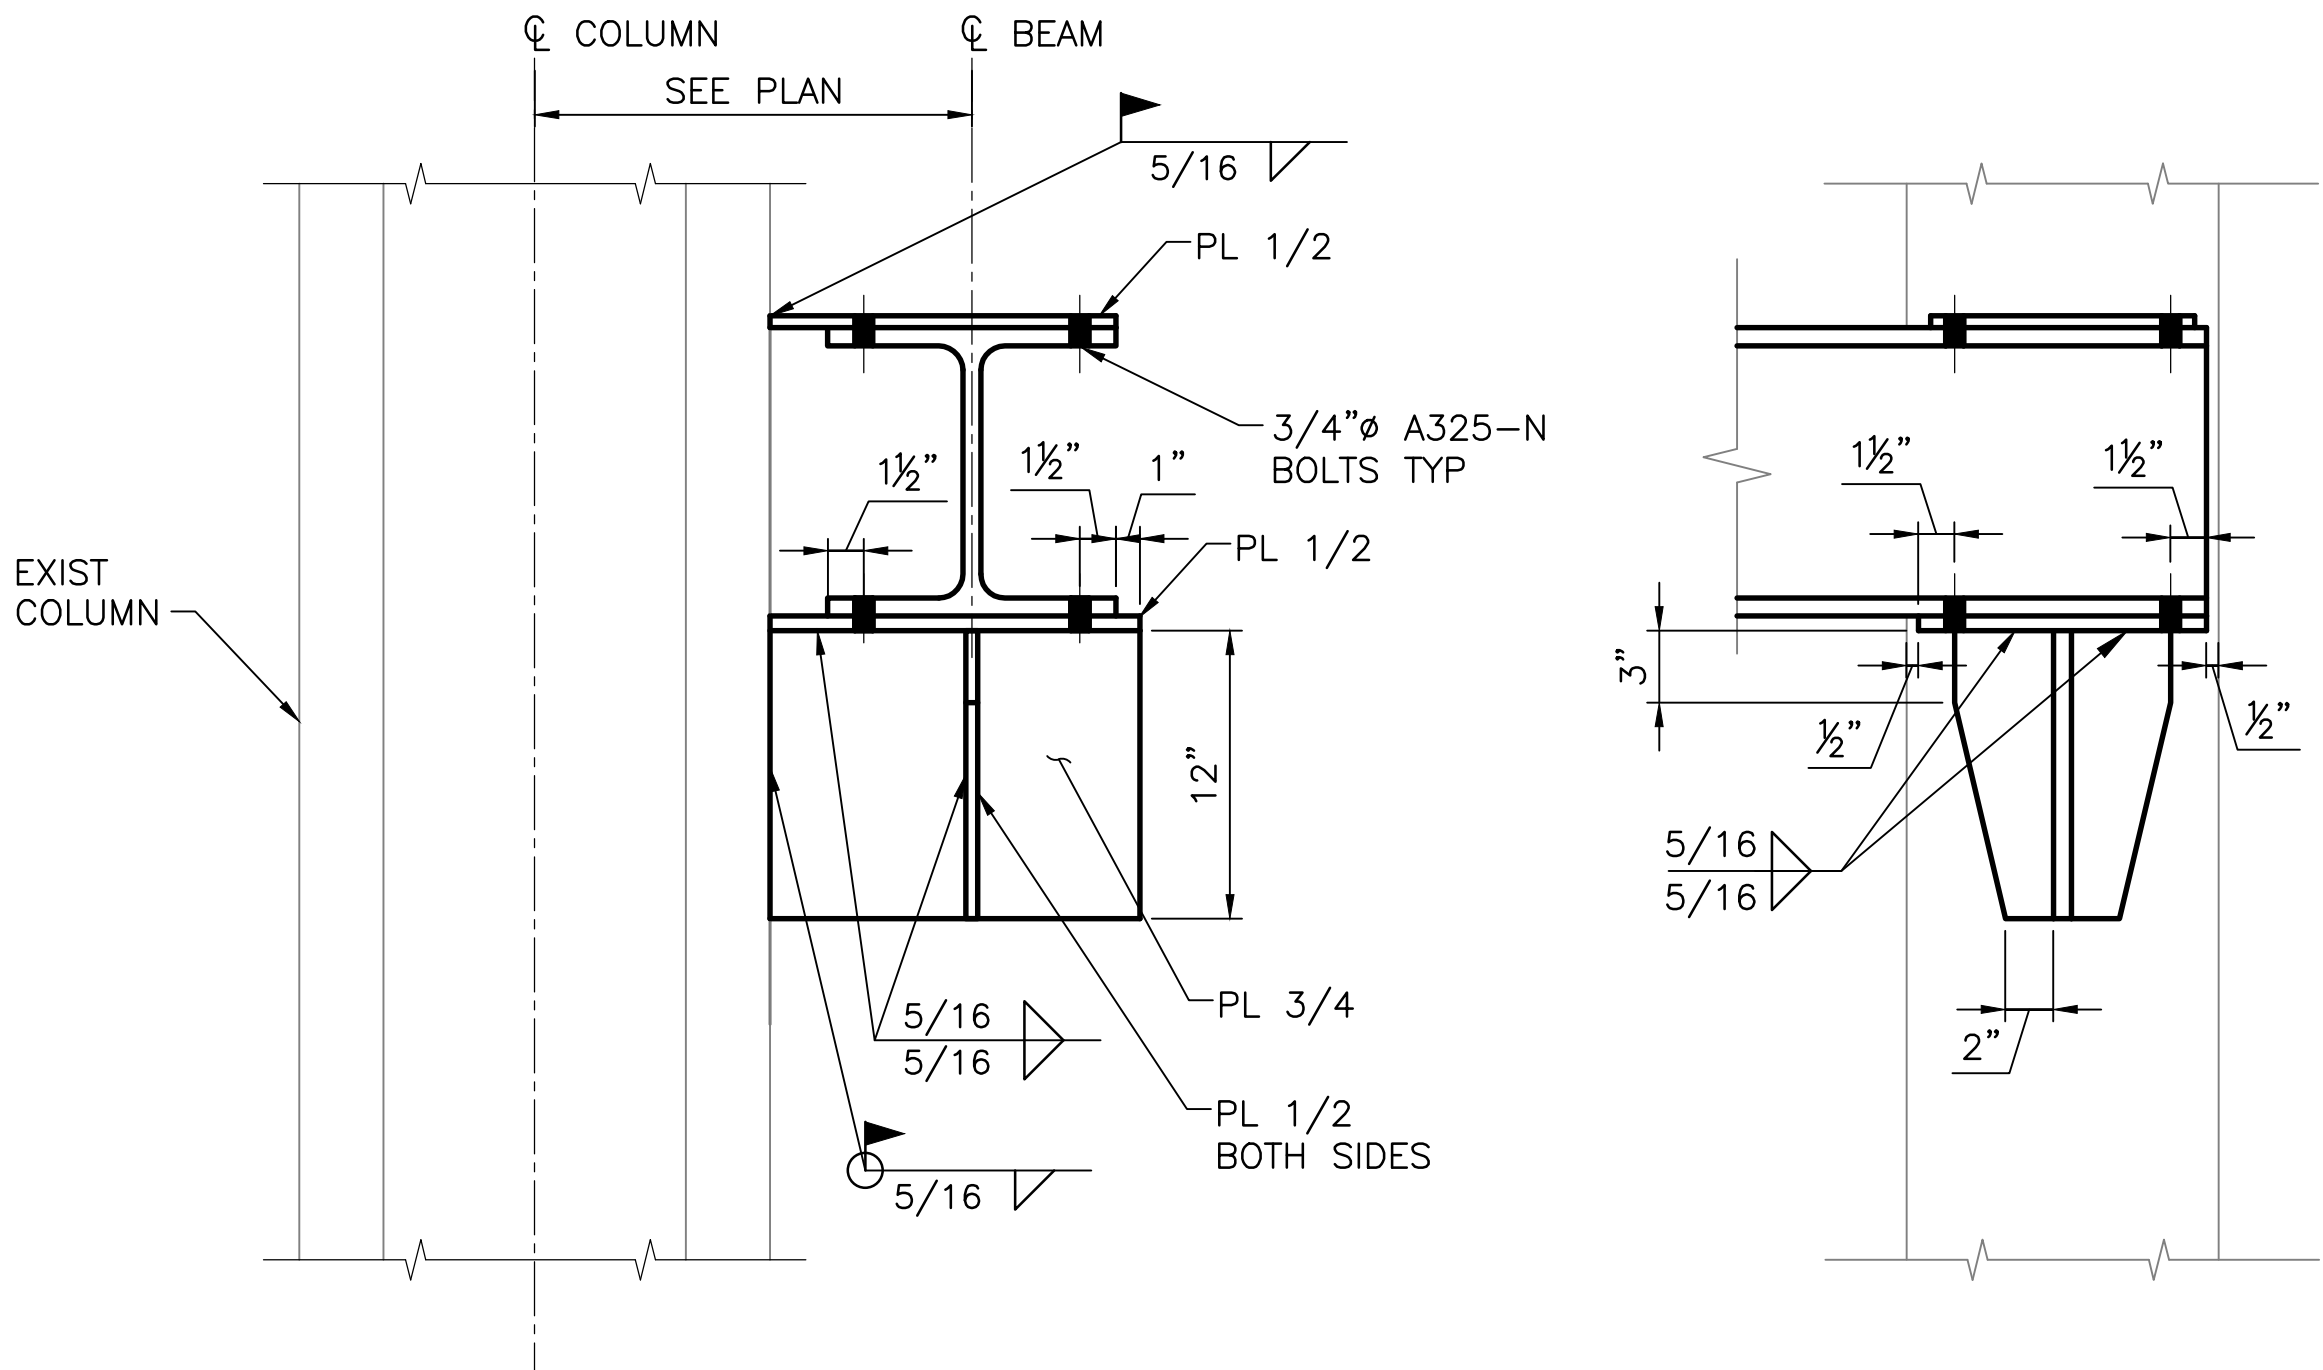

TYPICAL BEAM-COLUMN CONNECTION - DETAIL 7 7 7
SCALE: 1 1/2" = 1'-0" S-401 S-402

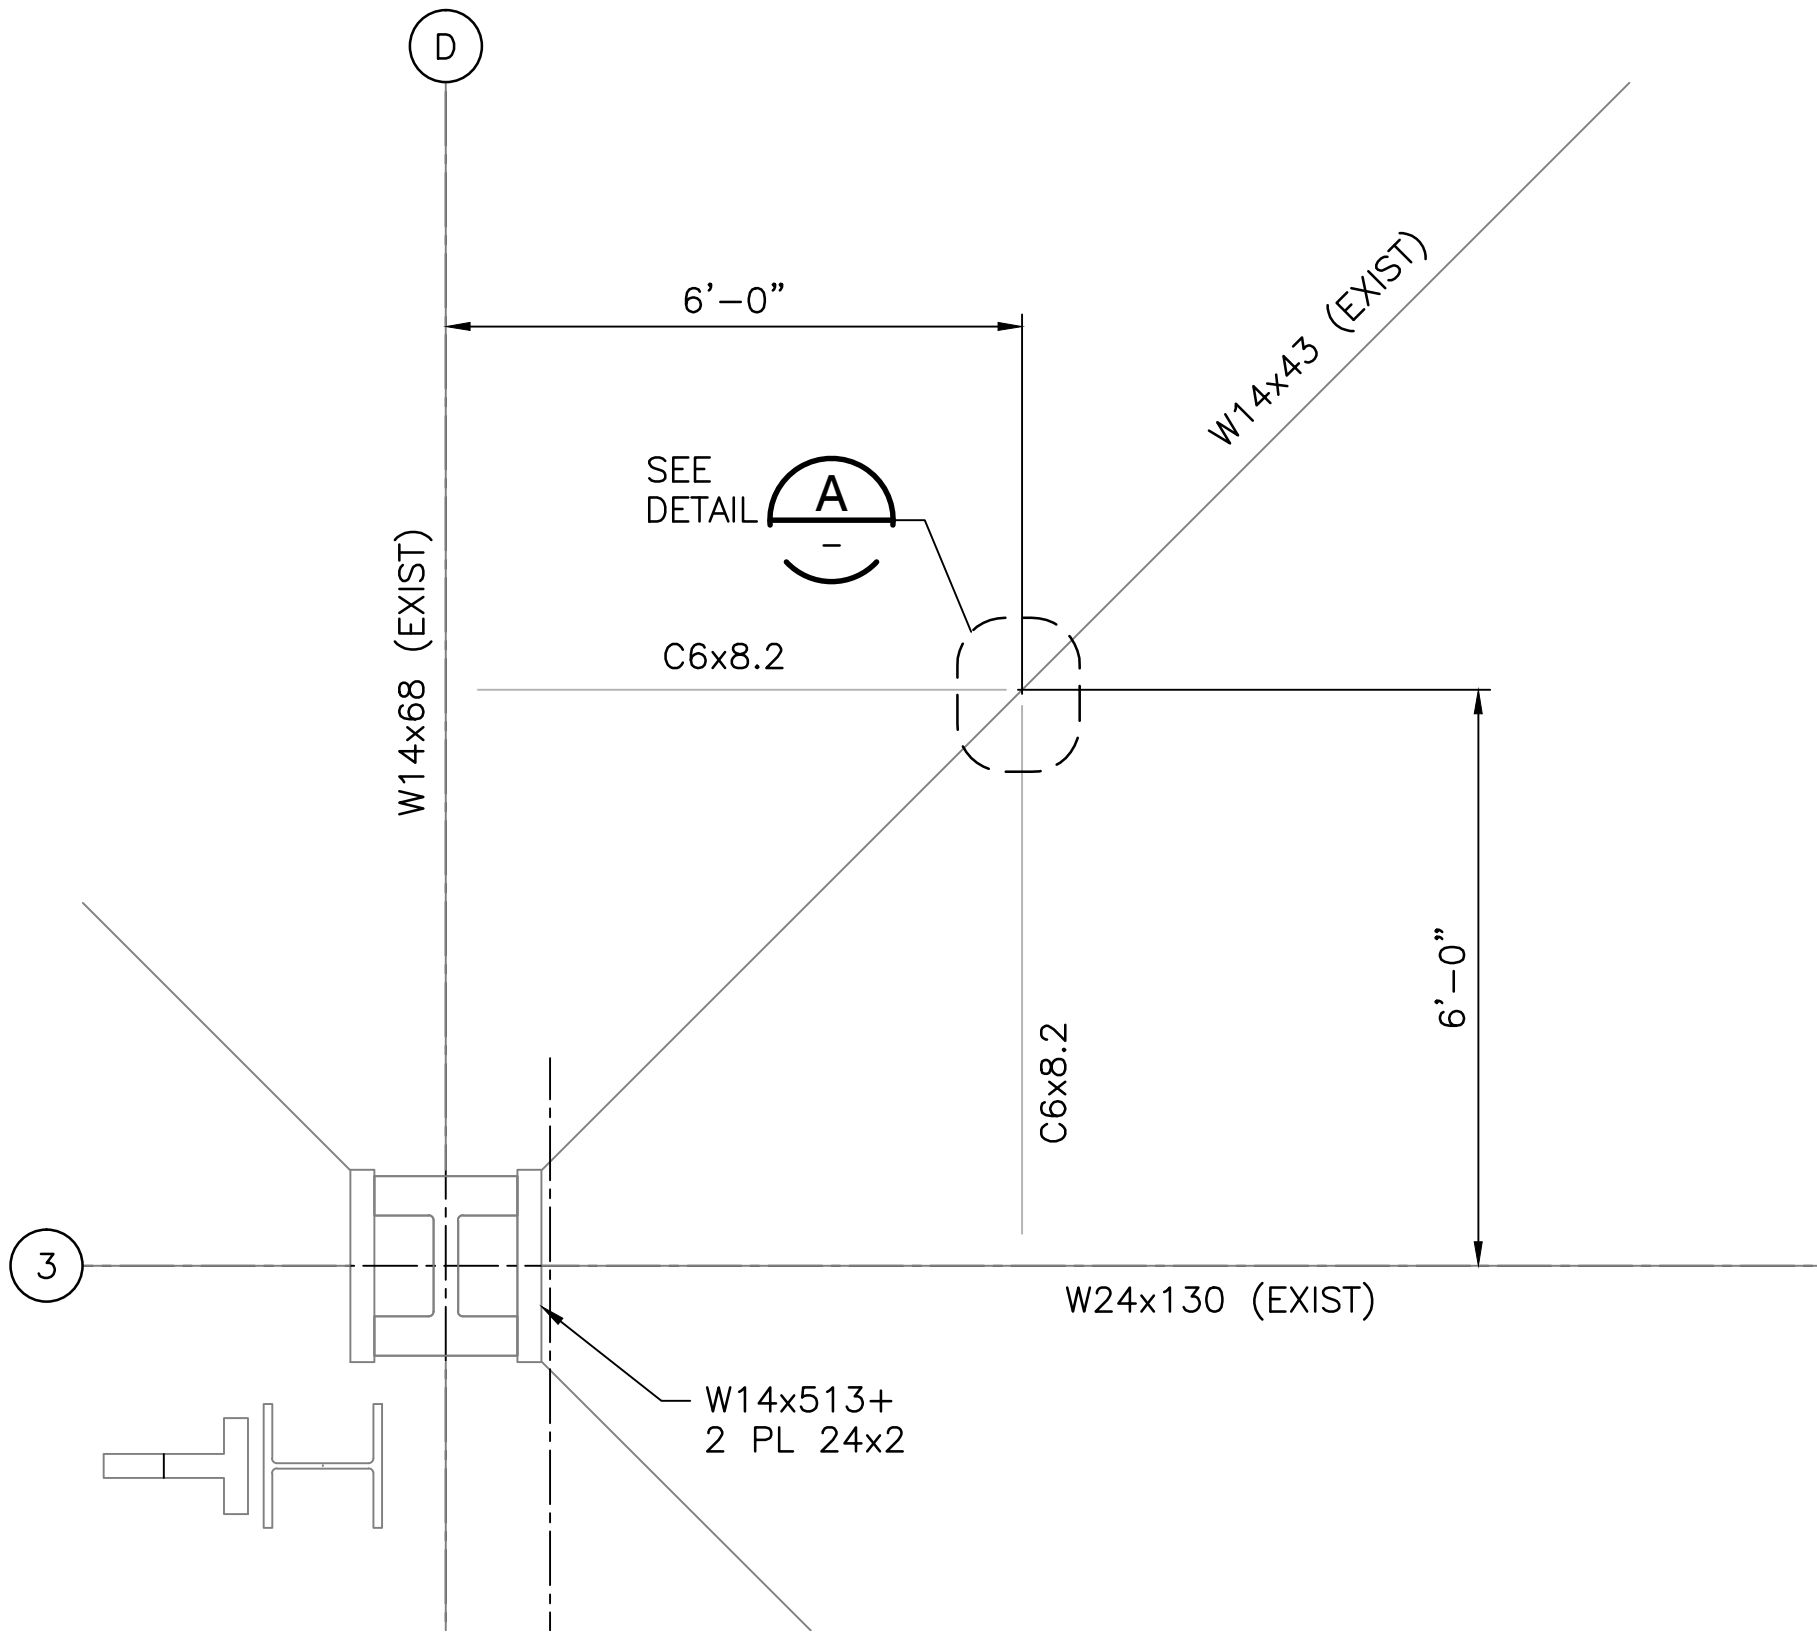

LADDER LANDING - DETAIL (TOS EL 419'-5")
SCALE: 1/2" = 1'-0"

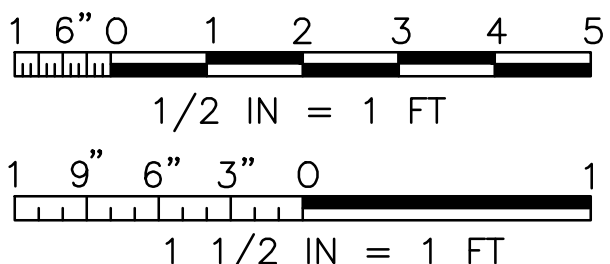

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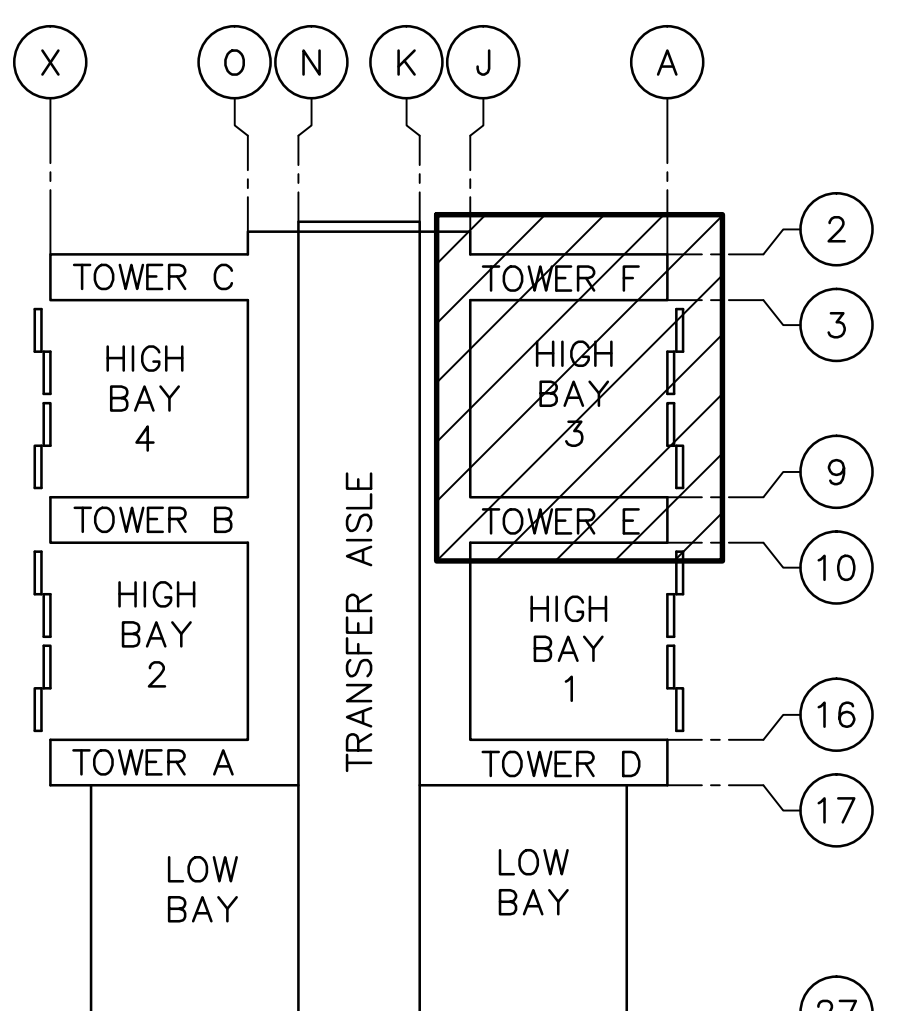
SPECIFIC NOTES:

- A. UN FRAMING MEMBERS SHALL BE STANDARD AISC CONNECTIONS DESIGNED TO THE 13th EDITION AISC STEEL MANUAL REQUIREMENTS. THE FOLLOWING MINIMUM DESIGN LOADS SHALL BE MET:

SECTION	SHEAR (kips)
W14X38	15
W14X30	15
W8X13	6
W6X8.5	6
C10X15	6
C6x8.2	6

LEGEND:


1.5BP 16/16 INVERTED METAL CELLULAR DECK SPAN DIRECTION. PROVIDE 1 1/2" HOLE THRU TOP OF DECK FOR FASTENER INSTALLATION. INSTALL 1/2" DIA-13 (A307/A325 HDG) THRU BOLT WITH HEAVY DUTY, LOCKING HEX NUTS (FLEXLOC NUTS BY SPS TECHNOLOGIES, OAE). ONLY 2 BOLTS PER 24" WIDE CELLULAR PANEL AT EACH BEAM ARE REQUIRED. PROVIDE SNAP BLANKS TO CLOSE HOLES IN TOP OF DECK. EXTEND DECKING TO EDGE OF PERIMETER BEAM FLANGES.



VAB KEY PLAN
SCALE: NTS

SYM	ZONE	DESCRIPTION	DATE	APPROVAL
REVISIONS				
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NATIONAL AERONAUTICS AND SPACE ADMINISTRATION JOHN F. KENNEDY SPACE CENTER, NASA KENNEDY SPACE CENTER, FLORIDA				
LAUNCH COMPLEX 39 VEHICLE ASSEMBLY BUILDING MODIFY VEHICLE ASSEMBLY BUILDING HIGH BAY 3 FOR SLS - HOISTS STRUCTURAL DETAILS - 2				
SIGNATURES	DATE			
DRAWN: JOSEPH HAUER	08-20-2013			
CHECKED: ROBERT PRUSS	08-20-2013			
SUBMITTED ARCHIVING OF RECORD				
JAMES BALMER				
ST OF LICENSURE: FL				
LICENSE NO:				
APPROVED:				
JOHN KEROSMAR				
MIKE HARTNETT				
FILE NO.	302-6058-043	SIZE	11	REV
PROJ. NO.	PCN 99000.5	SHEET	23	OF


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(PIN NOT SHOWN FOR CLARITY)

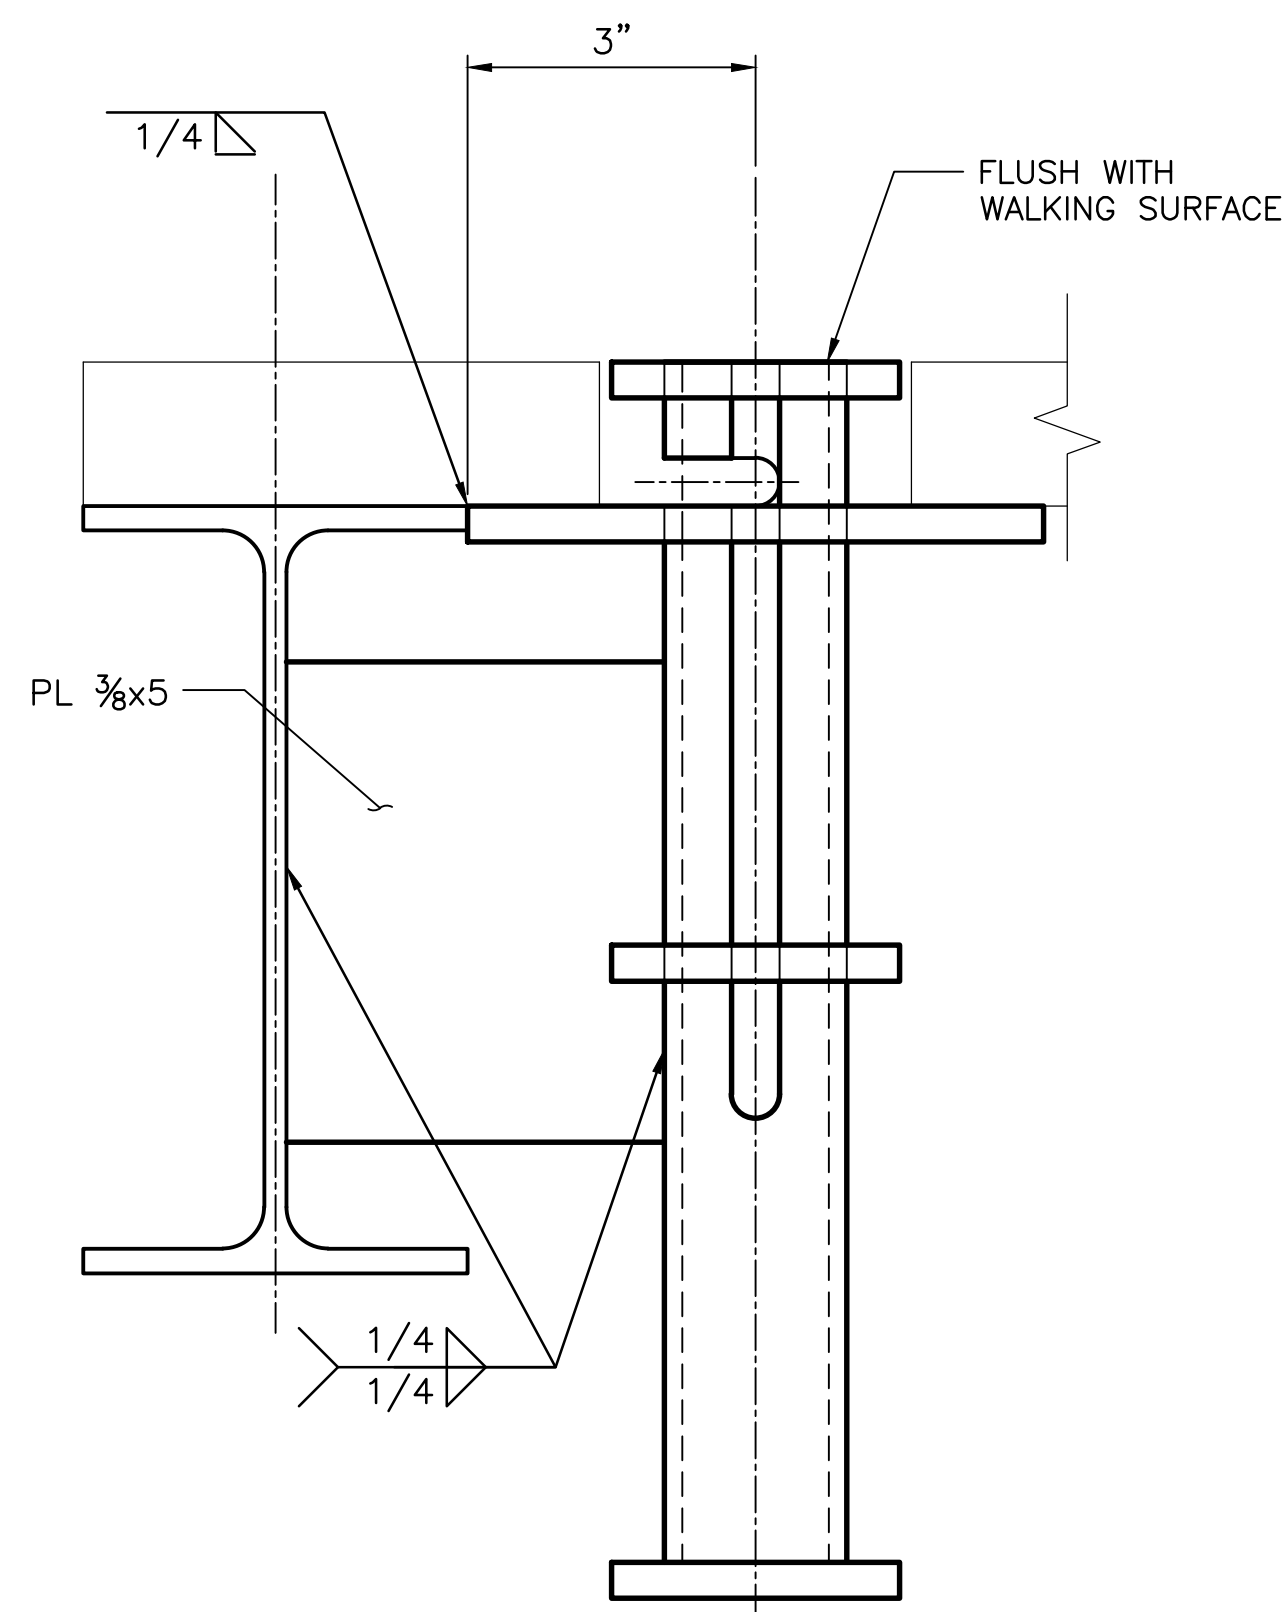
SECTION

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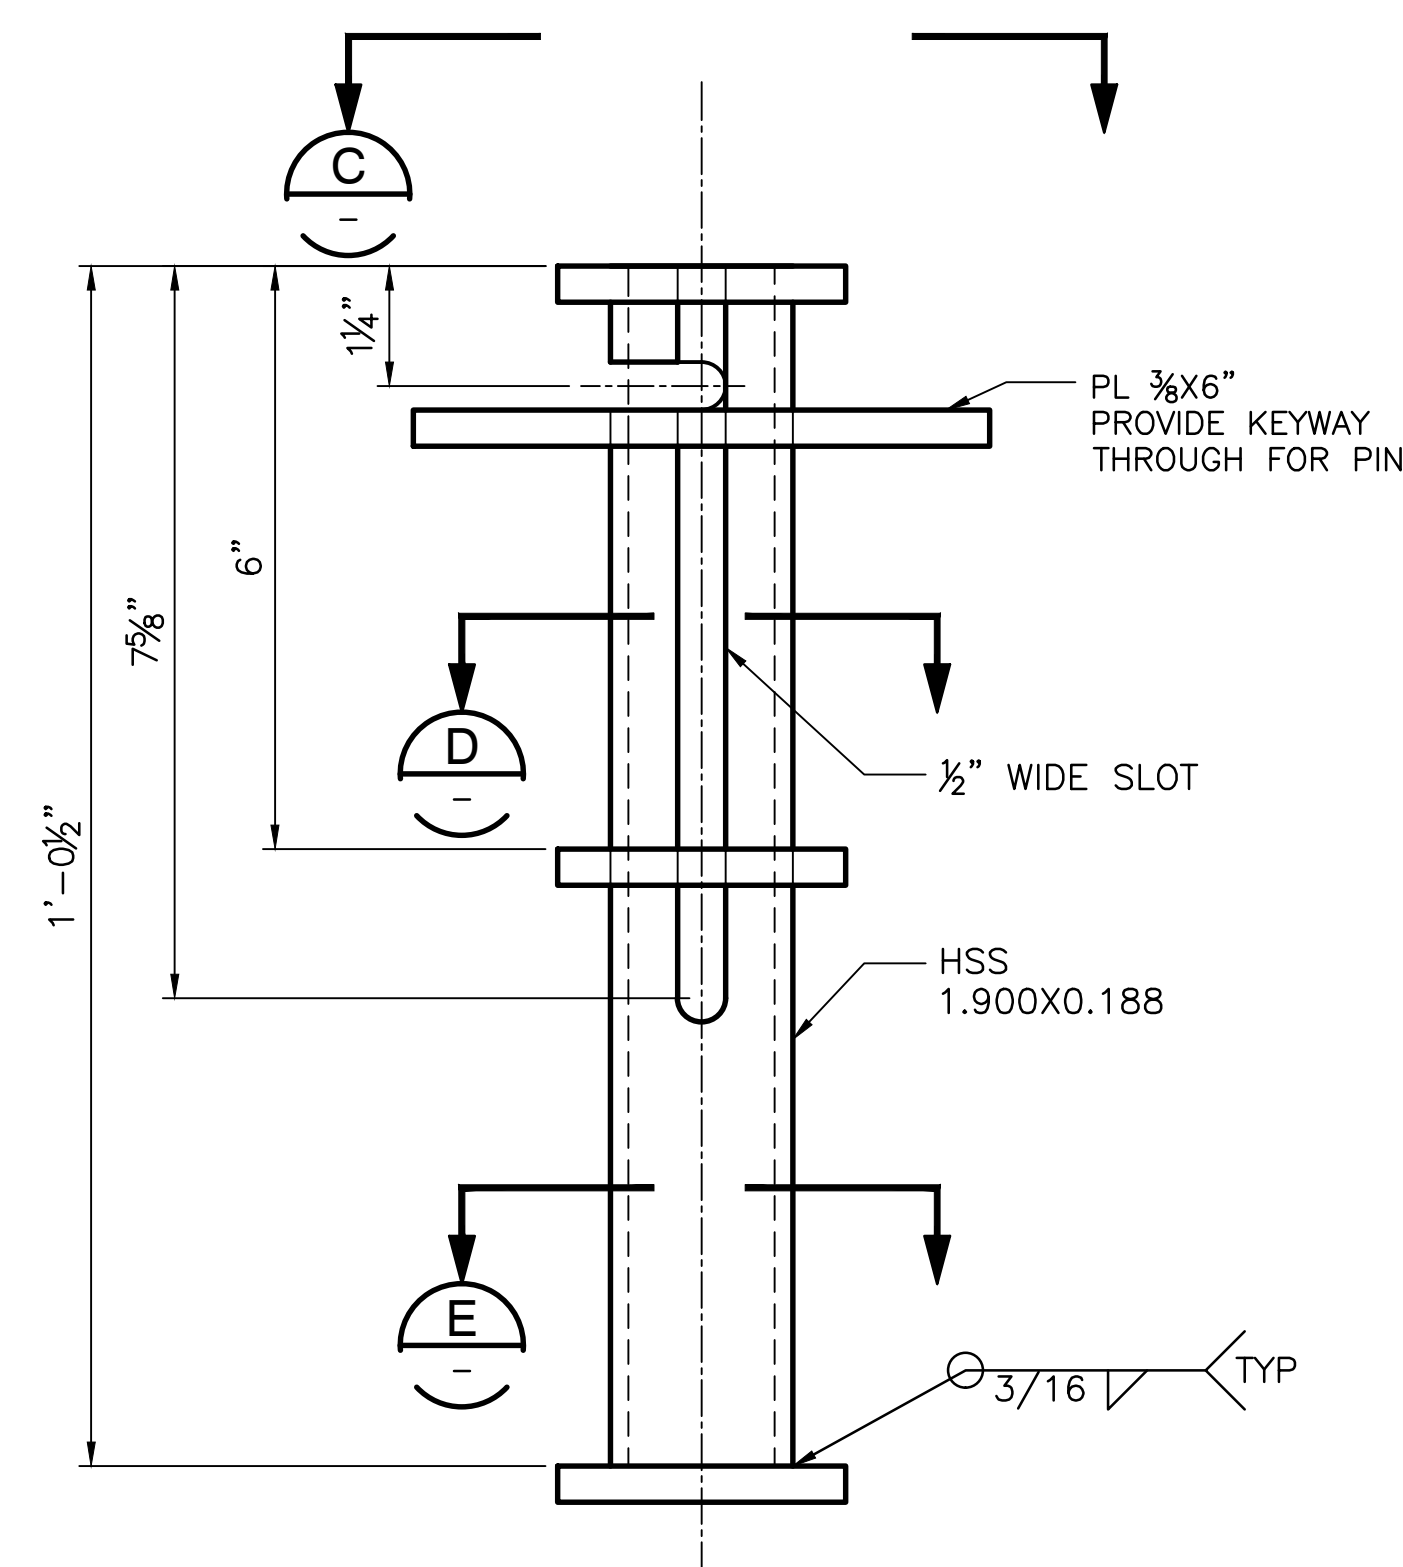
DETAIL

SCALE: 6"=1'-0"

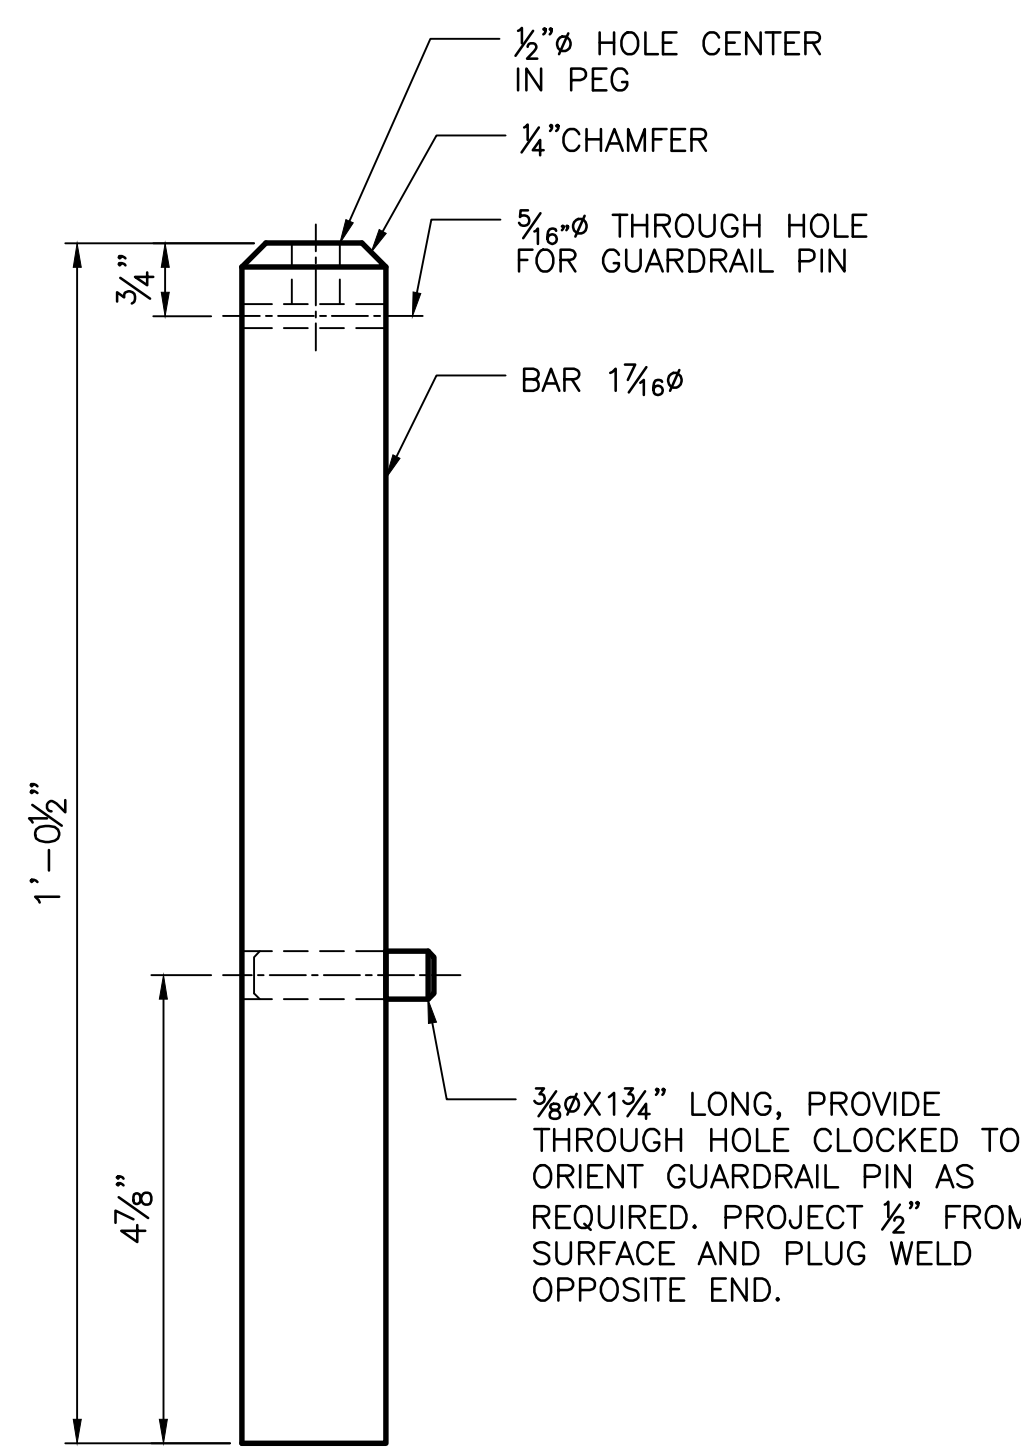


REMOVABLE GUARDRAIL BASE DETAIL

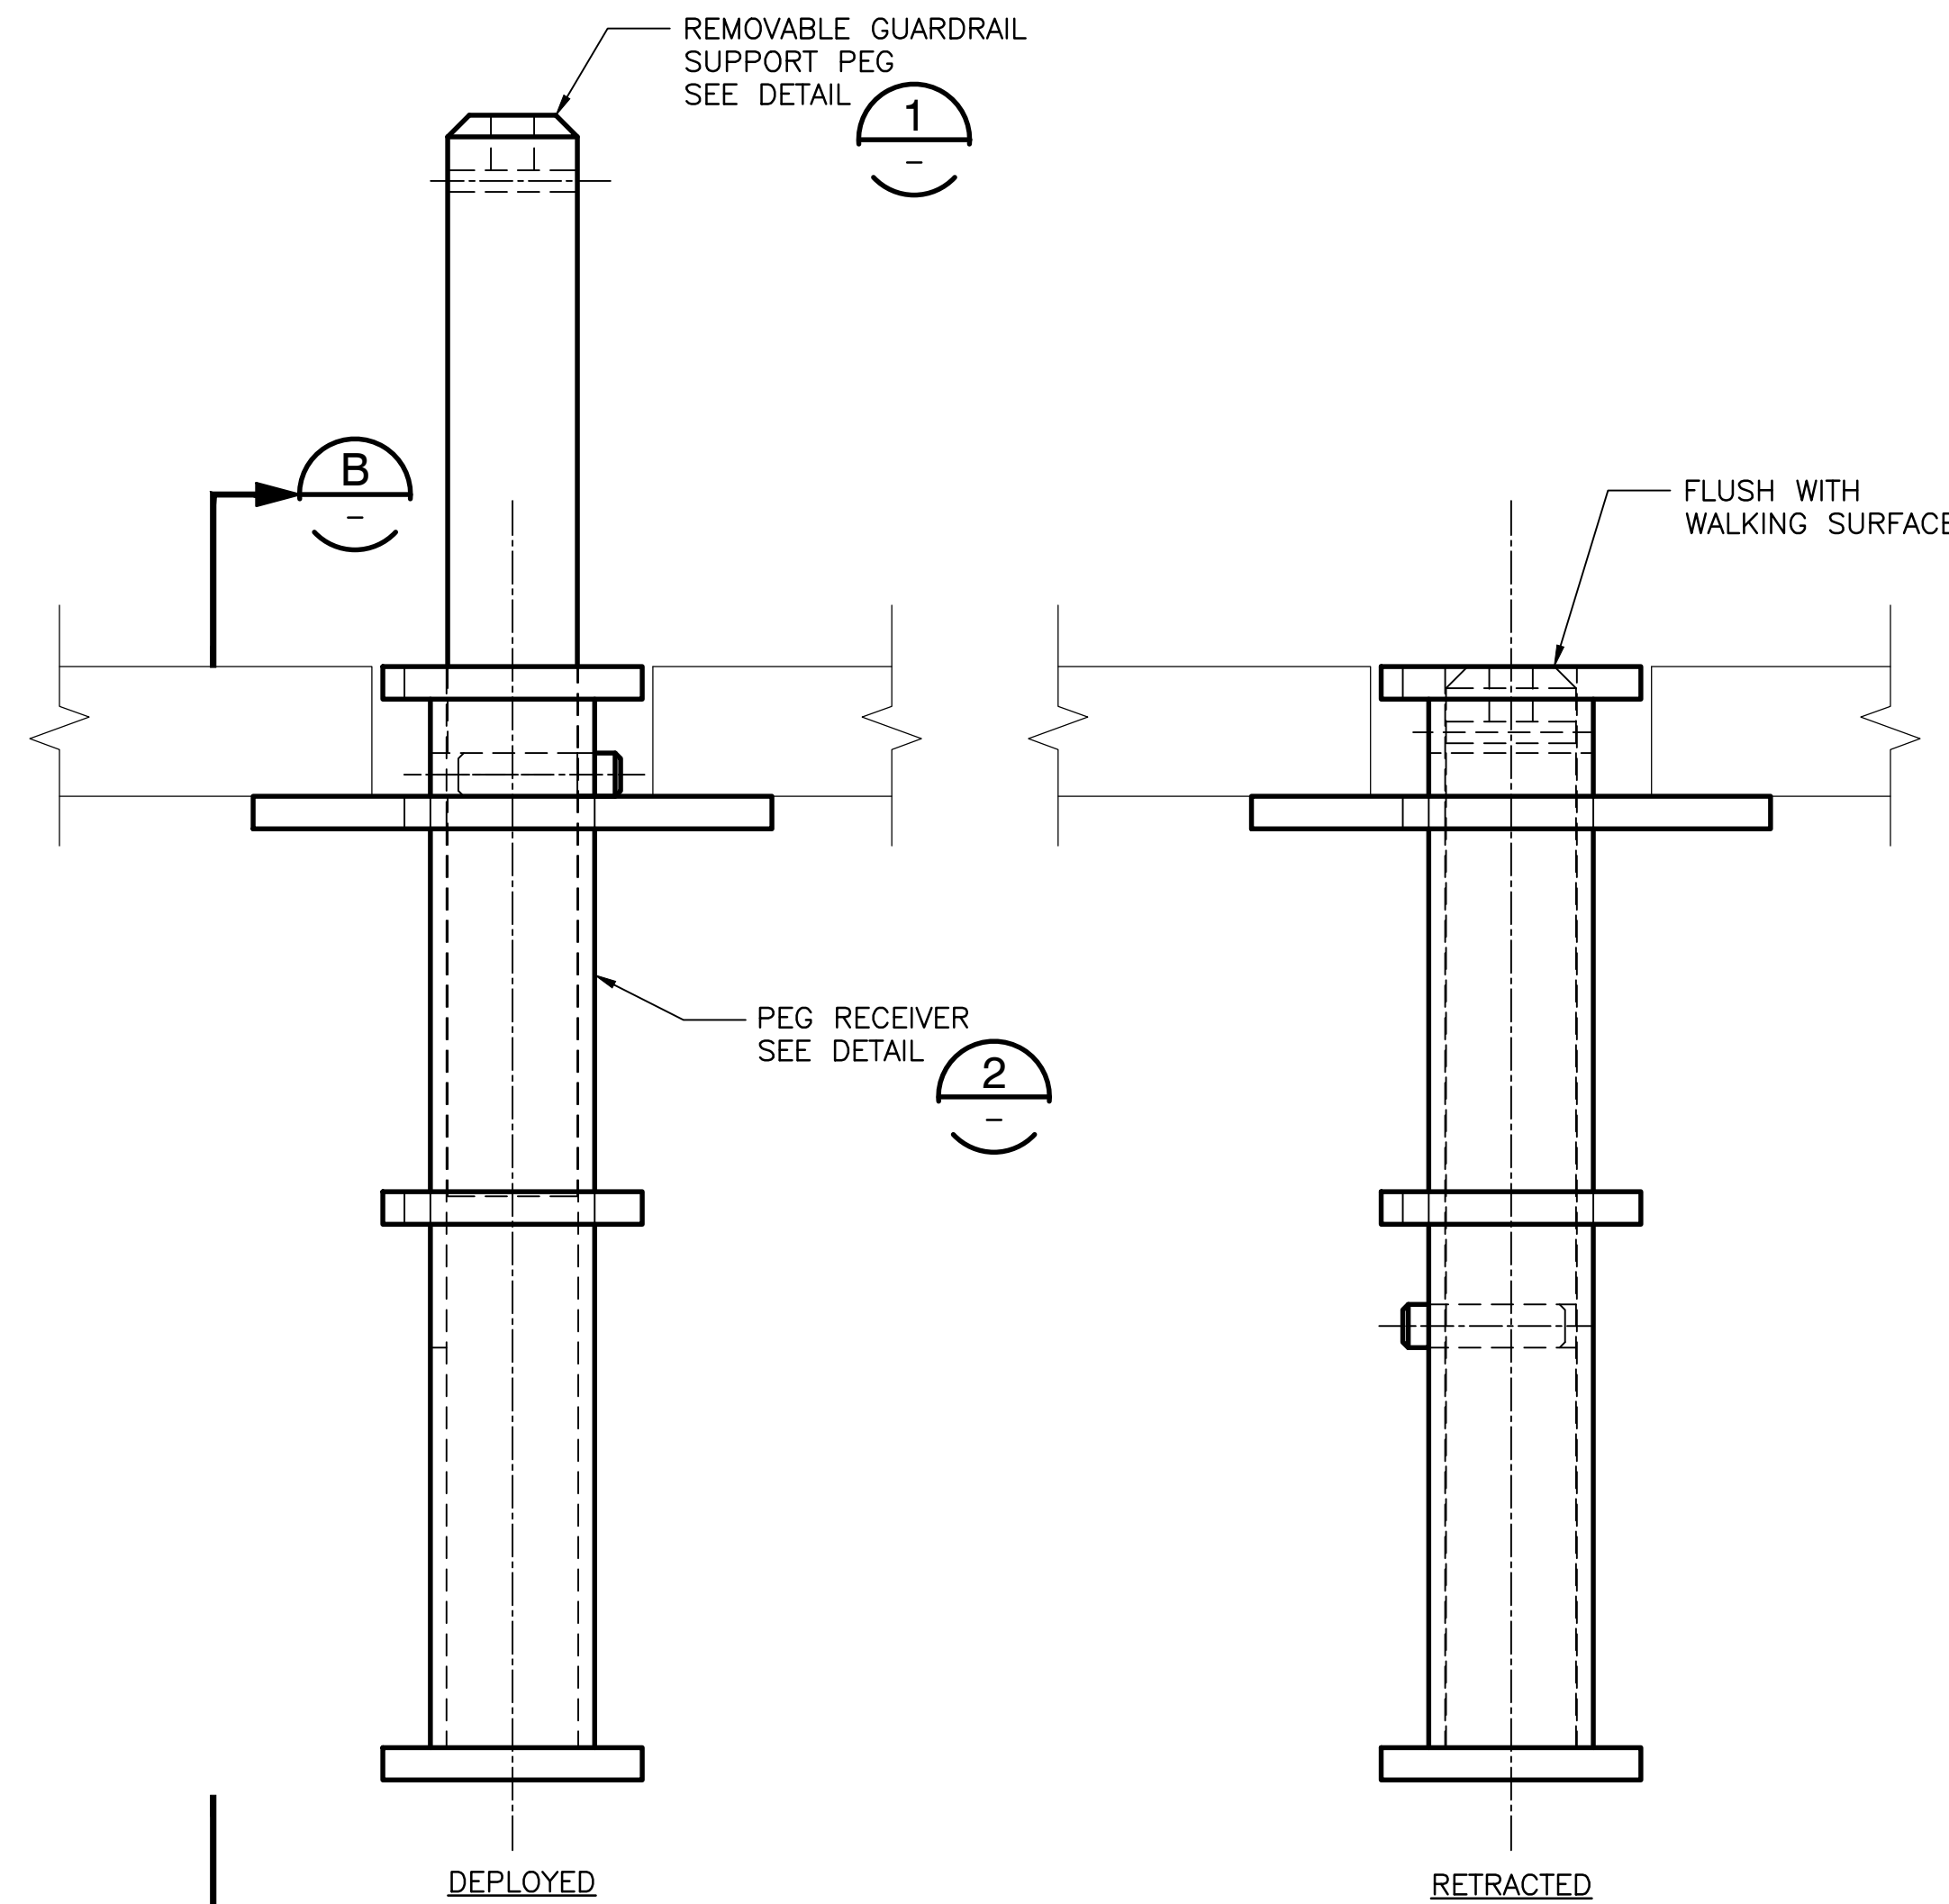SCALE: 6"=1'-0"




DETAIL

SCALE: 6"=1'-0"

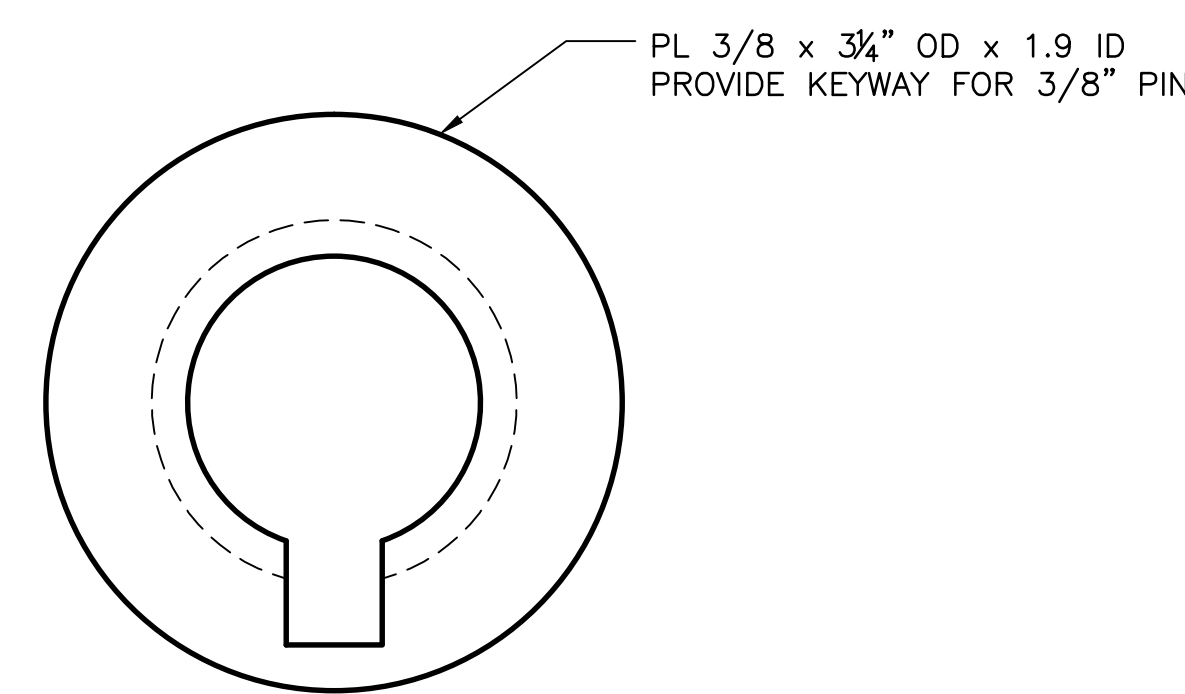


VIEW

SCALE: 1'-0"=1'-0"

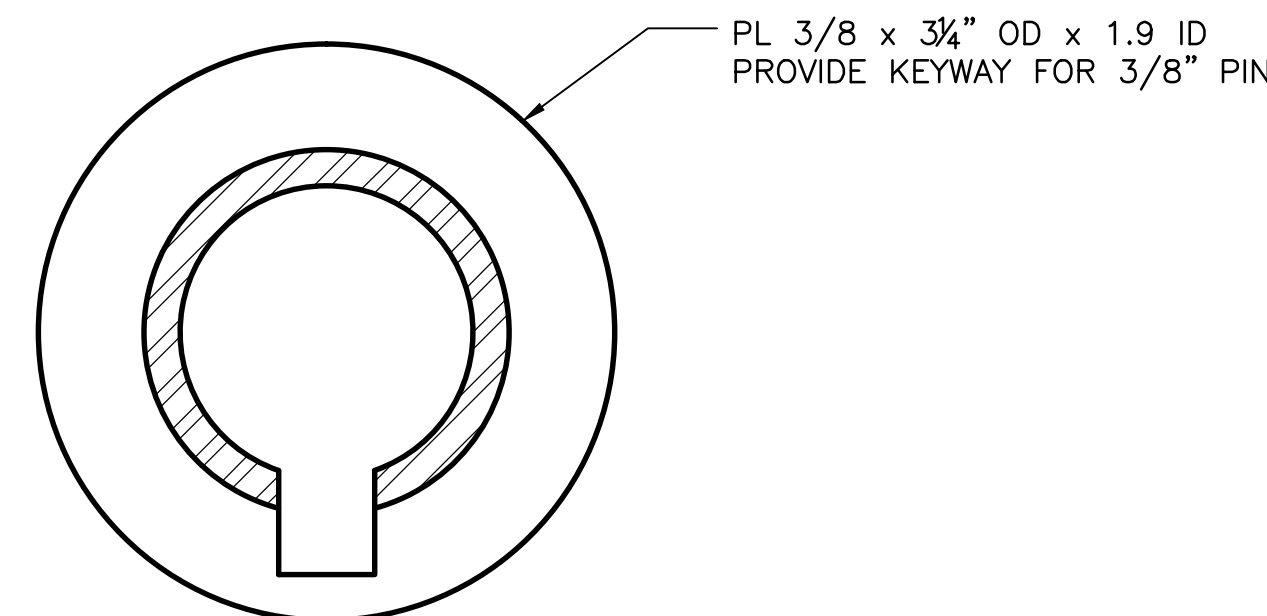


SECTION

SCALE: 1'-0"=1'-0"

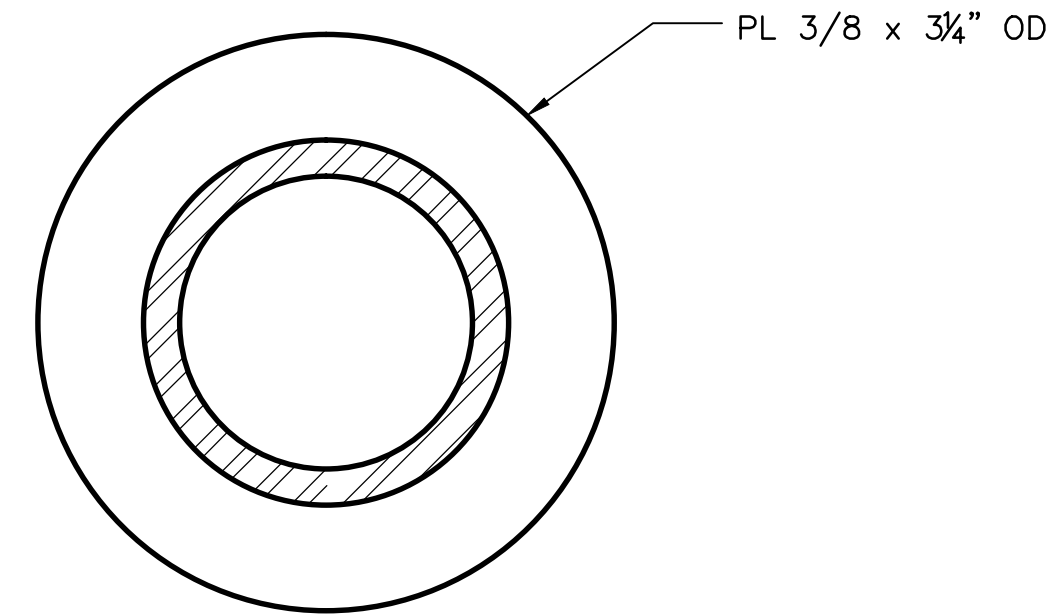


SECTION

SCALE: 1'-0"=1'-0"

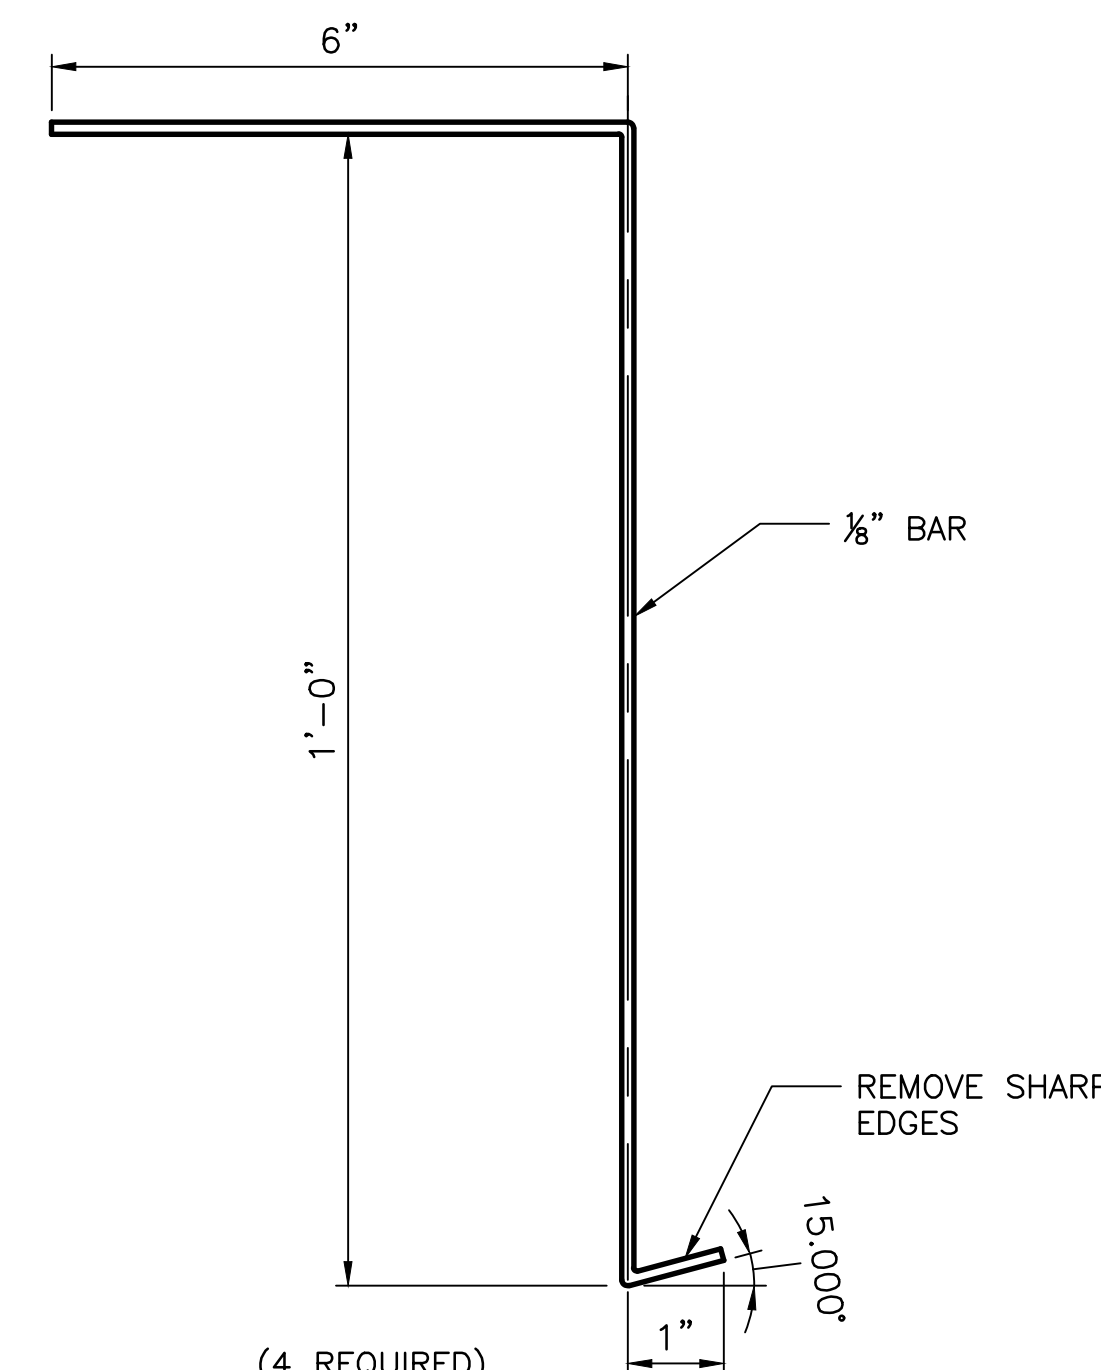


PEG EXTRACTION DEVICE DETAIL


SCALE: 6"=1'-0"

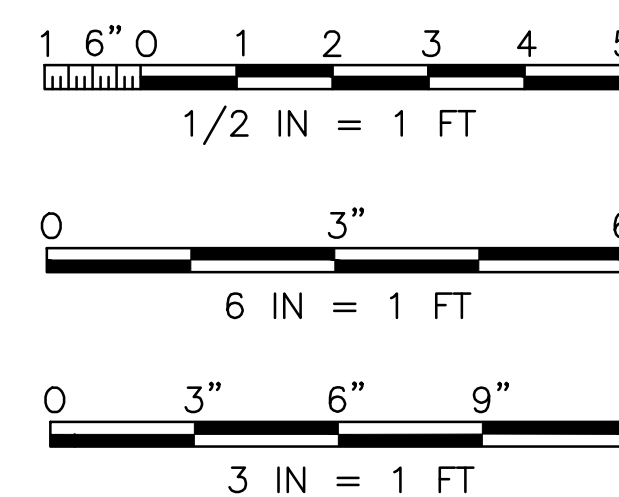

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SYM	ZONE	DESCRIPTION		DATE	REVISIONS
SIGNATURES		DATE	 Reynolds, Smith and Hills, Inc. 115 Alma Blvd, Suite 101 Merritt Island, Florida 32953-4101 (321) 453-0122 (321) 453-0223 FAX www.rsandh.com		
DRAWN: JOSEPH HAUER	08-20-2013	NATIONAL AERONAUTICS AND SPACE ADMINISTRATION JOHN F. KENNEDY SPACE CENTER, NASA KENNEDY SPACE CENTER, FLORIDA			
CHECKED: MIKE KENDRICK	08-20-2013	LAUNCH COMPLEX 39 VEHICLE ASSEMBLY BUILDING			
SUBMITTED: ARCHING OF RECORD		MODIFY VEHICLE ASSEMBLY BUILDING HIGH BAY 3 FOR SLS - HOISTS REMOVABLE GUARDRAIL BASE			
JAMES BAUMER		DETAIL			
ST OF LICENSURE: FL		FILE NO.	SIZE	DWG. NO.	REV
LICENCE NO:		302-6058-043	E	79K39667	
APPROVED:					
JOHN KERCSMAR					
MIKE HARTNETT		PROJ. NO.	PCN	990005	SHEET 24 OF

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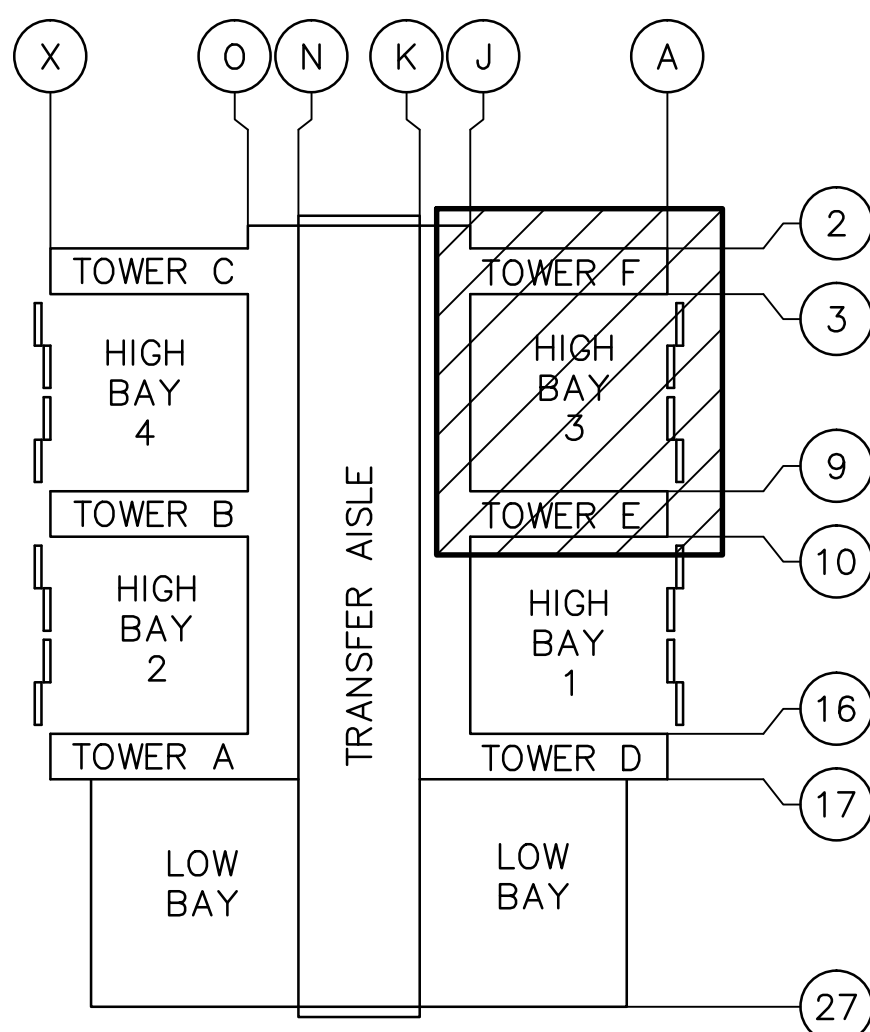


NOTE: TOWER F SHOWN. TOWER E SIMILAR EXCEPT OPPOSITE HAND.

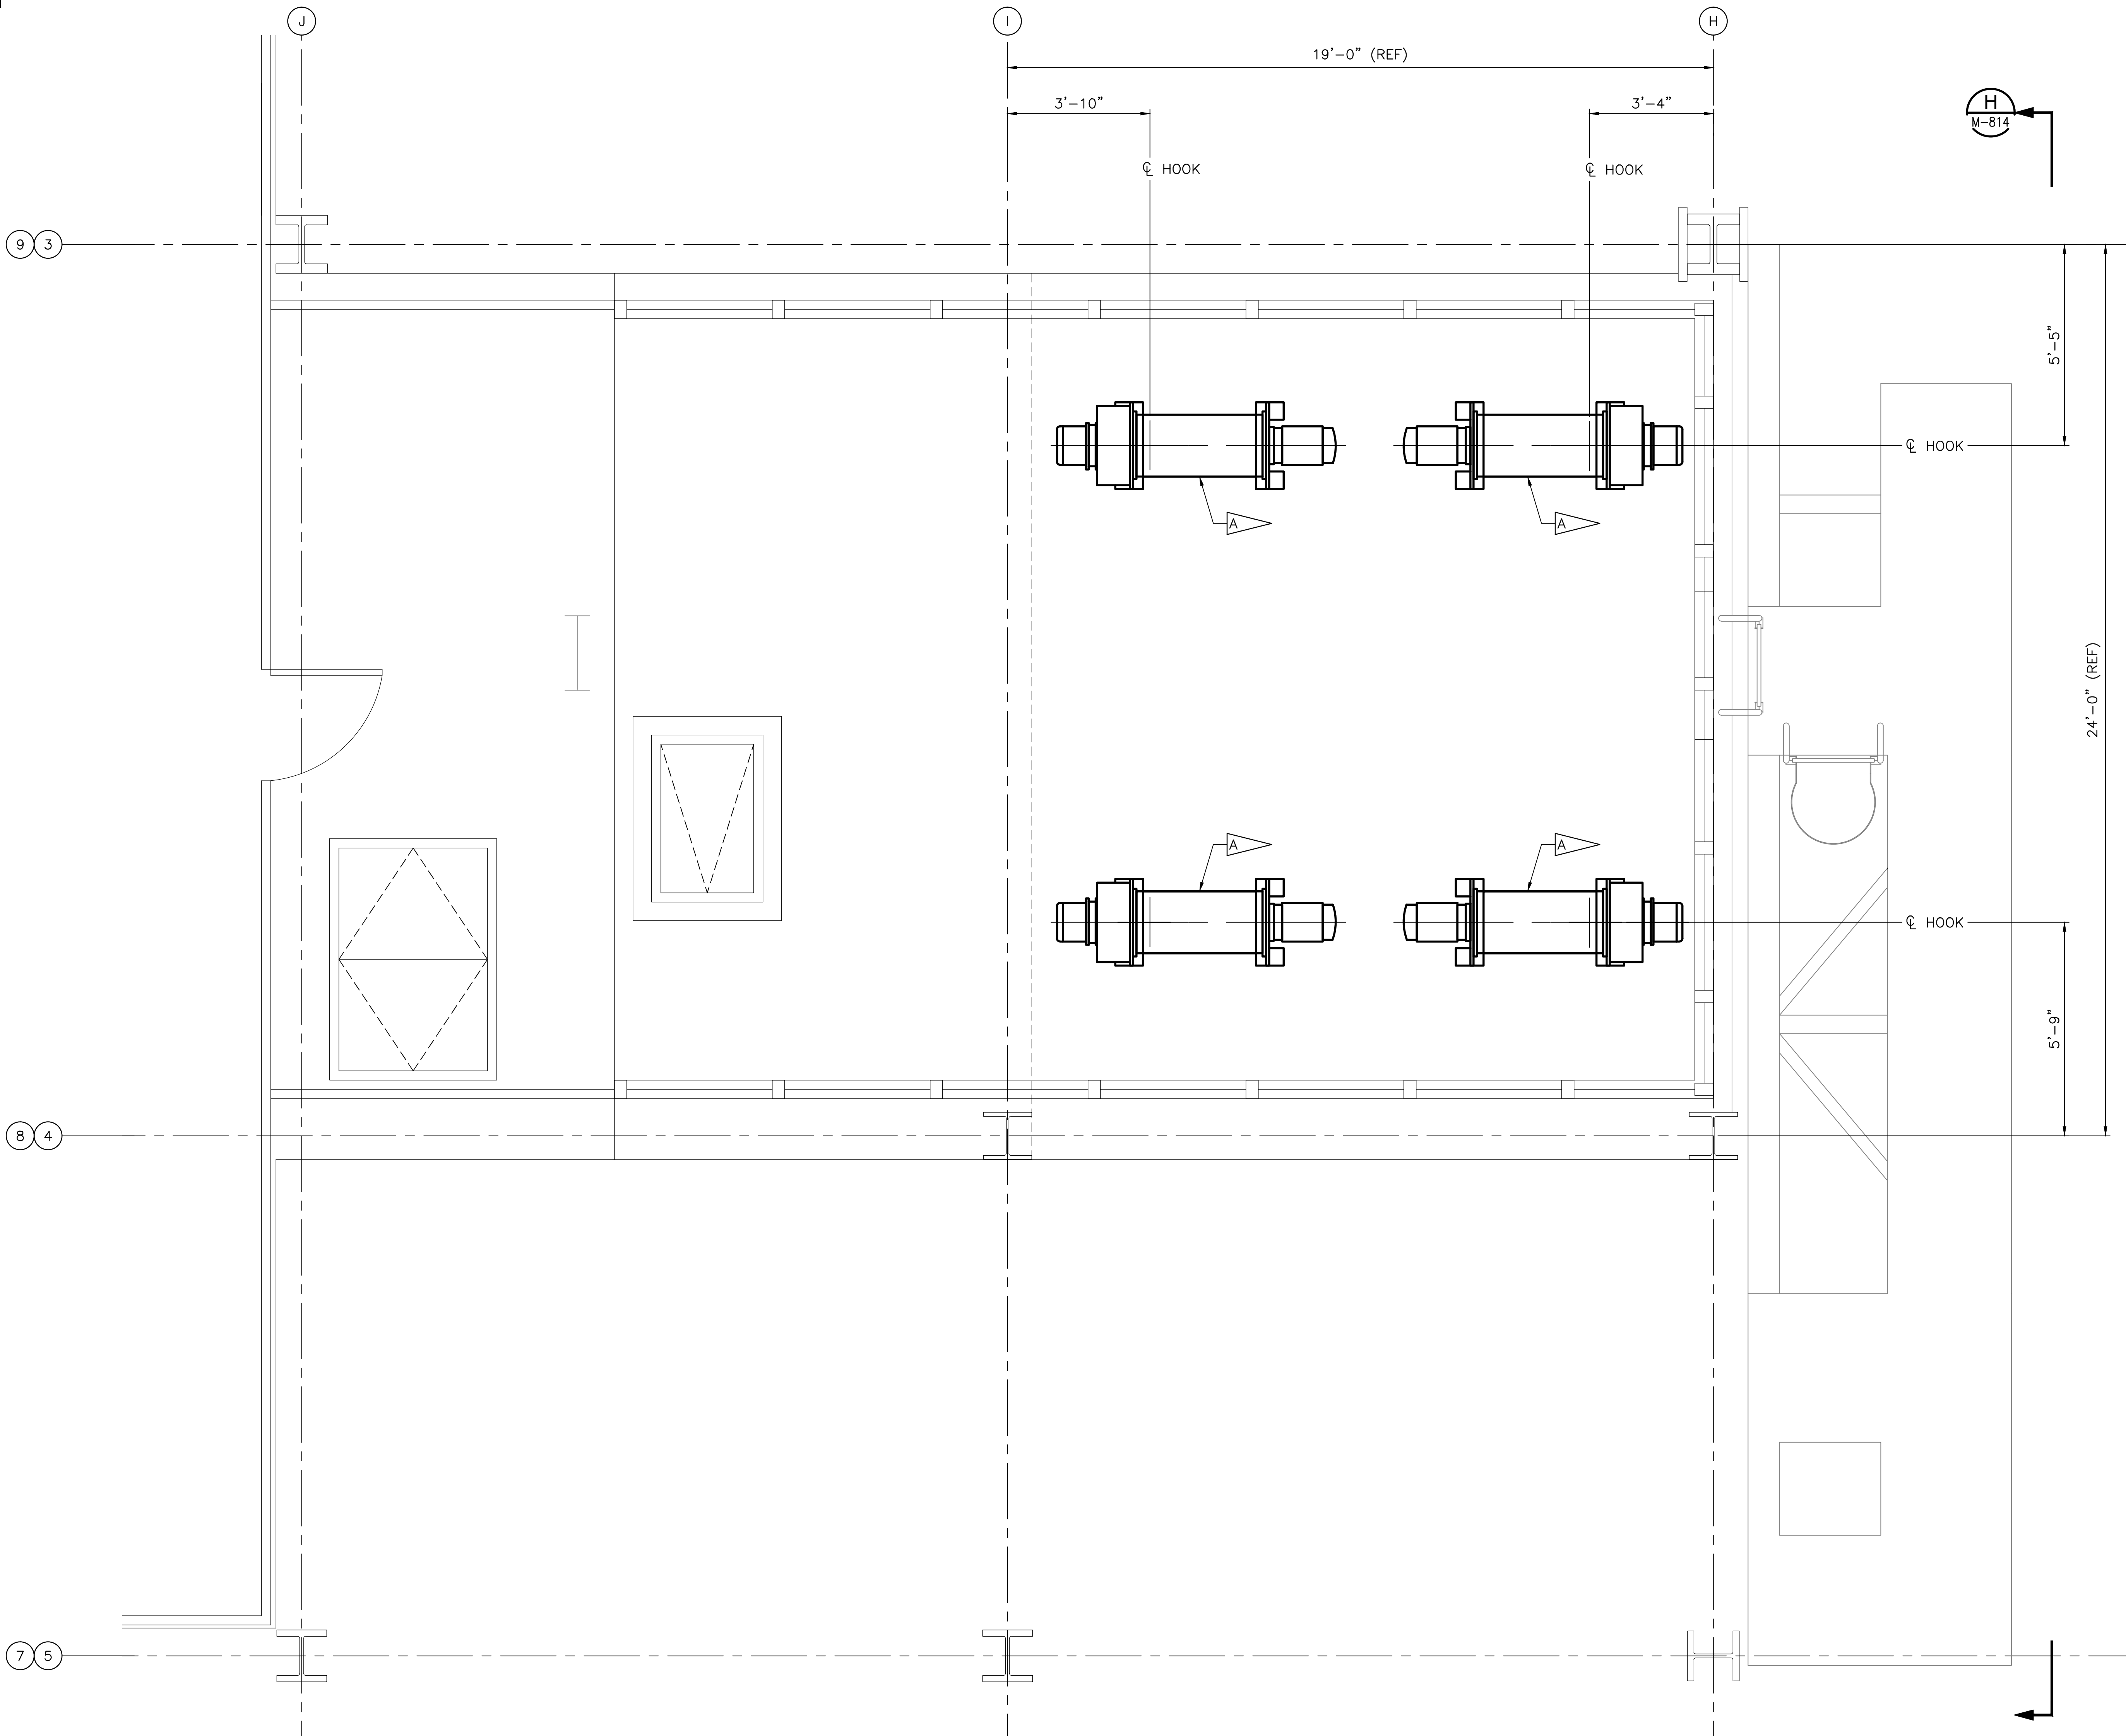
FLOOR PLAN AT LEVEL 36 (EL 445'-1")
SCALE: 1/2"=1'-0"

SPECIFIC NOTES:

- A. ELEVATOR PLATFORM HOISTS PER 79K39668 (MODIFY VEHICLE ASSEMBLY BUILDING HIGH BAY 3 FOR SLS - HOISTS), SECTION 41 22 23.19.
- B. THE CONTRACTOR SHALL PROVIDE SECONDARY FRAMING TO SUPPORT REACTION LOADS FROM HOIST EQUIPMENT AS WELL AS SUPPORTING OPENINGS IN THE FLOOR REQUIRED TO SUPPORT HIS LAYOUT. CONTRACTOR FRAMING PLANS SHALL BE SIGNED AND SEALED BY A FLORIDA LICENSED STRUCTURAL ENGINEER. THE CONTRACTOR SHALL REFER TO DRAWING S-3-074 FOR AS-BUILT INFORMATION FOR EXISTING FRAMING ON THE LEVEL.
- C. ELEVATOR PLATFORM MAXIMUM TRAVEL HEIGHT IS LEVEL 34.
- D. HOIST ARRANGEMENT AND INSTALLATION SHALL ACCOMMODATE TRUE VERTICAL PLATFORM HOIST MOVEMENT. THE HOOK CENTERLINE IS HIGH HOOK POSITION CENTERLINE.
- E. ELEVATOR PLATFORM HOISTS TO BE POSITIONED SUCH TO ALLOW ADEQUATE ROOM AROUND EACH HOIST FOR MAINTENANCE.
- F. CONDUITS USED IN THE INSTALLATION OF THE HOIST MOTORS AND THEIR REQUIRED CONTROL ACCESSORIES SHALL BE RUN IN ACCORDANCE WITH SPECIFICATION 26 05 00.00 40. CONDUITS SHALL NOT BE ROUTED ALONG WALKING SURFACES OR IN A MANNER THAT RESTRICTS ACCESS OR EGRESS FROM THE SPACE IN WHICH IT IS INSTALLED.



VAB KEY PLAN
SCALE: NTS

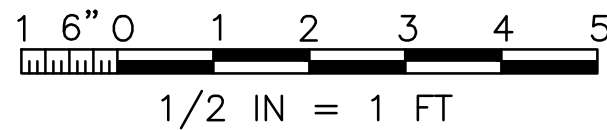


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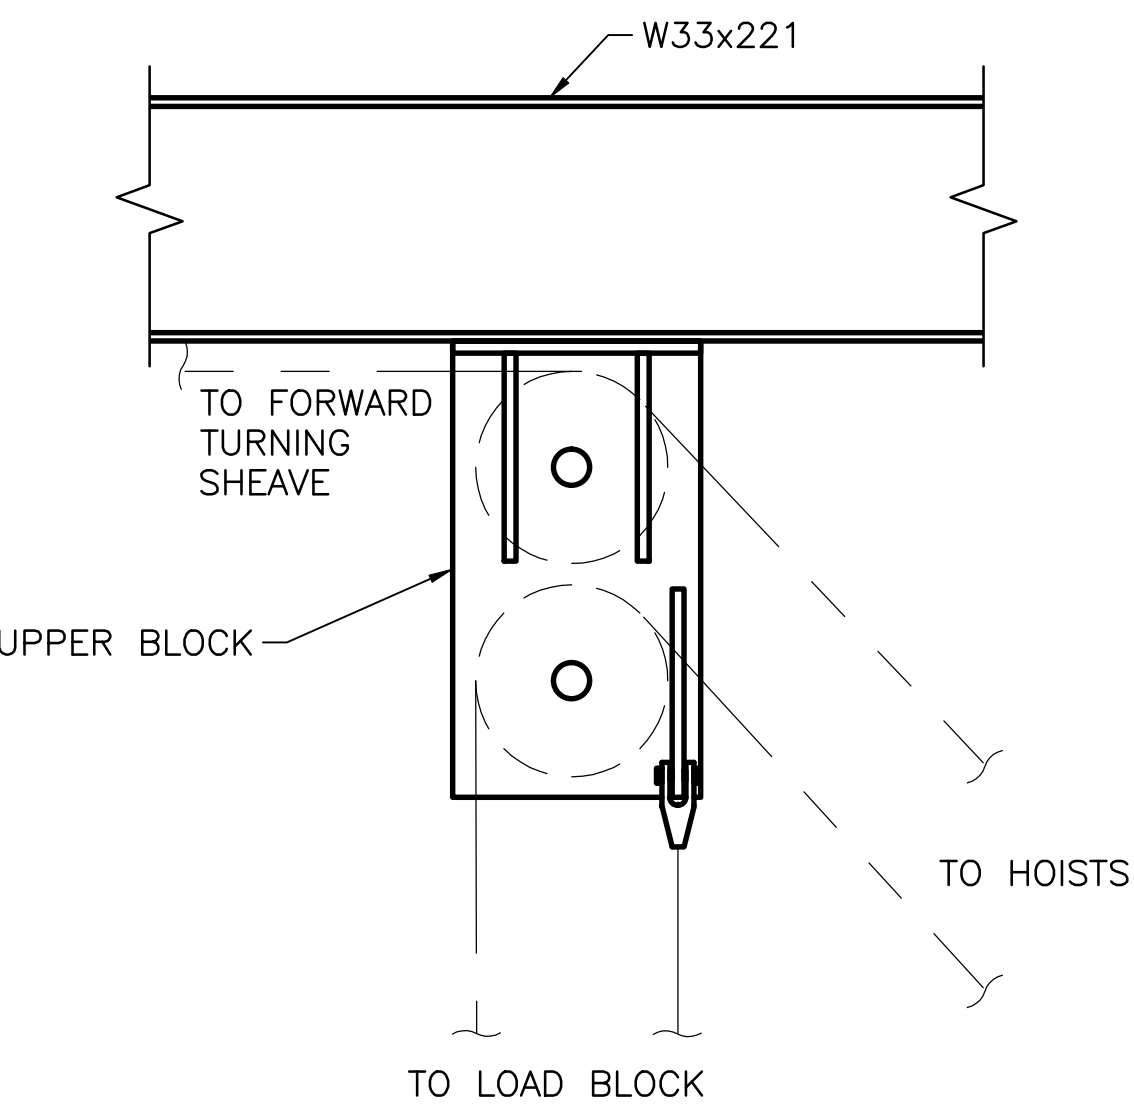
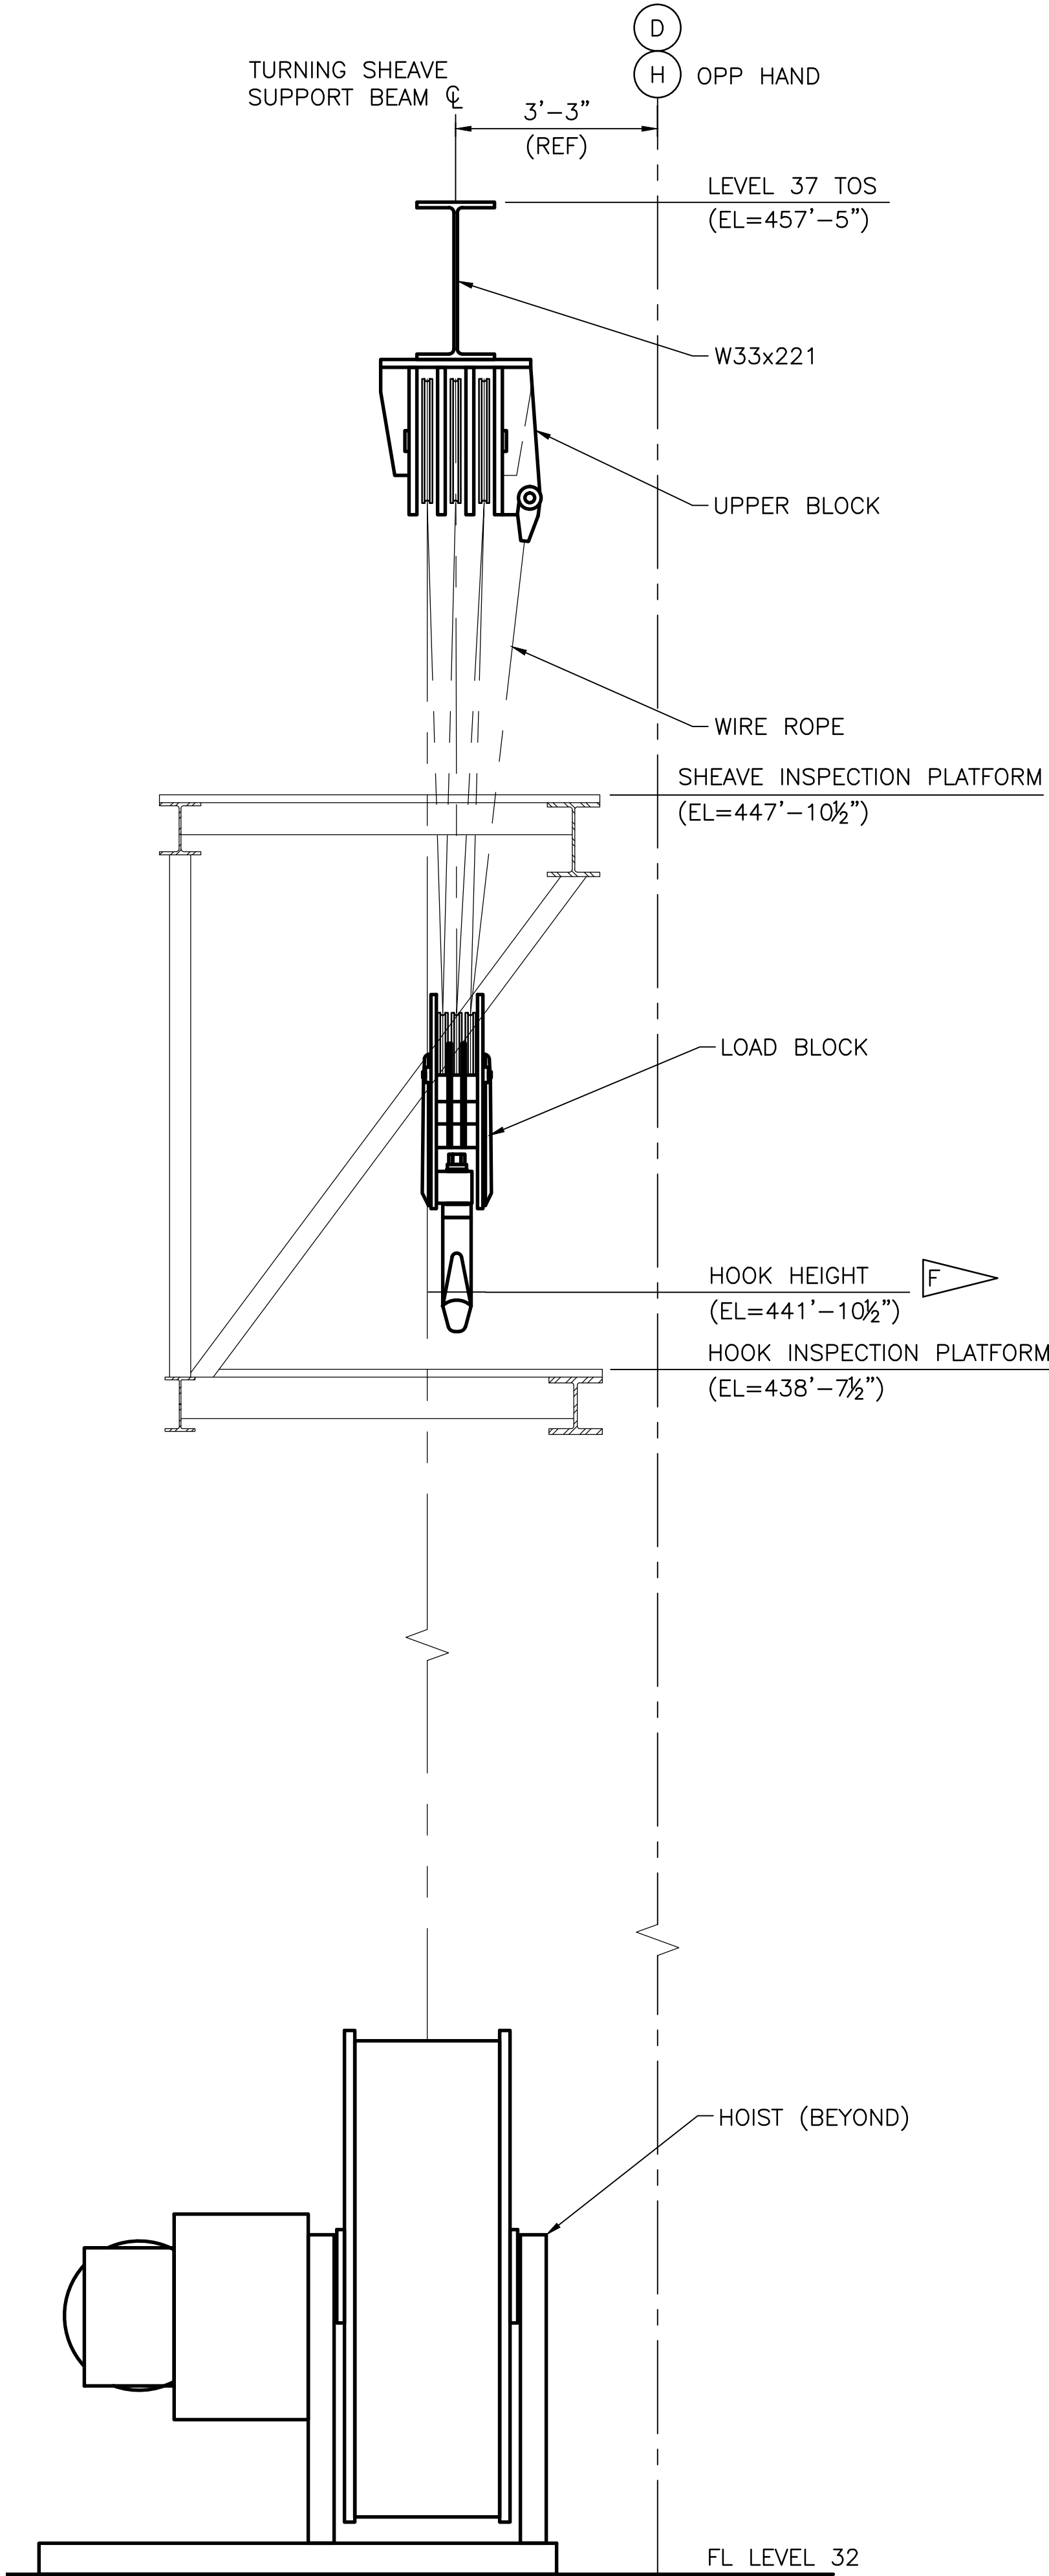
M-810

SYM	ZONE	DESCRIPTION	DATE	APPROVAL
REVISIONS				
SIGNATURES		DATE	<div>RSH IMPROVING YOUR WORLD</div> <div>Reynolds, Smith and Hills, Inc. 115 Alma Blvd, Suite 101 Merritt Island, Florida 32953-4101 (321) 453-0212 (321) 453-0223 FAX www.rsandh.com</div> <div>NATIONAL AERONAUTICS AND SPACE ADMINISTRATION JOHN F. KENNEDY SPACE CENTER, NASA KENNEDY SPACE CENTER, FLORIDA</div> <div>LAUNCH COMPLEX 39 VEHICLE ASSEMBLY BUILDING MODIFY VEHICLE ASSEMBLY BUILDING HIGH BAY 3 FOR SLS - HOISTS ELEVATOR LANDINGS HOISTS AT FLOOR LEVEL 36 PLAN</div>	
DRAWN:	JOSEPH HAUER	08-20-2013		
CHECKED:	JIM STAPP	08-20-2013		
SUBMITTED ARCHIVING OF RECORD				
ST. OF LICENSURE:	FL			
LICENSE NO.:				
APPROVED:				
JOHN KERESMAR			FILE NO. 302-6058-043	SIZE E
MIKE HARTNETT			PROJ. NO. PCN 99000.5	SHEET 25 OF


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- SPECIFIC NOTES:**
- A. EXTENSIBLE PLATFORM HOISTS PER 79K39668 (MODIFY VEHICLE ASSEMBLY BUILDING HIGH BAY 3 FOR SLS - HOISTS, SECTION 41 22 23.19.
 - B. THE CONTRACTOR SHALL PROVIDE SECONDARY FRAMING TO SUPPORT REACTION LOADS FROM HOIST EQUIPMENT AS WELL AS SUPPORTING OPENINGS IN THE FLOOR REQUIRED TO SUPPORT HIS LAYOUT. CONTRACTOR FRAMING PLANS SHALL BE SIGNED AND SEALED BY A FLORIDA LICENSED STRUCTURAL ENGINEER. THE CONTRACTOR SHALL REFER TO DRAWING S-3-074 FOR AS-BUILT INFORMATION FOR EXISTING FRAMING ON THE LEVEL.
 - C. EXTENSIBLE PLATFORM MAXIMUM TRAVEL HEIGHT IS LEVEL 34.
 - D. CONTRACTOR TO INSTALL HOISTS AS REQUIRED TO MAINTAIN HOOK CENTERLINE AS INDICATED.
 - E. EXTENSIBLE PLATFORM HOISTS TO BE POSITIONED SUCH TO ALLOW ADEQUATE ROOM AROUND EACH HOIST FOR MAINTENANCE.
 - F. HOIST HOOK AT STOWED POSITION WITH 85 FEET OF DOWNWARD TRAVEL REQUIRED FROM THIS ELEVATION.
 - G. CONDUITS USED IN THE INSTALLATION OF THE HOIST MOTORS AND THEIR REQUIRED CONTROL ACCESSORIES SHALL BE RUN IN ACCORDANCE WITH SPECIFICATION 26 05 00.00 40. CONDUITS SHALL NOT BE ROUTED ALONG WALKING SURFACES OR IN A MANNER THAT RESTRICTS ACCESS OR EGRESS FROM THE SPACE IN WHICH IT IS INSTALLED. COORDINATE WITH CONTRACTING OFFICER WHEN ROUTING.

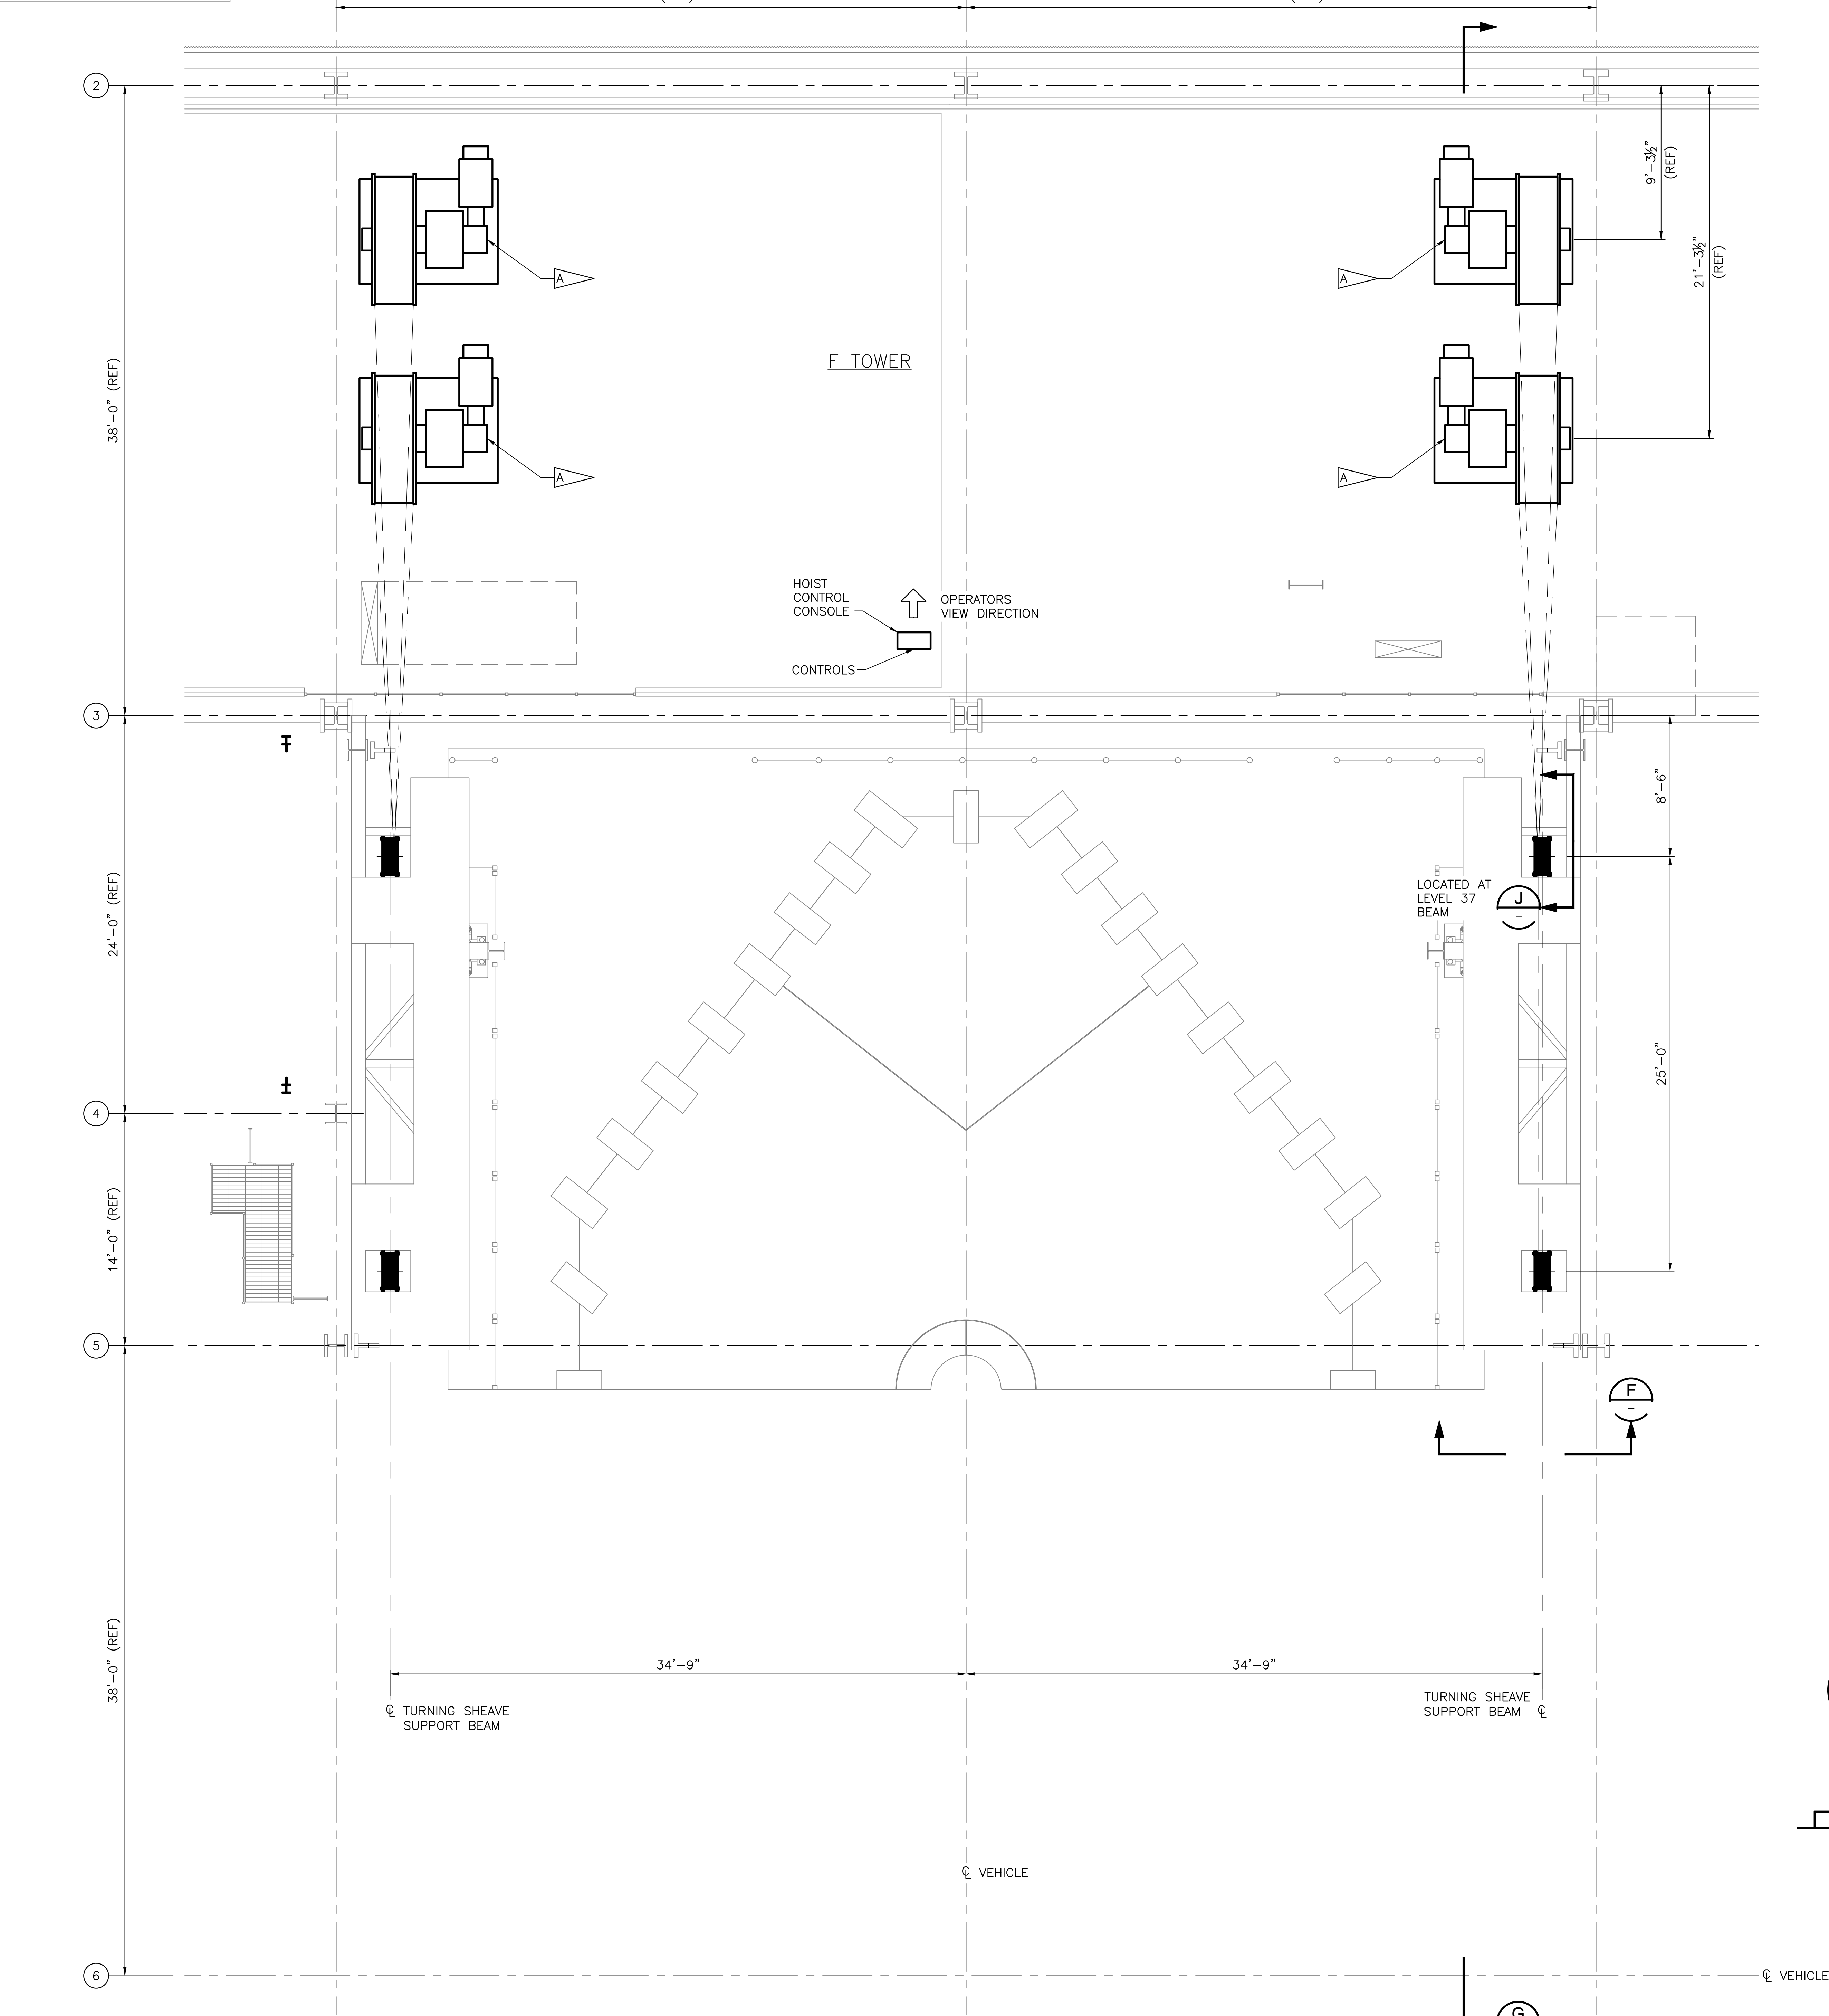

ELEVATION VIEW
SCALE: NTS




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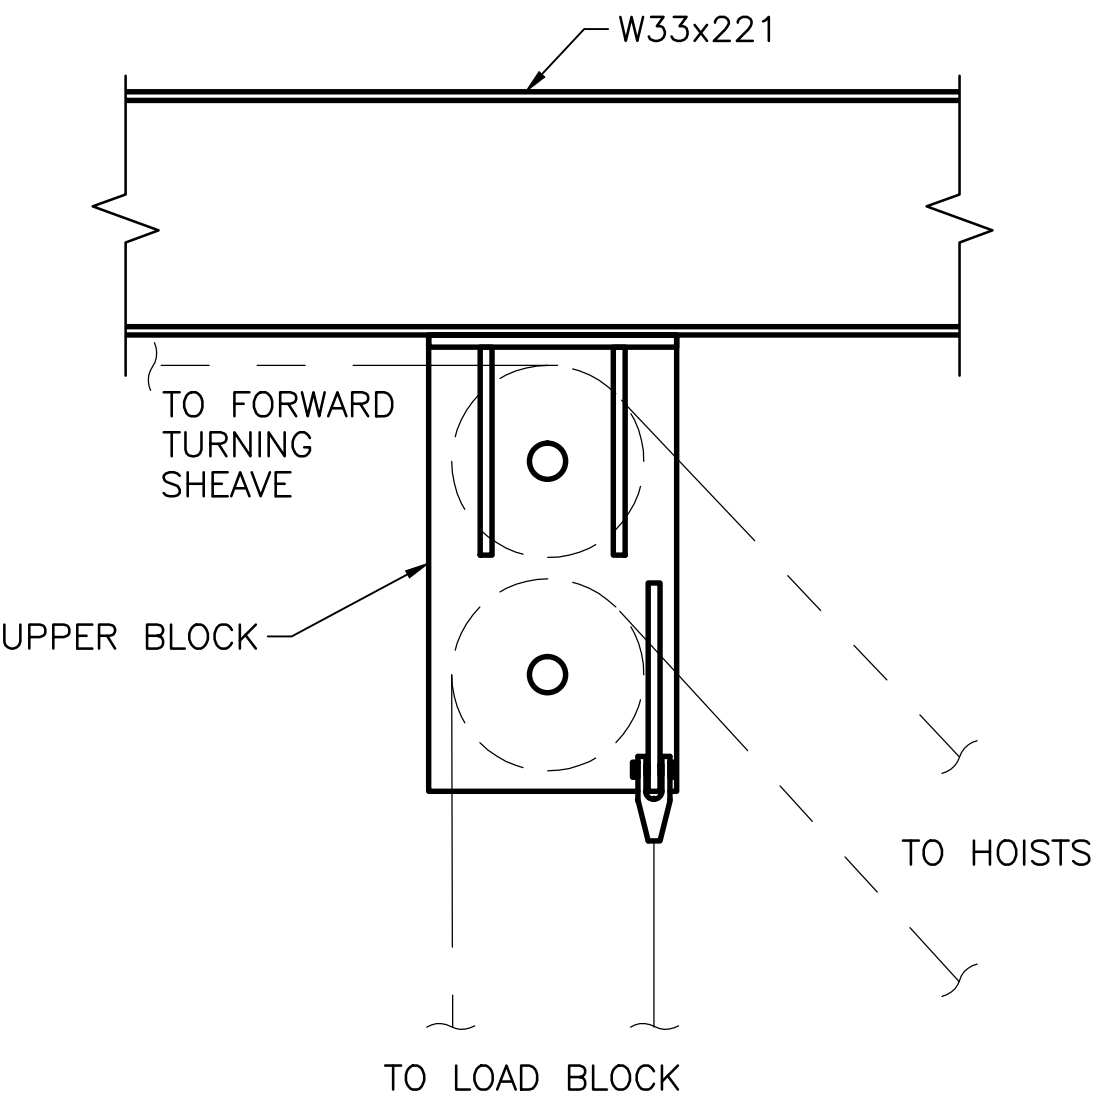
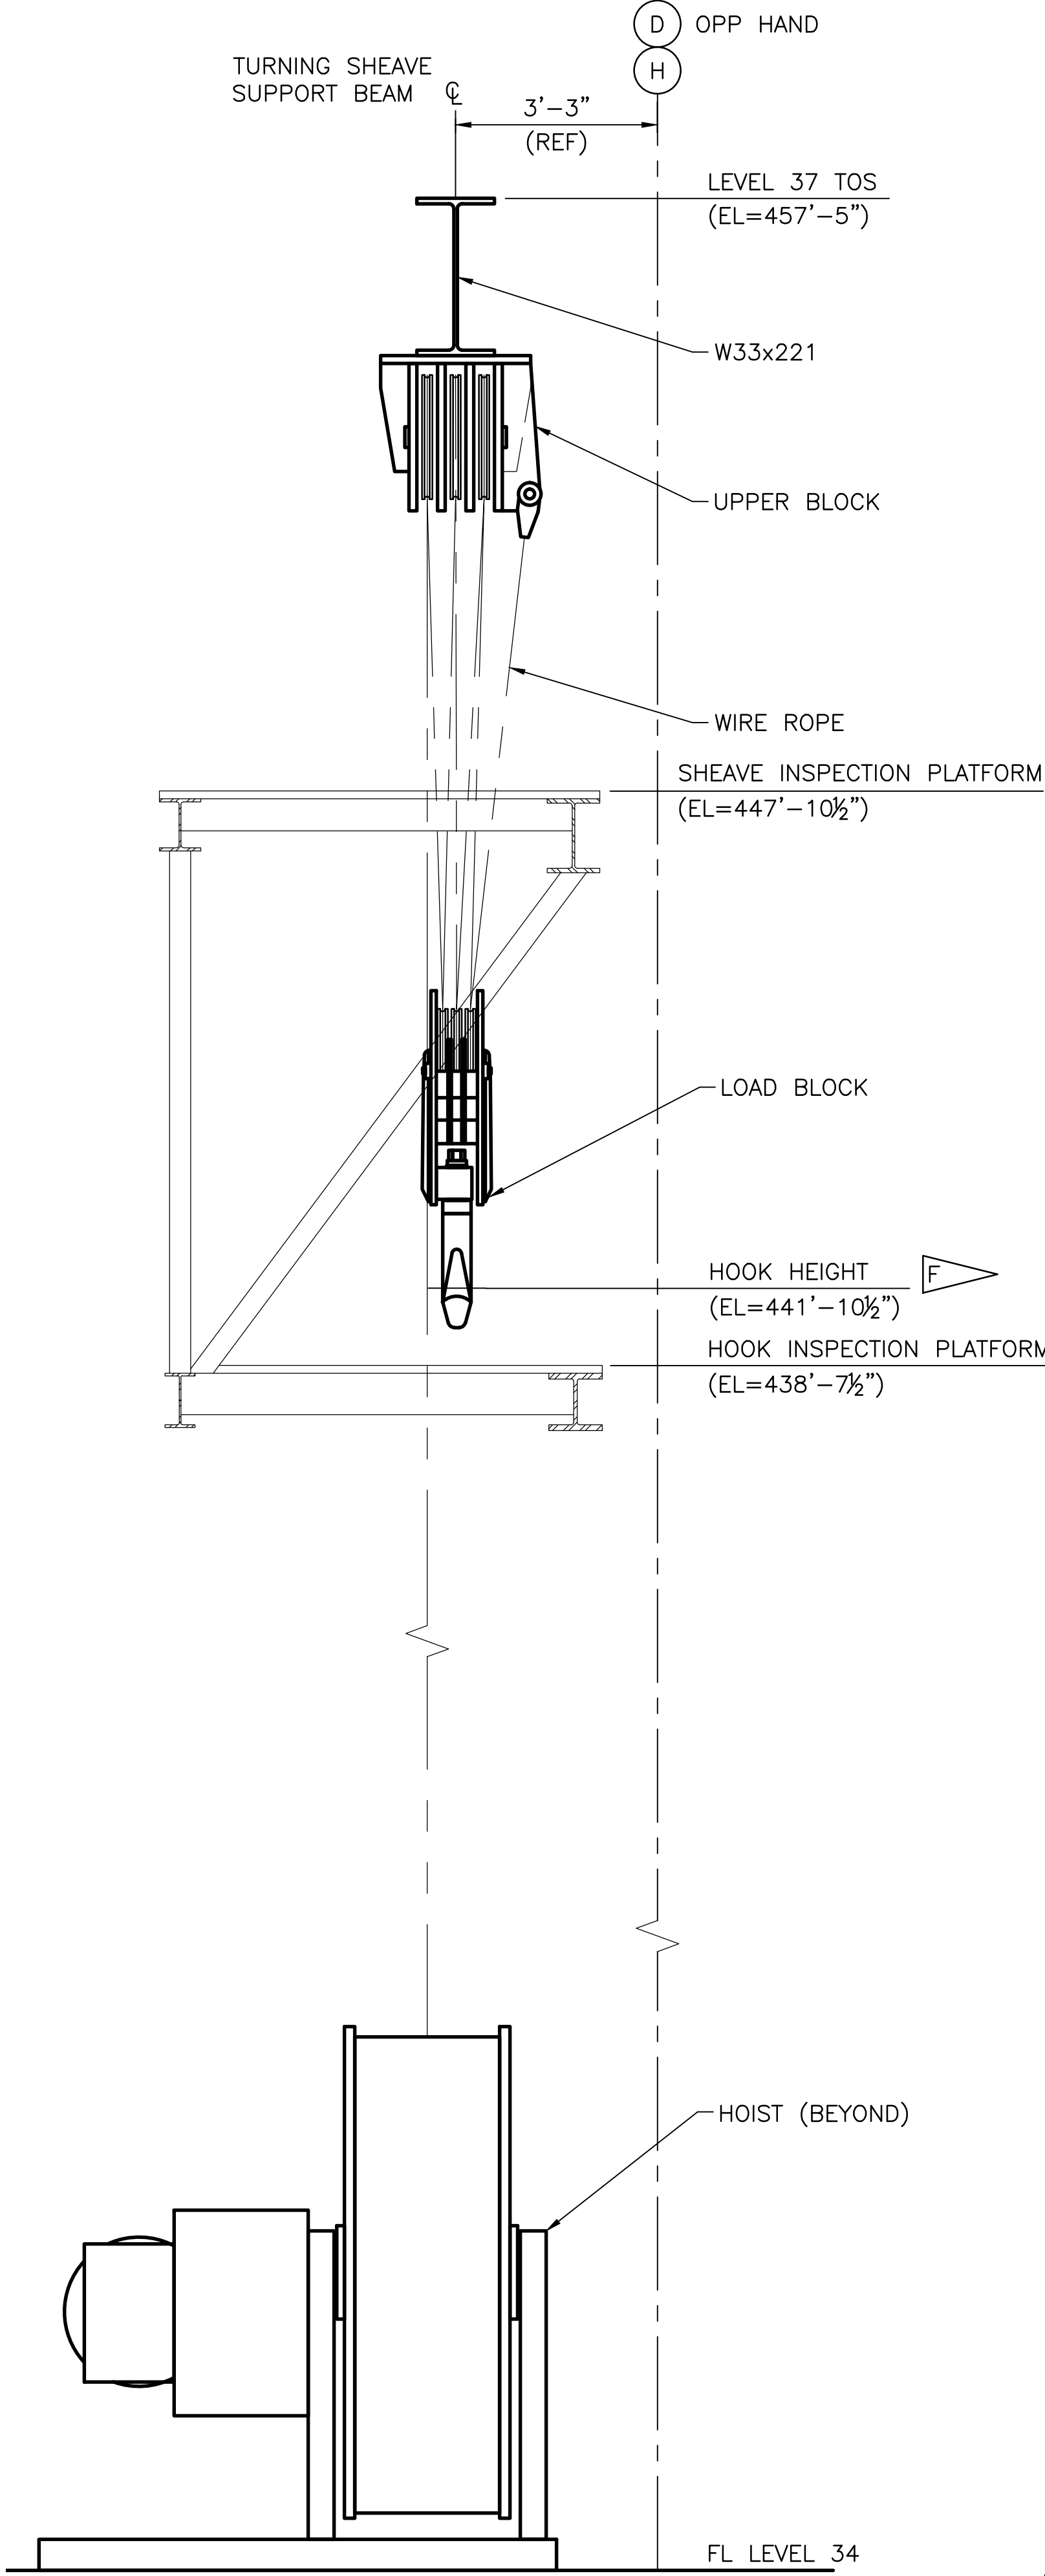
M-811
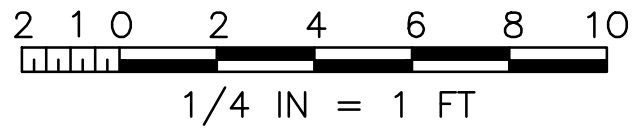
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REVISIONS				
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SIGNATURES		DATE		
DRAWN: JOSEPH HAUER	08-20-2013			
CHECKED: JIM STAPP	08-20-2013			
SUBMITTED ARCHIVING OF RECORD				
ROBERT PRUSS				
ST OF LICENSURE: FL				
LICENSE NO.:				
APPROVED:				
JOHN KERNSHAW		302-6058-043		
MIKE HARTNETT		302-6058-043		
<div><div><div><div><div><div>RS&H</div><div>IMPROVING YOUR WORLD</div></div></div><div><div><div></div><div></div><div></div></div></div></div></div><div>Reynolds, Smith and Hills, Inc. 115 Alma Blvd., Suite 101 Merritt Island, Florida 32953-4101 (321) 453-0212 (321) 453-0223 FAX www.rsandh.com</div></div>				
NATIONAL AERONAUTICS AND SPACE ADMINISTRATION				
JOHN F. KENNEDY SPACE CENTER, NASA				
KENNEDY SPACE CENTER, FLORIDA				
LAUNCH COMPLEX 39				
VEHICLE ASSEMBLY BUILDING				
MODIFY VEHICLE ASSEMBLY BUILDING				
HIGH BAY 3 FOR SLS – HOISTS				
EXTENSIBLE PLATFORMS HOISTS				
AT FLOOR LEVEL 32 PLAN				
FILE NO.	SIZE	DWG NO.	REV	
302-6058-043	E	79K39667		
PROJ. NO.	PCN	99000.5	SHEET	26 OF

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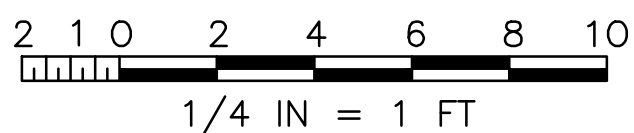


- SPECIFIC NOTES:**
- A. EXTENSIBLE PLATFORM HOISTS PER 79K39668 (MODIFY VEHICLE ASSEMBLY BUILDING HIGH BAY 3 FOR SLS - HOISTS), SECTION 41 22 23.19.
 - B. THE CONTRACTOR SHALL PROVIDE SECONDARY FRAMING TO SUPPORT REACTION LOADS FROM HOIST EQUIPMENT AS WELL AS SUPPORTING OPENINGS IN THE FLOOR REQUIRED TO SUPPORT HIS LAYOUT. CONTRACTOR FRAMING PLANS SHALL BE SIGNED AND SEALED BY A FLORIDA LICENSED STRUCTURAL ENGINEER. THE CONTRACTOR SHALL REFER TO DRAWING S-3-074 FOR AS-BUILT INFORMATION FOR EXISTING FRAMING ON THE LEVEL.
 - C. EXTENSIBLE PLATFORM MAXIMUM TRAVEL HEIGHT IS LEVEL 34.
 - D. CONTRACTOR TO INSTALL HOISTS AS REQUIRED TO MAINTAIN HOOK CENTERLINE AS INDICATED.
 - E. EXTENSIBLE PLATFORM HOISTS TO BE POSITIONED SUCH TO ALLOW ADEQUATE ROOM AROUND EACH HOIST FOR MAINTENANCE.
 - F. HOIST HOOK AT STOWED POSITION WITH 85 FEET OF TRAVEL FROM THIS ELEVATION.
 - G. CONDUITS USED IN THE INSTALLATION OF THE HOIST MOTORS AND THEIR REQUIRED CONTROL ACCESSORIES SHALL BE RUN IN ACCORDANCE WITH SPECIFICATION 26 05 00.00 40. CONDUITS SHALL NOT BE ROUTED ALONG WALKING SURFACES OR IN A MANNER THAT RESTRICTS ACCESS OR EGRESS FROM THE SPACE IN WHICH IT IS INSTALLED. COORDINATE WITH CONTRACTING OFFICER WHEN ROUTING.

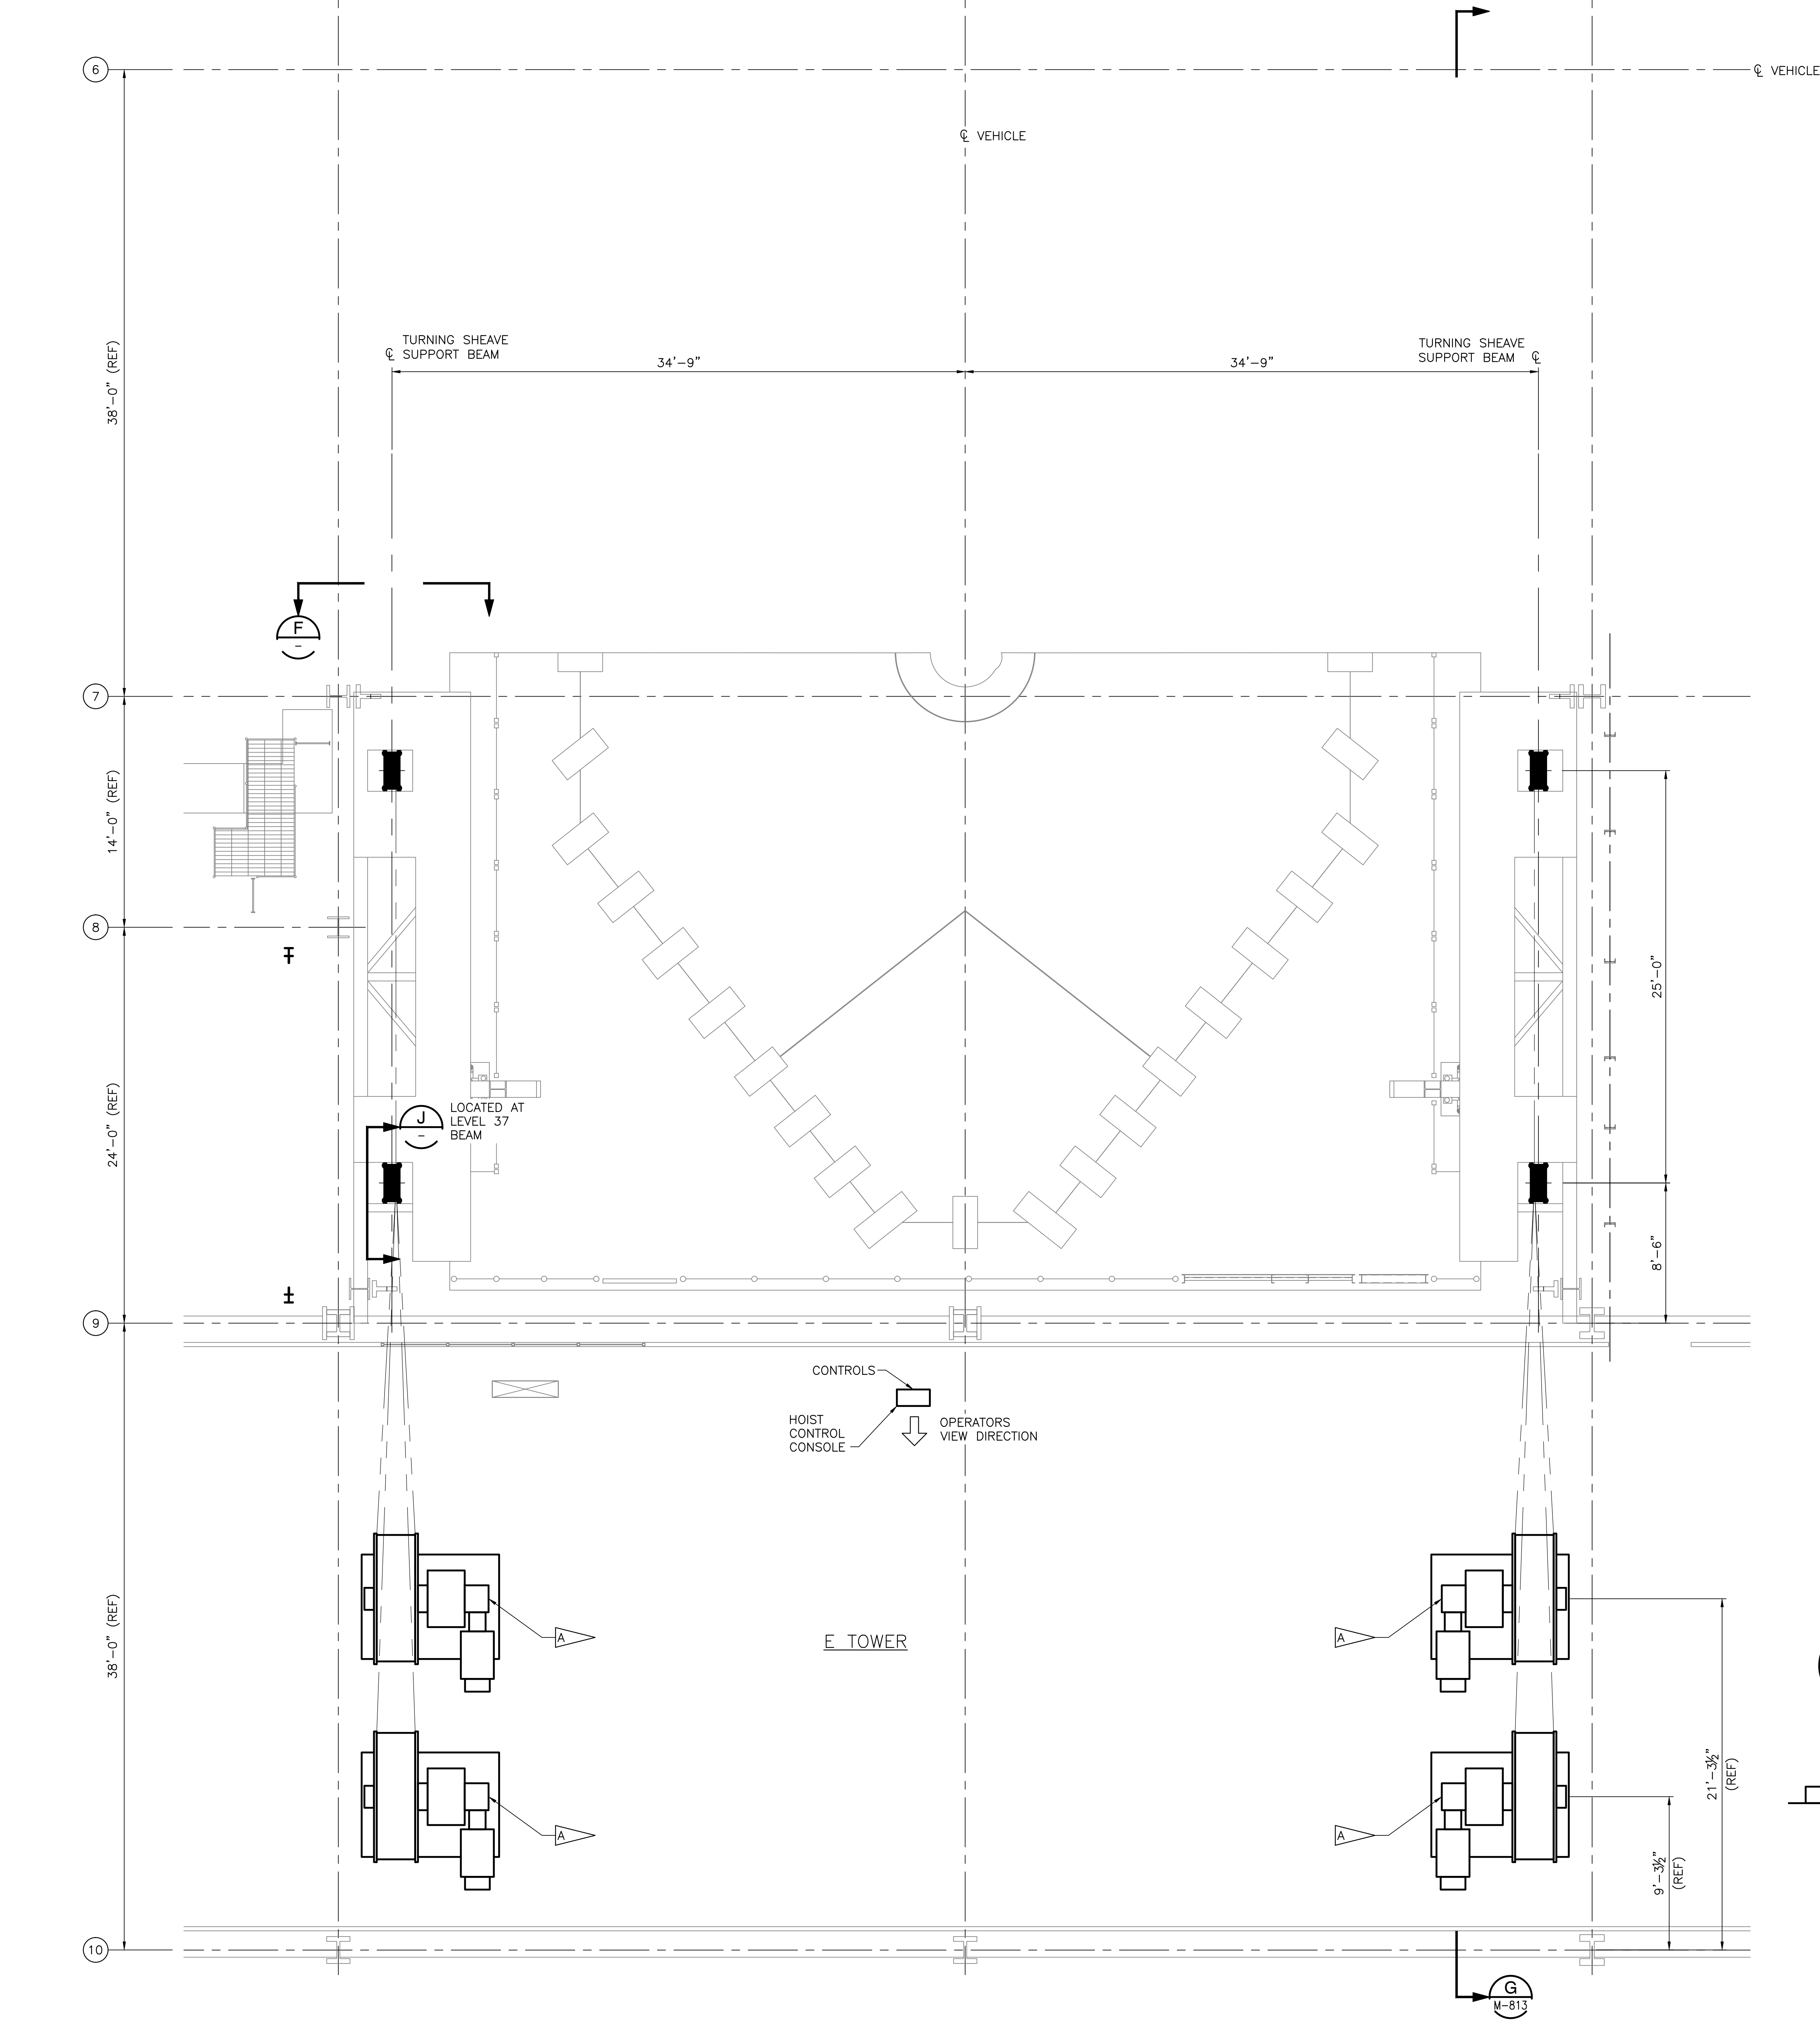

ELEVATION VIEW
SCALE: NTS

ELEVATION VIEW
SCALE: NTS




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M-812

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NATIONAL AERONAUTICS AND SPACE ADMINISTRATION JOHN F. KENNEDY SPACE CENTER, NASA KENNEDY SPACE CENTER, FLORIDA				
LAUNCH COMPLEX 39 VEHICLE ASSEMBLY BUILDING MODIFY VEHICLE ASSEMBLY BUILDING HIGH BAY 3 FOR SLS - HOISTS EXTENSIBLE PLATFORMS HOISTS AT FLOOR LEVEL 34 PLAN				
SIGNATURES	DATE	FILE NO.	SIZE	TOWNSHIP
DRAWN: JOSEPH HAUER	08-20-2013	302-6058-043	E	79K39667
CHECKED: JIM STAPP	08-20-2013	302-6058-043	E	79K39667
SUBMITTED ARCHIVING OF RECORD				
ROBERT PRUSS				
ST. OF LICENSURE: FL				
LICENSE NO.				
APPROVED:				
JOHN KERKMAR				
MIKE HARTNETT				
PROJ. NO.	PCN 99000.5	SHEET 27	OF	

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SPECIFIC NOTES:

- A PLATFORM HOISTS.
B EXTENSIBLE PLATFORM MAXIMUM TRAVEL HEIGHT IS LEVEL 34.

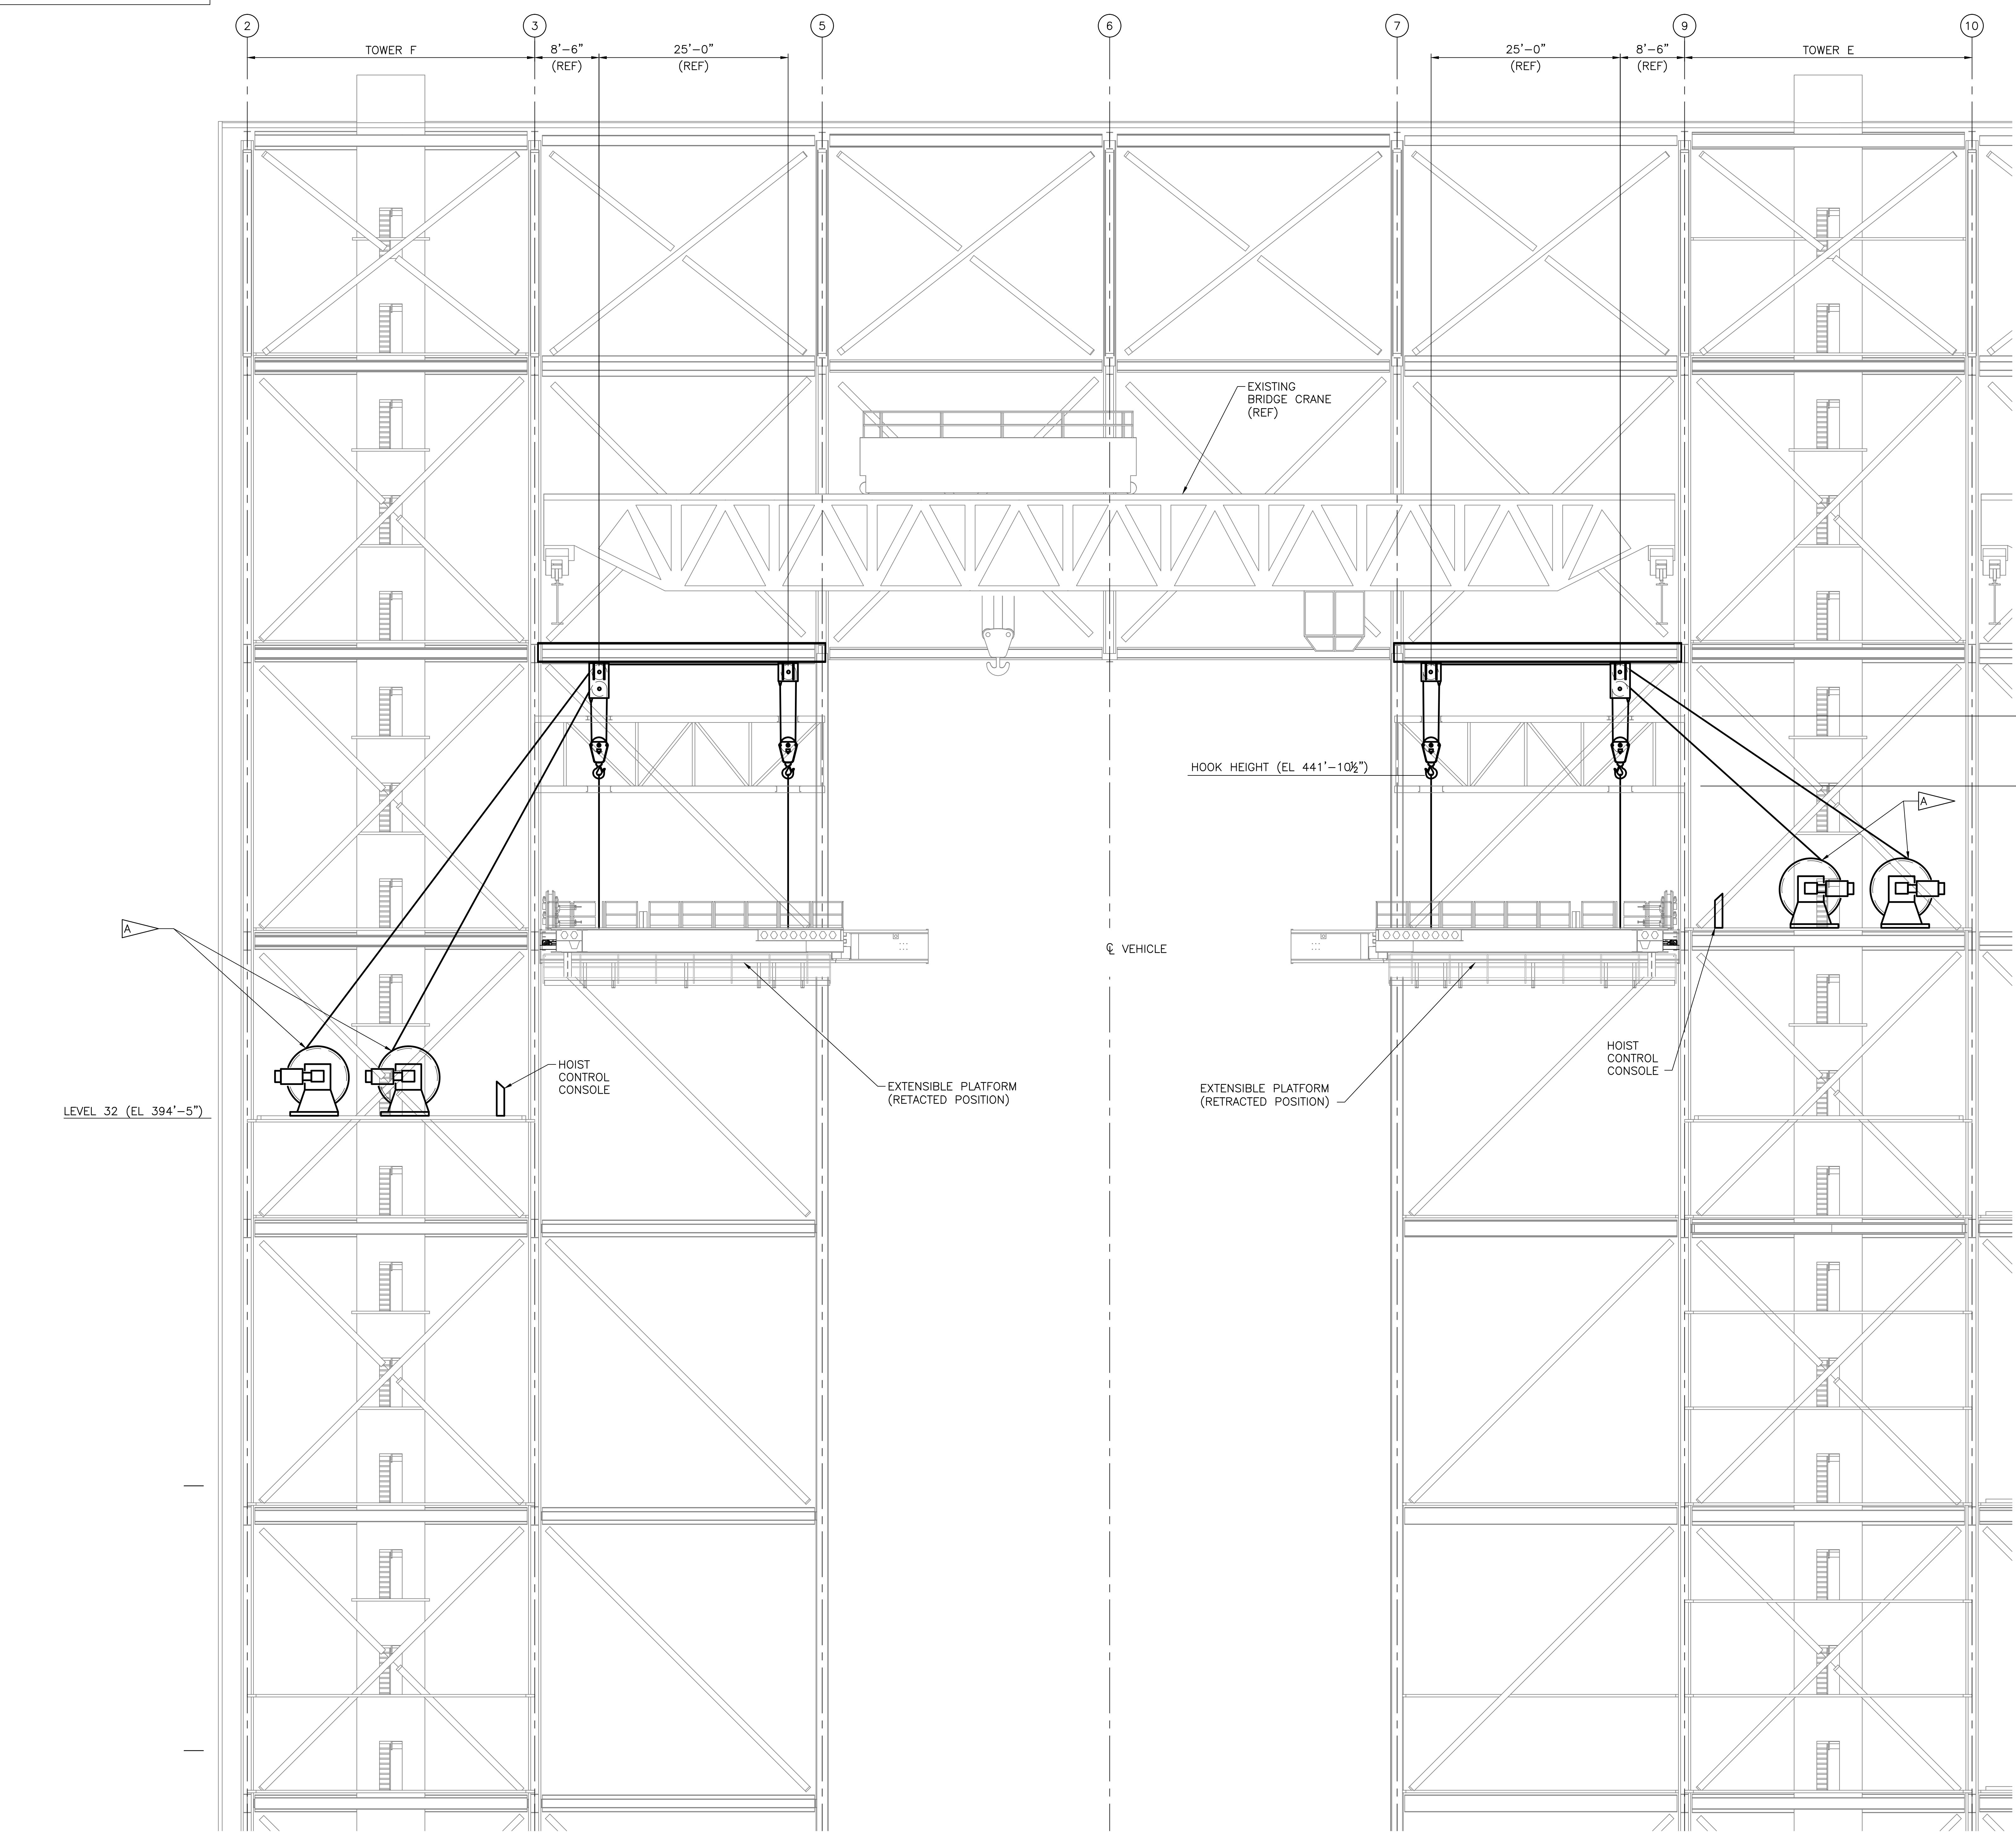SECTION
SCALE: 1/8"=1'-0"

G
M-811 M-812

4 2 0 4 8 12 16 20
1/8 IN = 1 FT

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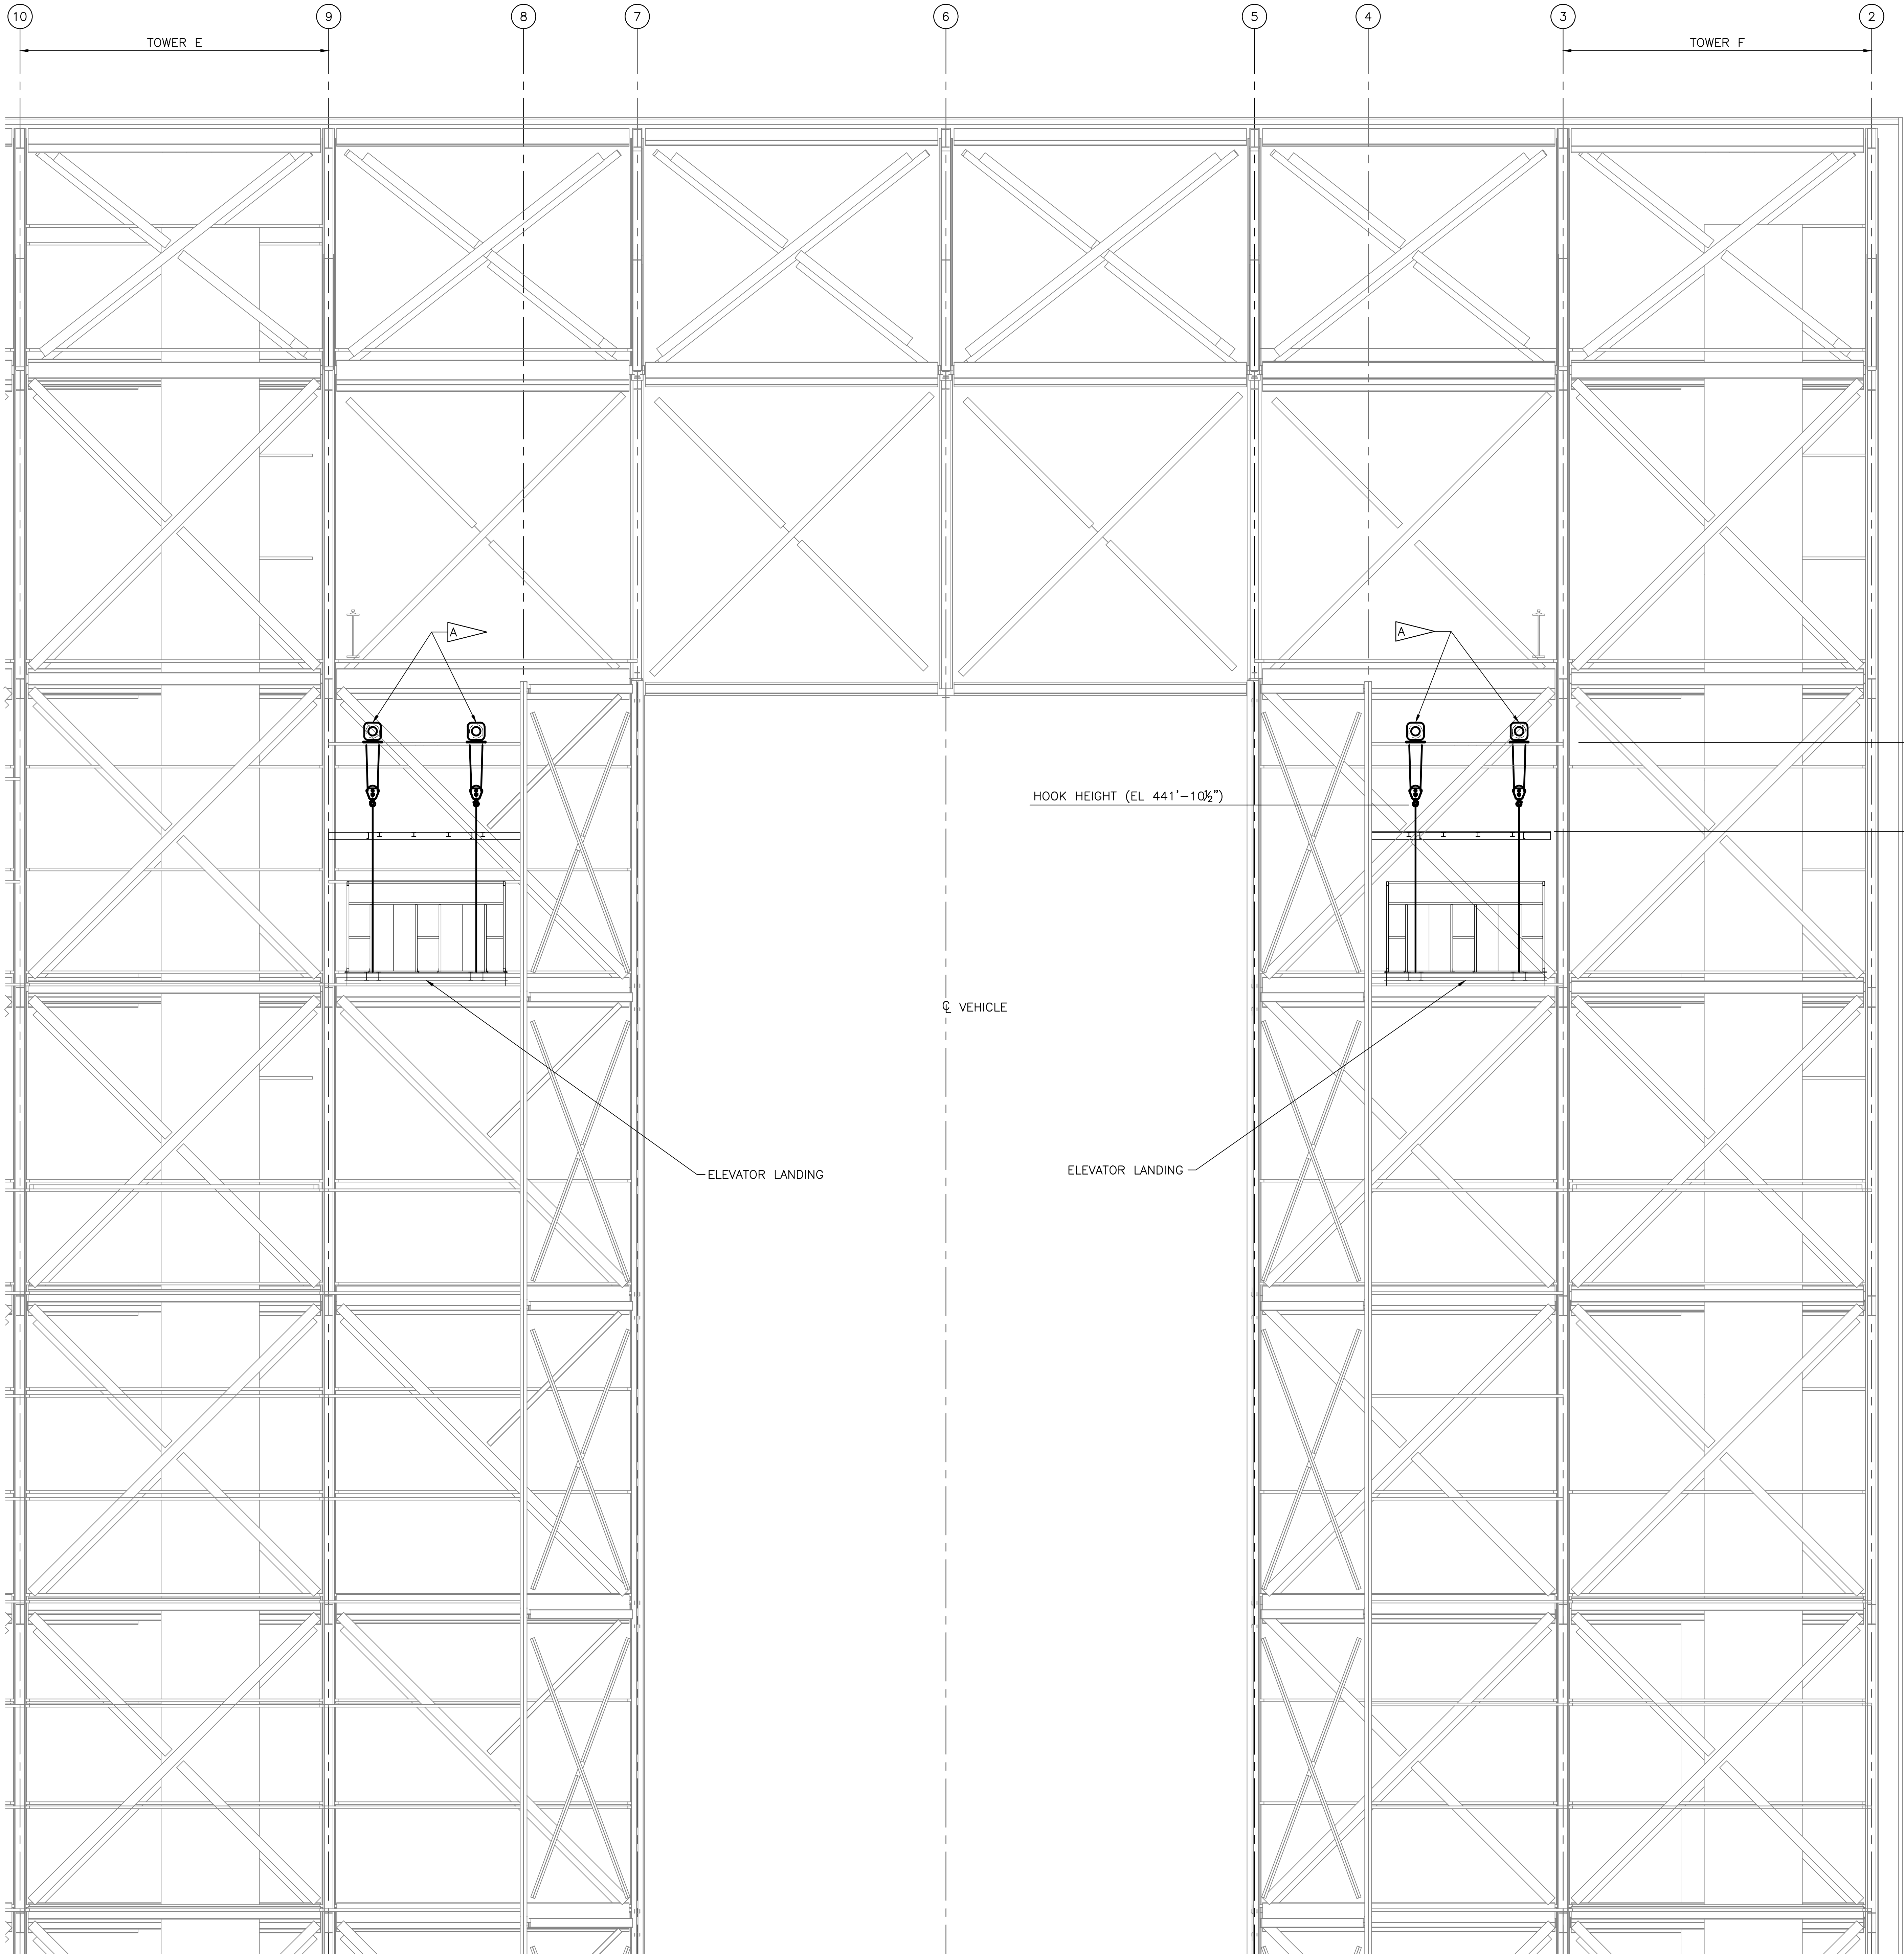
M-813

SYM	ZONE	DESCRIPTION	DATE	APPROVAL
REVISIONS				
		RSH IMPROVING YOUR WORLD		
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SIGNATURES		NATIONAL AERONAUTICS AND SPACE ADMINISTRATION		
DRAWN: JOSEPH HAUER		JOHN F. KENNEDY SPACE CENTER, NASA		
CHECKED: JIM STAPP		KENNEDY SPACE CENTER, FLORIDA		
SUBMITTED ARCHIVING OF RECORD		LAUNCH COMPLEX 39		
ROBERT PRUSS		VEHICLE ASSEMBLY BUILDING		
ST. OF LICENSURE: FL		MODIFY VEHICLE ASSEMBLY BUILDING		
LICENSE NO:		HIGH BAY 3 FOR SLS - HOISTS		
APPROVED:		EXTENSIBLE PLATFORMS HOISTS		
JOHN KEROMAR		ELEVATION		
MIKE HARTNETT		FILE NO. 302-6058-043		
		SIZE 302-6058-043		
		TOWNSHIP NO. E 79K39667		
		PROJ. NO. PCN 99000.5		
		SHEET 28 OF		

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SPECIFIC NOTES:

- A ELEVATOR LANDING HOISTS.
B ELEVATOR LANDING MAXIMUM TRAVEL HEIGHT IS LEVEL 34.



LEVEL 37 (EL 457'-9")

ELEVATOR MACHINE ROOM (EL 449'-7")

LEVEL 36 (EL 445'-1")

HOOK INSPECTION PLATFORM (EL 438'-7½")

LEVEL 35 (EL 432'-5")

LEVEL 34 (EL 419'-9") B

SECTION
SCALE: 1/8"=1'-0"

H
M-810

4 2 0 4 8 12 16 20
1/8 IN = 1 FT

WHEN PRINTED FULL SIZE, THIS SHEET IS 34"x44"
THIS COMPUTER DRAWING WAS
CREATED IN AUTOCAD AND
FILED UNDER THE DRAWING NUMBER

M-814

SYM	ZONE	DESCRIPTION	DATE	APPROVAL
REVISIONS				
SIGNATURES		DATE	<div>RSH IMPROVING YOUR WORLD</div> <div>Reynolds, Smith and Hills, Inc. 115 Alma Blvd., Suite 101 Merritt Island, Florida 32953-4101 (321) 453-0212 (321) 453-0223 FAX www.rsandh.com</div> <div>NATIONAL AERONAUTICS AND SPACE ADMINISTRATION JOHN F. KENNEDY SPACE CENTER, NASA KENNEDY SPACE CENTER, FLORIDA</div> <div>LAUNCH COMPLEX 39 VEHICLE ASSEMBLY BUILDING MODIFY VEHICLE ASSEMBLY BUILDING HIGH BAY 3 FOR SLS - HOISTS ELEVATOR LANDINGS HOISTS ELEVATION</div>	
DRAWN:	JOSEPH HAUER	08-20-2013		
CHECKED:	JIM STAPP	08-20-2013		
SUBMITTED ARCHIVING OF RECORD				
ST. OF LICENSURE:	FL			
LICENSE NO.:				
APPROVED:				
JOHN KERESMAR			FILE NO. 302-6058-043	SIZE E
MIKE HARTNETT			SIZE D	79K39667
PROJ. NO.	PCN 99000.5	SHEET 29	OF	REV

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H

G

F

E

D

C

B

A

ATTACH SLING
(441.875') HOOK STOWED POSITION

356.875'
(HOOK LOWERED 85'-0")

345.375'


259.125'

172.875'


86.625'

.375' BOTTOM OF SLING
0'


EXTENSIBLE PLATFORM SLING SCHEDULE
SCALE:NTS

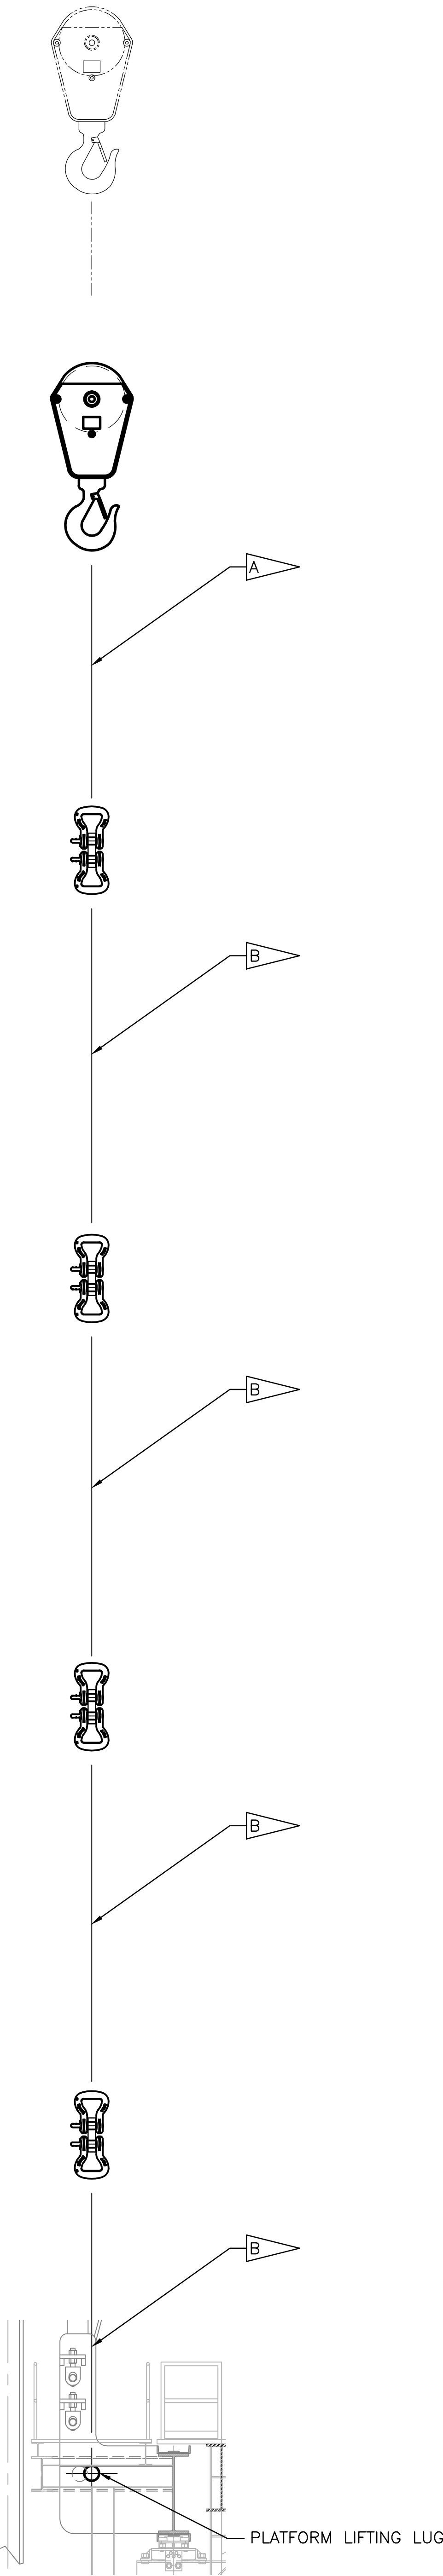

(78.75')
(FIRST HOLE IN RAIL)

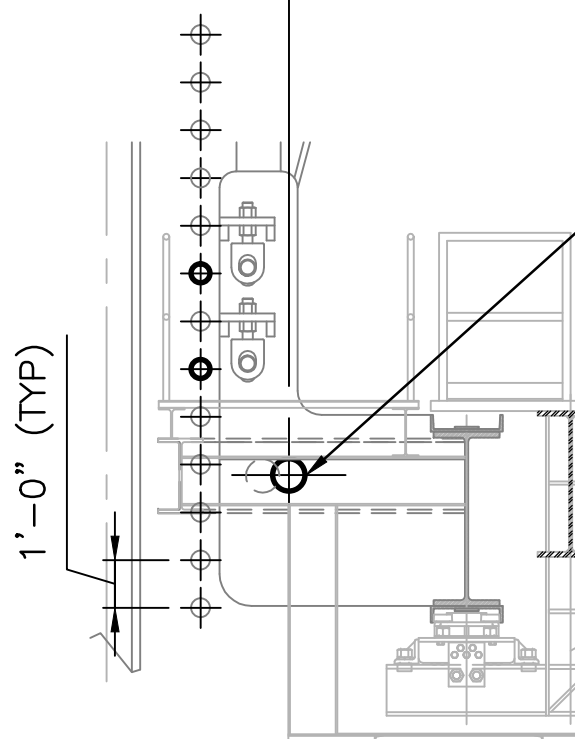

EXTENSIBLE PLATFORM SLING SCHEDULE (RAISING PLATFORM)
SCALE:NTS

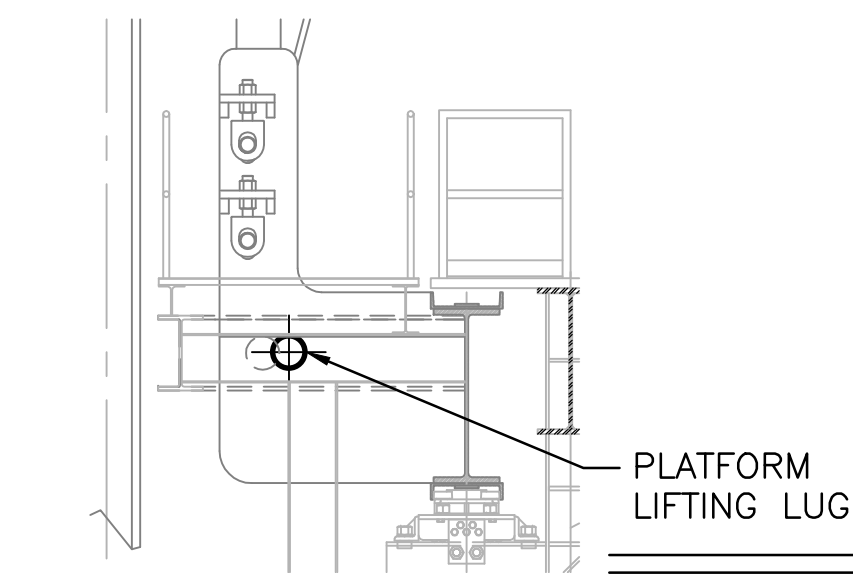

441.875'

356.875'

331.240'

247.185'

163.960'

85.000'


81.565' (1% SLING STRETCH)

.375' BOTTOM OF SLING
0'

SPECIFIC NOTES:


- A. TPXCF15000-11.5. SLING 150000 LBS VRC W/K-SPEC(R) FIBER AND COVERMAX(TM) COVER, W/CHECK FAST (R) INSPECTION SYSTEM, SLING MAX RIGGING SOLUTIONS (OAE).
- B. TPXCF15000-83. SLING 150000 LBS VRC W/K-SPEC(R) FIBER AND COVERMAX(TM) COVER, W/CHECK FAST (R) INSPECTION SYSTEM, SLING MAX RIGGING SOLUTIONS (OAE).
- C. G-2160 CROSBY "WIDE BODY" SHACKLE P/N 1021290 75 TON (OAE).
- D. A-342 MASTERLINK P/N 1014468 80 TON (OAE).
- E. DO NOT ENGAGE LOWER CORBEL PIN BELOW ELEVATION 78.750' TO ENSURE BOTH CORBEL PINS ARE ENGAGED PRIOR TO REMOVING SLINGS.
- F. HOIST TRAVEL IS 85.000'. DIMENSION SHOWN IS FROM ELEVATION 0.000' WITHOUT PLATFORM.
- G. HOIST TRAVEL IS 85.000'. DIMENSIONS SHOWN ARE FROM ELEVATION 0' WITH PLATFORM BEING LIFTED (INCLUDING SLING STRETCH OF 1%).
- H. IN ORDER TO ACCOUNT FOR THE 1% SLING STRETCH, AFTER HOOK IS RAISED 85.000' AND EXTENSIBLE PLATFORM CORBEL PINS ARE ENGAGED, REMOVE AND REPLACE THE LOWEST 83.000' SLING SEGMENT WITH A 5' SLING (P/N TPXCF15000-5). LOWER HOOK AND ATTACH THE 5' SLING TO PLATFORM LIFTING LUG, RAISE EXTENSIBLE PLATFORM TO MAXIMUM AVAILABLE TRACK HOLE LOCATION, AFTER CORBEL PINS ARE ENGAGED REMOVE 5' SLING AND ATTACH REMAINING SLING ASSEMBLY TO THE PLATFORM LIFTING LUG.
- J. PRIOR TO TURNING OVER SLINGS TO NASA THEY MUST BE INSPECTED BY NASA QUALITY TO ENSURE SLINGS HAVE NOT BEEN DAMAGED AND ARE STILL IN USABLE CONDITION.
- K. SLINGS SHALL BE STORED IN A REUSABLE CRATE WITH NO MORE THAN 4 SLINGS PER CRATE.

SLING / HARDWARE REQD PER HOIST	
QTY	TYPE
4X	TPXCF15000-83 (83')
1X	TPXCF15000-11.5 (11'-6")
1X	TPXCF15000-5 (5')
8X	G2160 SHACKLE P/N 1021290 (75 TON)
4X	A-342 MASTER LINK P/N 1014468 (80 TON)

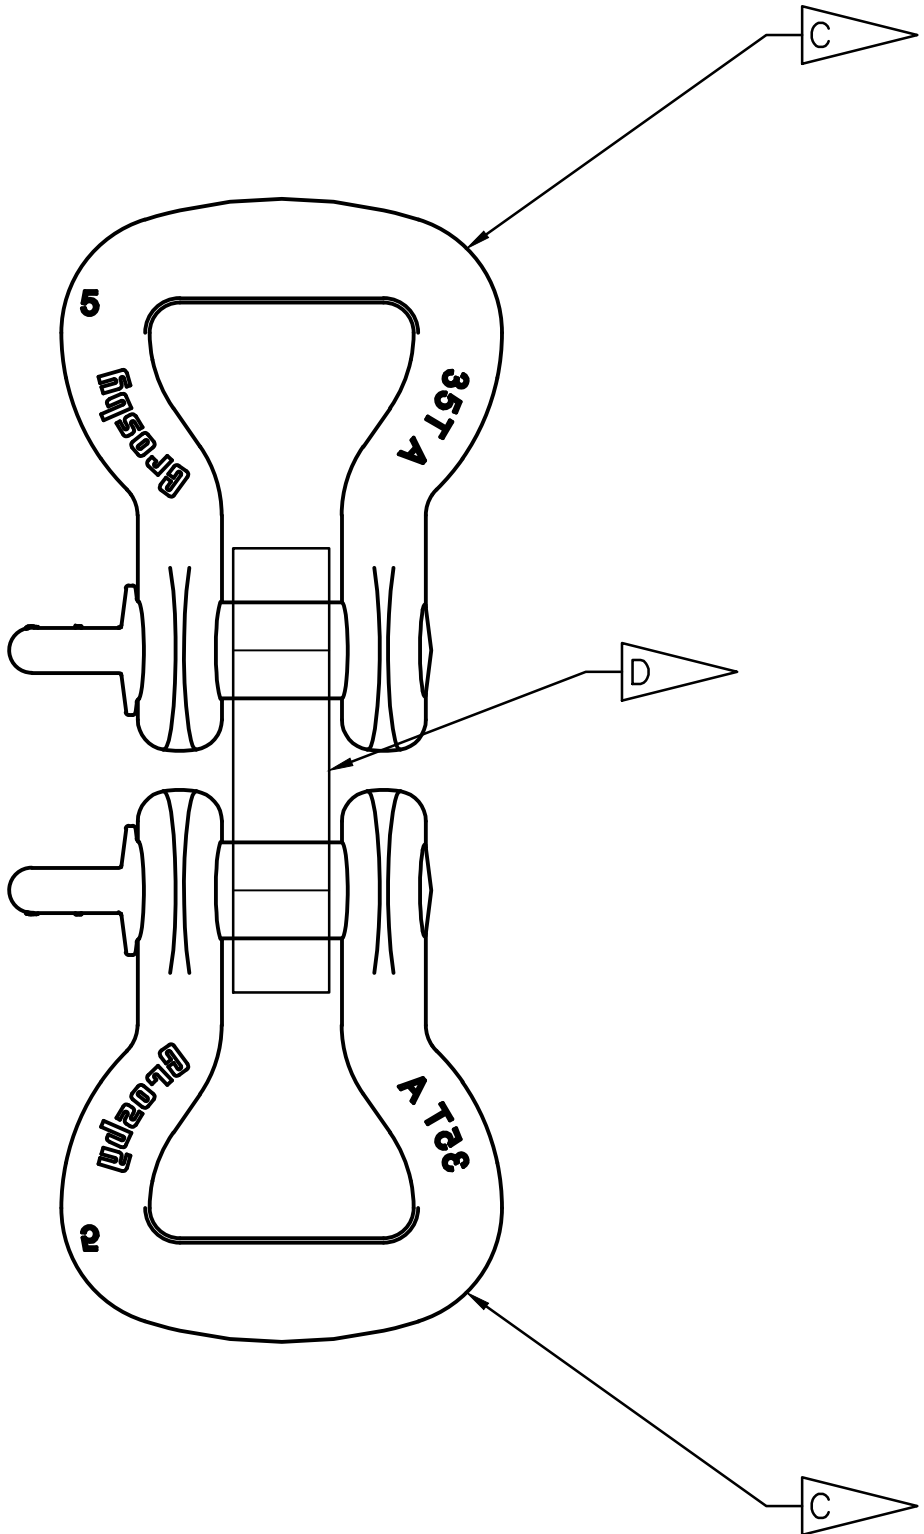

SLING SHACKLE ASSEMBLY
SCALE:3"=1'-0"

1
-

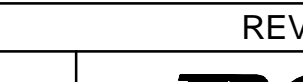SYM	ZONE	DESCRIPTION	DATE	APPROVAL
REVISIONS				
SIGNATURES		DATE		
DRAWN: JOSEPH HAUER	08-20-2013	<div><div></div><div>Reynolds, Smith and Hills, Inc. 115 Alma Blvd, Suite 101 Merritt Island, Florida 32953-4101 (321) 453-0212 (321) 453-0223 FAX www.rsandh.com</div></div> <div>NATIONAL AERONAUTICS AND SPACE ADMINISTRATION JOHN F. KENNEDY SPACE CENTER, NASA KENNEDY SPACE CENTER, FLORIDA</div> <div>LAUNCH COMPLEX 39 VEHICLE ASSEMBLY BUILDING MODIFY VEHICLE ASSEMBLY BUILDING HIGH BAY 3 FOR SLS - HOISTS EXTENSIBLE PLATFORMS HOISTS SLING SCHEDULE</div> <div>FILE NO. 302-6058-043 SIZE E DWG. NO. 79K39667 REV</div>		
CHECKED: JIM STAPP	08-20-2013			
SUBMITTED ARCHIVING OF RECORD				
ROBERT PRUSS				
ST. OF LICENSEURE: FL				
LICENSE NO:				
APPROVED:				
JOHN KERESMARE				
MIKE HARTNETT		PROJ. NO. PCN 99000.5 SHEET 30 OF		

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THIS COMPUTER DRAWING WAS
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FILED UNDER THE DRAWING NUMBER

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H

G

F

E

D

C

B

A

ATTACH SLING
(441.875') HOOK STOWED POSITION

356.875'
(HOOK LOWERED 85'-0")

340.375'


256.480'

172.585'

88.690'


.295' BOTTOM OF SLING
0'

ELEVATOR PLATFORM SLING SCHEDULE
SCALE:NTS

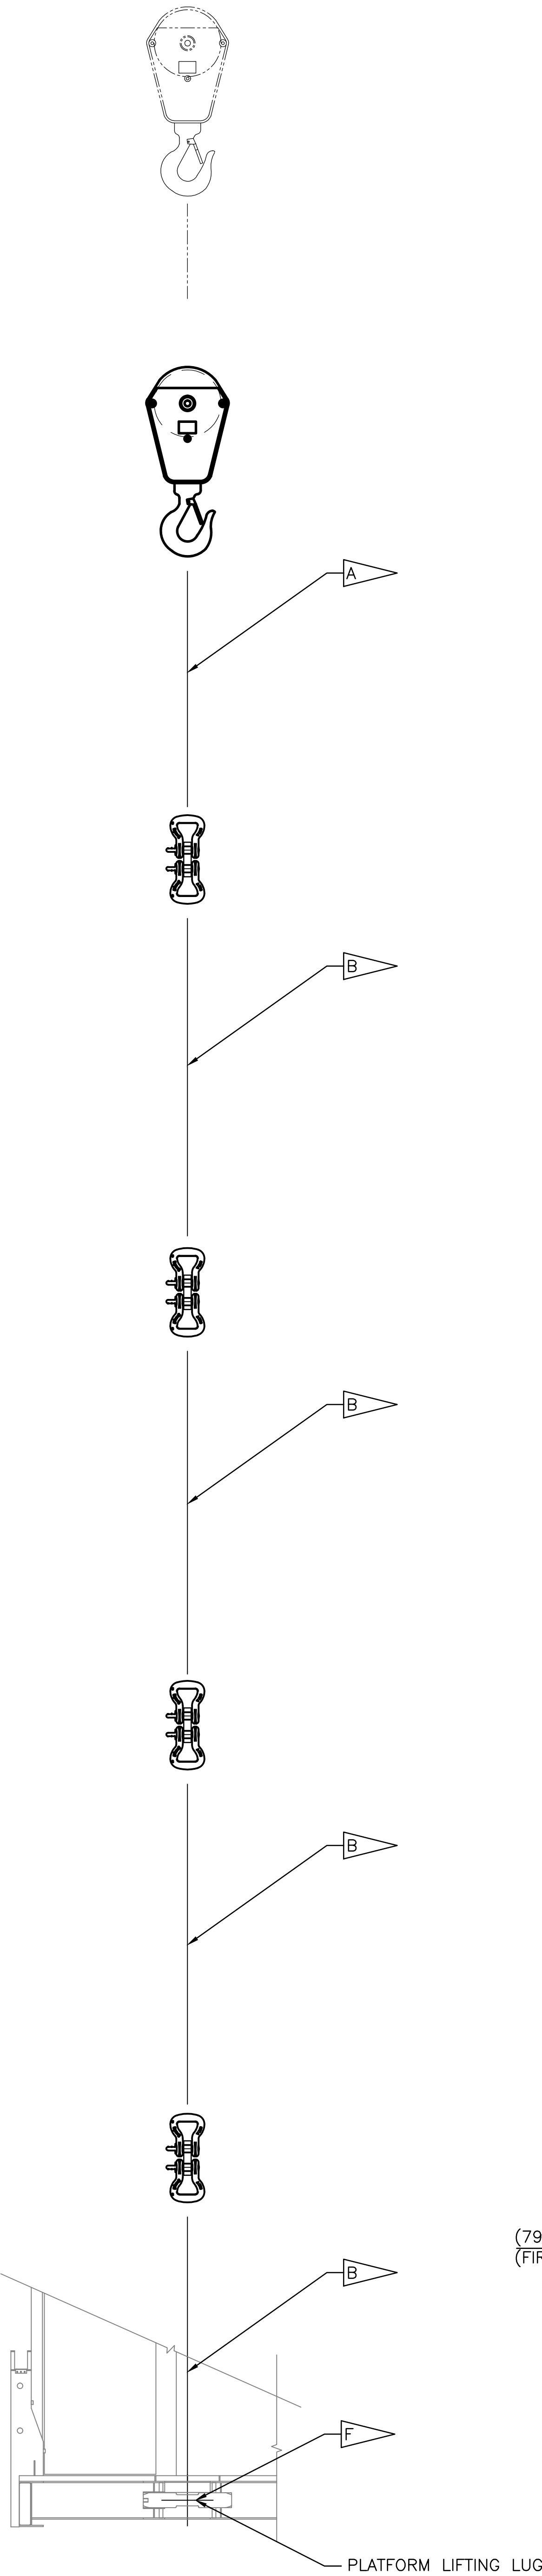


(79.000')
(FIRST HOLE)

1'-0" (TYP)

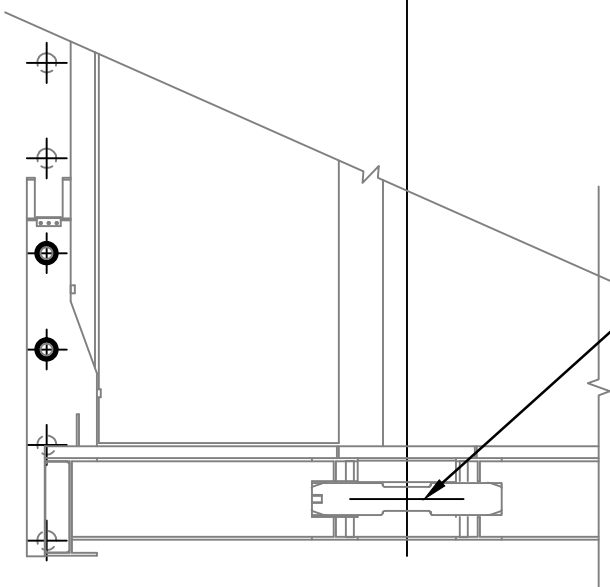

PLATFORM
LIFTING LUG

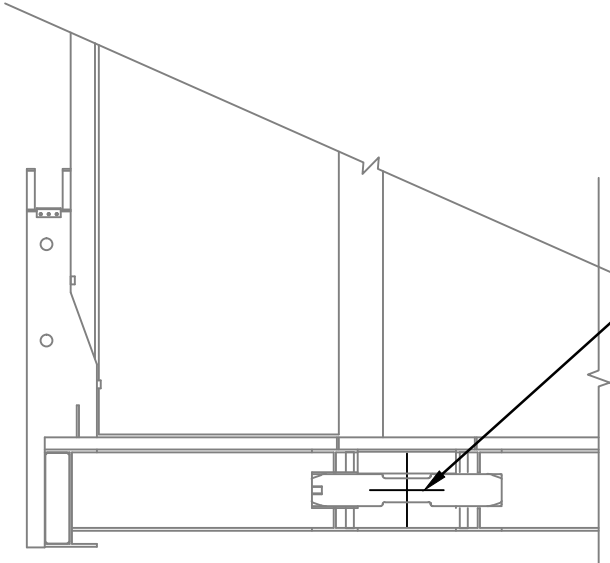

PLATFORM
LIFTING LUG

.295' BOTTOM OF SLING
0'

ELEVATOR PLATFORM SLING SCHEDULE
SCALE:NTS

441.875'

356.875'

330.850'

246.900'

163.770'


85.000'

81.470' (1% SLING STRETCH)


SPECIFIC NOTES:

- A. TPXCF2000-21. SLING 70000 LBS VRC W/K-SPEC(R) FIBER AND COVERMAX(TM) COVER, W/CHECK FAST (R) INSPECTION SYSTEM, SLINGMAX RIGGING SOLUTIONS (OAE).
- B. TPXCF2000-83. SLING 70000 LBS VRC W/K-SPEC(R) FIBER AND COVERMAX(TM) COVER, W/CHECK FAST (R) INSPECTION SYSTEM, SLINGMAX RIGGING SOLUTIONS (OAE).
- C. S-253 SCREW PIN SLING SHACKLE, P/N1020620 12 1/2 TON THE CROSBY GROUP (OAE).
- D. S-256 LINK PLATE, P/N1020840 12 1/2 TON THE CROSBY GROUP (OAE).
- E. DO NOT ENGAGE LOWER CORBEL PIN BELOW ELEVATION 79.000' TO ENSURE BOTH CORBEL PINS ARE ENGAGED PRIOR TO REMOVING SLINGS.
- F. HOIST TRAVEL IS 85.000'. DIMENSION SHOWN IS FROM ELEVATION 0' WITHOUT PLATFORM.
- G. HOIST TRAVEL IS 85.000'. DIMENSIONS SHOWN ARE FROM ELEVATION 0.000' WITH PLATFORM BEING LIFTED (INCLUDING SLING STRETCH OF 1%).
- H. IN ORDER TO ACCOUNT FOR THE 1% SLING STRETCH, AFTER HOOK IS RAISED 85.000' AND EXTENSIBLE PLATFORM CORBEL PINS ARE ENGAGED, REMOVE AND REPLACE THE LOWEST 83.000' SLING SEGMENT WITH A 5' SLING (P/N TPXCF2000-5). LOWER HOOK AND ATTACH THE 5' SLING TO PLATFORM LIFTING LUG, RAISE EXTENSIBLE PLATFORM TO MAXIMUM AVAILABLE TRACK HOLE LOCATION. AFTER CORBEL PINS ARE ENGAGED REMOVE 5' SLING AND ATTACH REMAINING SLING ASSEMBLY TO THE PLATFORM LIFTING LUG.
- J. PRIOR TO TURNING OVER SLINGS TO NASA THEY MUST BE INSPECTED BY NASA QUALITY TO ENSURE SLINGS HAVE NOT BEEN DAMAGED AND ARE STILL IN USABLE CONDITION.
- K. SLINGS SHALL BE STORED IN A REUSABLE CRATE WITH NO MORE THAN 4 SLINGS PER CRATE.

SLING / HARDWARE REQD PER HOIST	
QTY	TYPE
4X	TPXCF2000-83 (83')
1X	TPXCF2000-21 (21')
1X	TPXCF2000-5 (5')
8X	S-253 SCREW PIN SLING SHACKLE P/N 1020620 (12½ TON)
4X	S-256 LINK-PLATE P/N 1020840 (12½ TON)

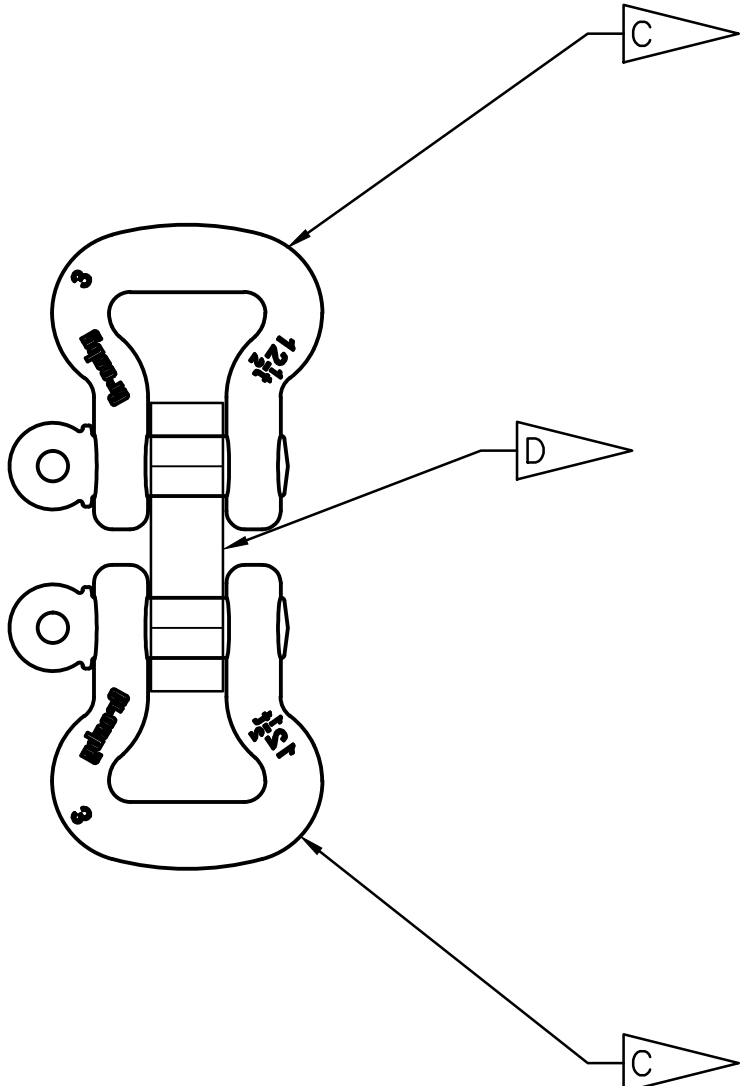

SLING SHACKLE ASSEMBLY (1)
SCALE: 3"=1'-0"


SYM	ZONE	DESCRIPTION		DATE	APPROVAL			
REVISIONS								
SIGNATURES		DATE	<div><div>Reynolds, Smith and Hills, Inc. 115 Alma Blvd, Suite 101 Merritt Island, Florida 32953-4101 (321) 453-0212 (321) 453-0223 FAX www.rsandh.com</div></div>					
DRAWN: JOSEPH HAUER		08-20-2013	NATIONAL AERONAUTICS AND SPACE ADMINISTRATION JOHN F. KENNEDY SPACE CENTER, NASA KENNEDY SPACE CENTER, FLORIDA					
CHECKED: JIM STAPP		08-20-2013	LAUNCH COMPLEX 39 VEHICLE ASSEMBLY BUILDING MODIFY VEHICLE ASSEMBLY BUILDING HIGH BAY 3 FOR SLS - HOISTS ELEVATOR PLATFORMS HOISTS SLING SCHEDULE					
SUBMITTED ARCHIVING OF RECORD								
ROBERT PRUSS								
ST. OF LICENSURE: FL								
LICENSE NO:								
APPROVED:								
JOHN KERESMAR								
MIKE HARTNETT		FILE NO.	302-6058-043	SIZE	E	DWG. NO.	79K39667	REV
		PROJ. NO.	PCN	99000.5	SHEET	31	OF	

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THIS COMPUTER DRAWING WAS
CREATED IN AUTOCAD AND
FILED UNDER THE DRAWING NUMBER


M-816

79K39667

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GRADE 8 ALLOY STEEL HEX HEAD CAP SCREW ZINC YELLOW PLTD
1/2"-20 THRD, 2" L, FULLY THRD ZINC-PLATED STEEL TYPE
A SAE FLAT WASHER 1/2" SCREW SIZE, 1-1/16" OD, .07"- .13"
THICK (2 REQD) ZINC-PLTD GRADE 5 STL NYLON-INSERT HEX
LOCKNUT 1/2"-20 THREAD SIZE (4 PLACES)

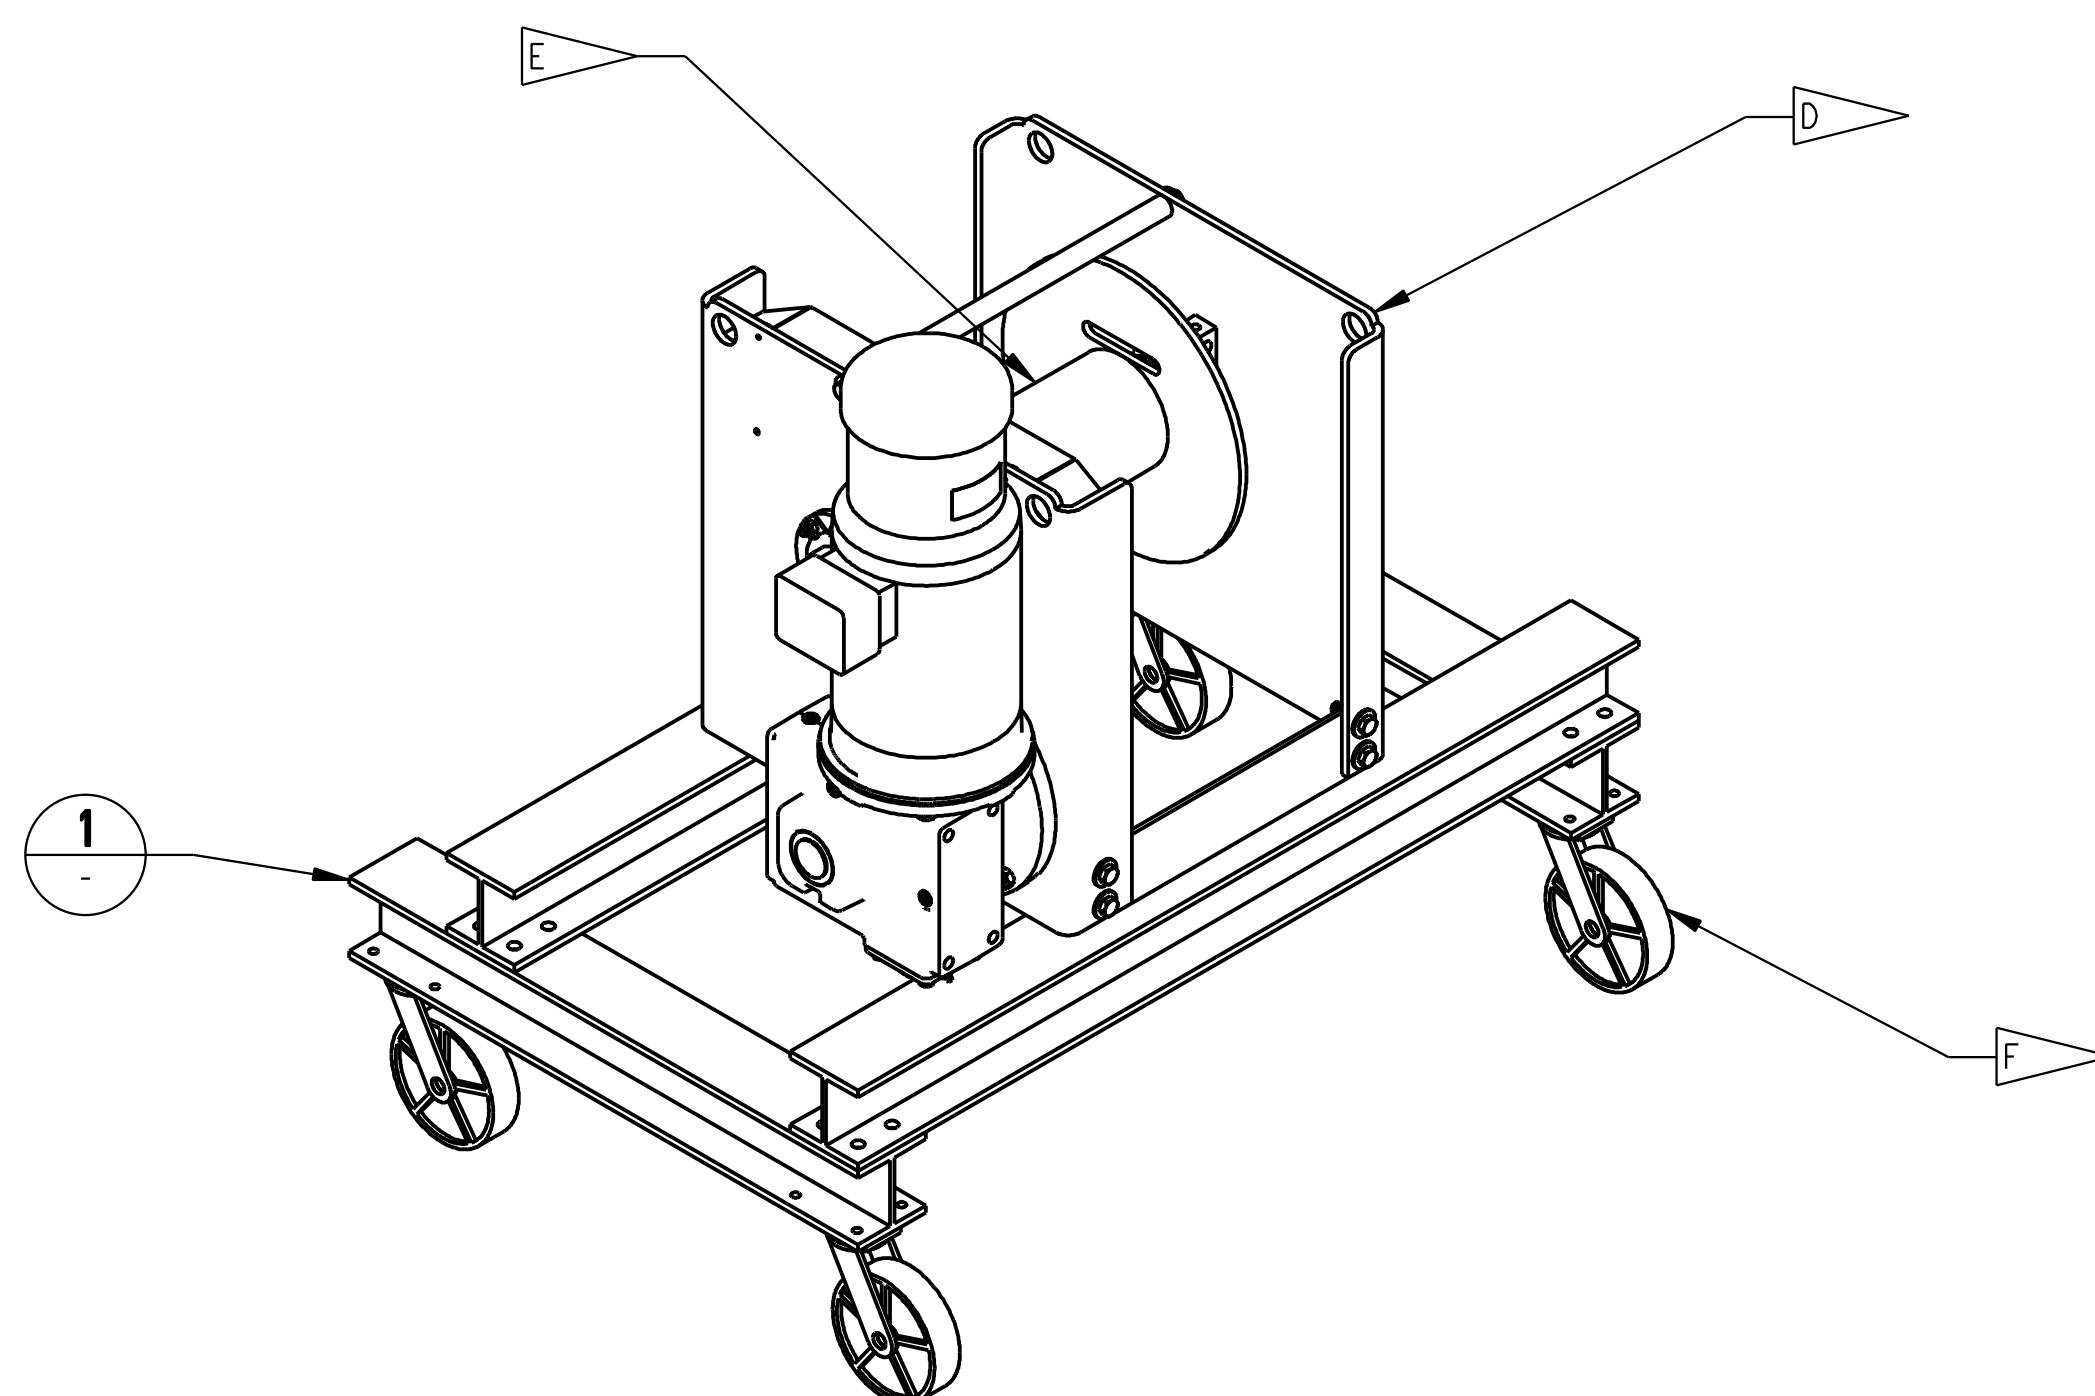


SPECIFIC NOTES

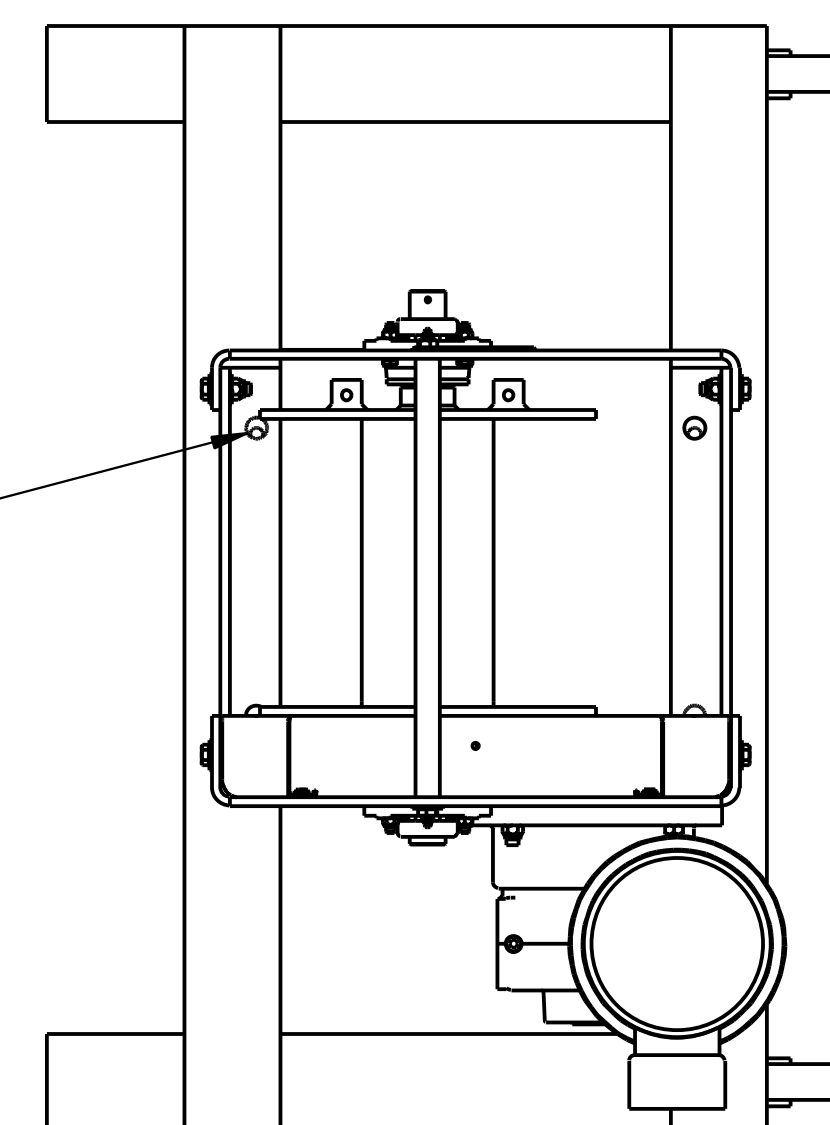
- A. TOLERANCES:
X .X +/- 0.1
X.XX +/- 0.01
X.XXX +/- .005
ANGLE +/- 0.5
- B. CLEAN COMPONENT PARTS PER MIL-S-5002 BEFORE WELDING.
- C. WELD PER NASA-SPEC-5004. WELDERS AND WELDING OPERATORS SHALL BE QUALIFIED IN ACCORDANCE WITH AWS D1. ALL WELDS REQUIRE A CLASS B INSPECTION UNLESS NOTED AS CLASS A IN THE WELD SYMBOL OR IN THE WELDMENT NOTATION.
- D. MODIFIED WORM/SPUR GEAR POWER WINCH WITH A 3 HP, 460-3-60 INPUT VOLTAGE BRAKE MOTOR AND WORM GEAR REDUCER. THE TOTAL REDUCTION RATIO WITH SPUR GEAR IS 114.25 TO 1. ALL COMPONENTS MOUNTED ON TO A HEAVY DUTY FRAME WITH MOUNTING HOLES. WINCH IS MODIFIED WITH THE FOLLOWING: GEARBOX ROTATED SO THE MOTOR IS UP.
THE BOLT HOLES WILL BE SIZED TO ACCOMMODATE 1/2" DIAMETER BOLTS AND THERE WILL BE 2 ADDITIONAL HOLES PER SIDE OF WINCH ADDITIONAL HOLES IN FRAME TO MOUNT BRACKET ON OUTBOARD BEARING SIDE OF WINCH. THERN PRODUCTS (100-5-S (C)) MODIFIED SINGLE SPEED ELECTRIC MOTOR CONTROL RATED UP TO 7.5 HP AND 460-3-60 LINE VOLTAGE. ELECTRIC MOTOR CONTROL WILL INCLUDE A MAGNETIC REVERSING STARTER, THERMAL OVERLOAD RELAY AND A FUSED CONTROL CIRCUIT IN A NEMA 4 ENCLOSURE. THE ELECTRIC MOTOR CONTROLS WILL ALSO INCLUDE A 50-FOOT PENDANT. THE PENDANT WILL INCLUDE TWO (2) MOMENTARY CONTACT PUSHBUTTONS IN A NEMA 4X ENCLOSURE. PUSHBUTTONS WILL BE LABELED EITHER UP/DOWN OR "FWD/REV", DEPENDING ON THE APPLICATION. MODIFIED BRACKET TO MOUNT CONTROL ON OUTBOARD BEARING SIDE OF WINCH. ELECTRIC MOTOR CONTROLS ARE MOUNTED TO BE WIRED BY THE MANUFACTURER TO THE 4HP, 477 AND 3WG SERIES WINCHES. PLEASE CONTACT THERN FOR MOUNTING OPTIONS ON THESE MODELS.
- E. 450 FT OF 3/8" DIAMETER INWRC EIPS (EXTRA IMPROVED PLOW STEEL). ONE END PLAIN AND THE OTHER END WITH AN EYE HOOK AND SAFETY LATCH. SENT LOOSE TO BE INSTALLED BY OTHERS.
- F. SERVICE CAST MEDIUM TO HEAVY DUTY CASTER #30 SERIES PRODUCT# SCC-30C520-EZPUR-TLB-BSL WITH SIDE LOCK BRAKES AND FACE CONTACT BRAKES OR APPROVED EQUAL (4 PLACES)
- G. A TOTAL OF 4 CARTS ARE NEEDED, ONE FOR EACH SERVICE PLATFORM.

HOIST CART ASSEMBLY ISO

SCALE: 1/2" = 1'-0"

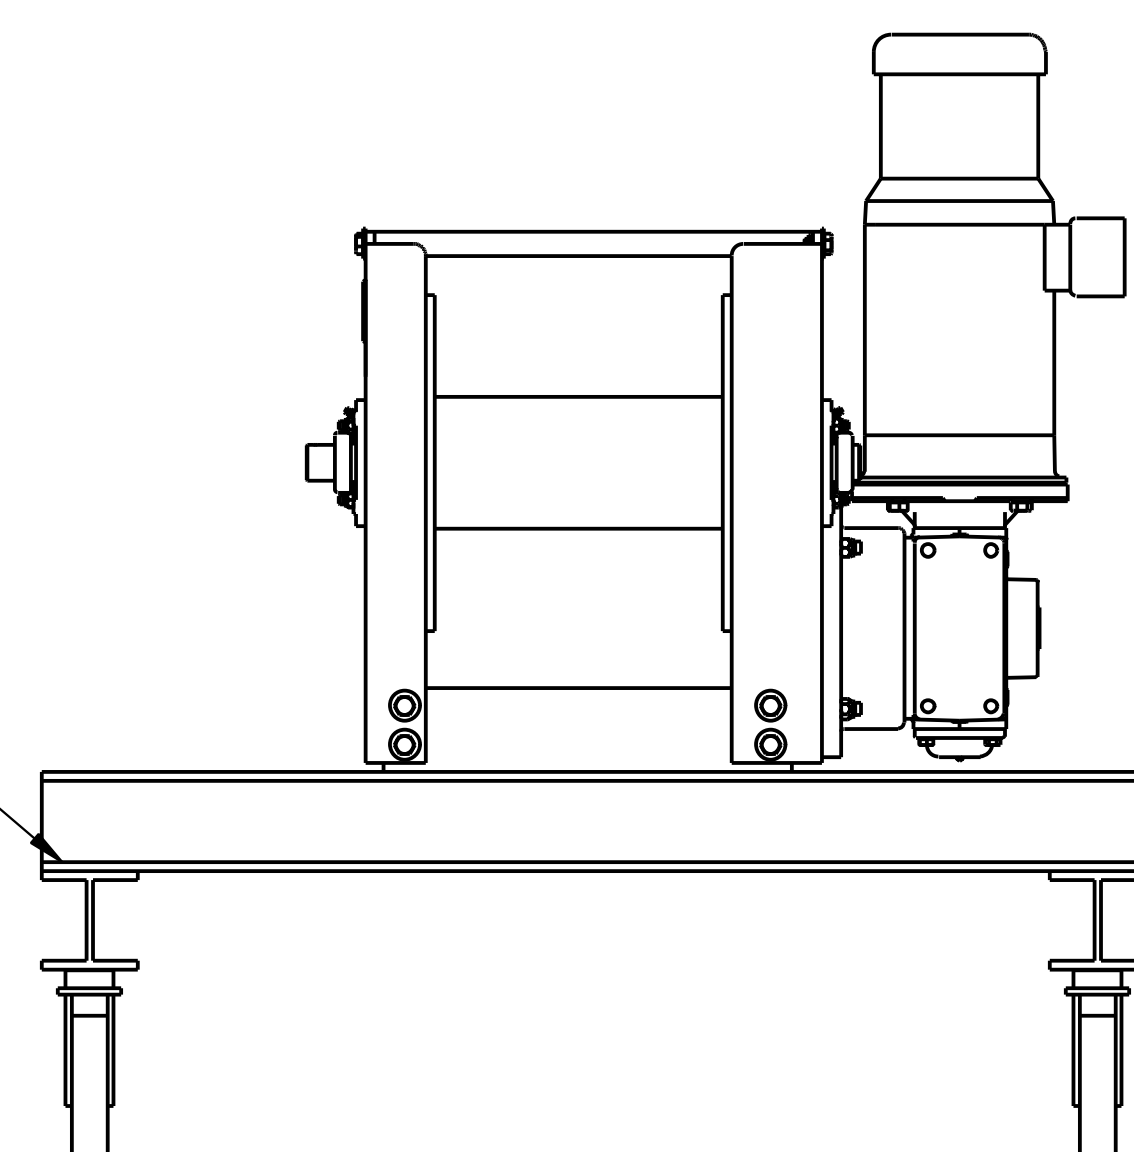


1/2"Ø X 1-1/2"; HDG A325 HEXBOLT WITH
NUT & WASHERS (16 PLACES)

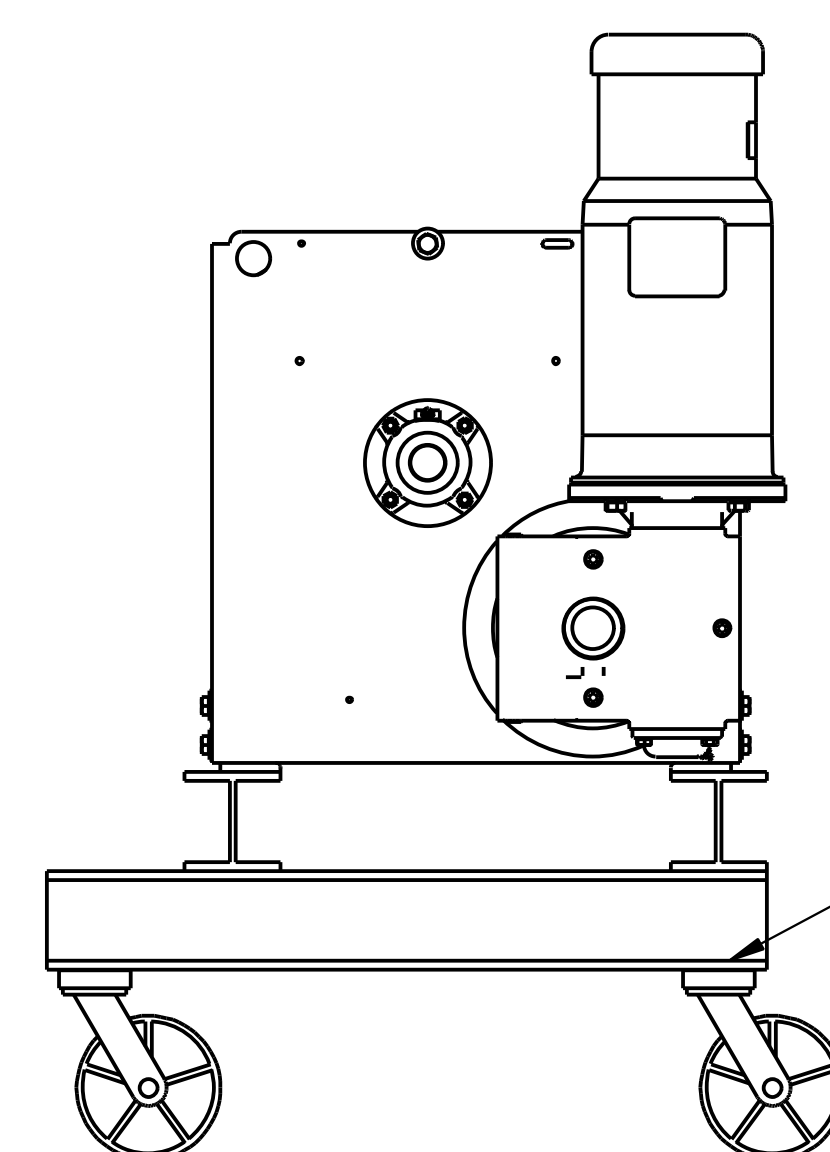

—GRADE 8 ALLOY STEEL HEX HEAD CAP SCREW ZINC
YELLOW PLTD, 3/8"-16 THRD, 1-3/4" L, FULLY THRD,
18-8 SS TYPE A USS FLAT WASHER 3/8" SCREW
SIZE, 1" OD, .06"- .11" THICK (2 REQD), GRADE 8 STEEL
NYLON-INSERT HEX LOCK NUT ZINC YELLOW PLTD,
3/8"-16 THRD SZ. 9/16" W. 29/64" H (16 PLACES)


HOIST CART ASSEMBLY

SCALE: 1 1/2" = 1' - 0"

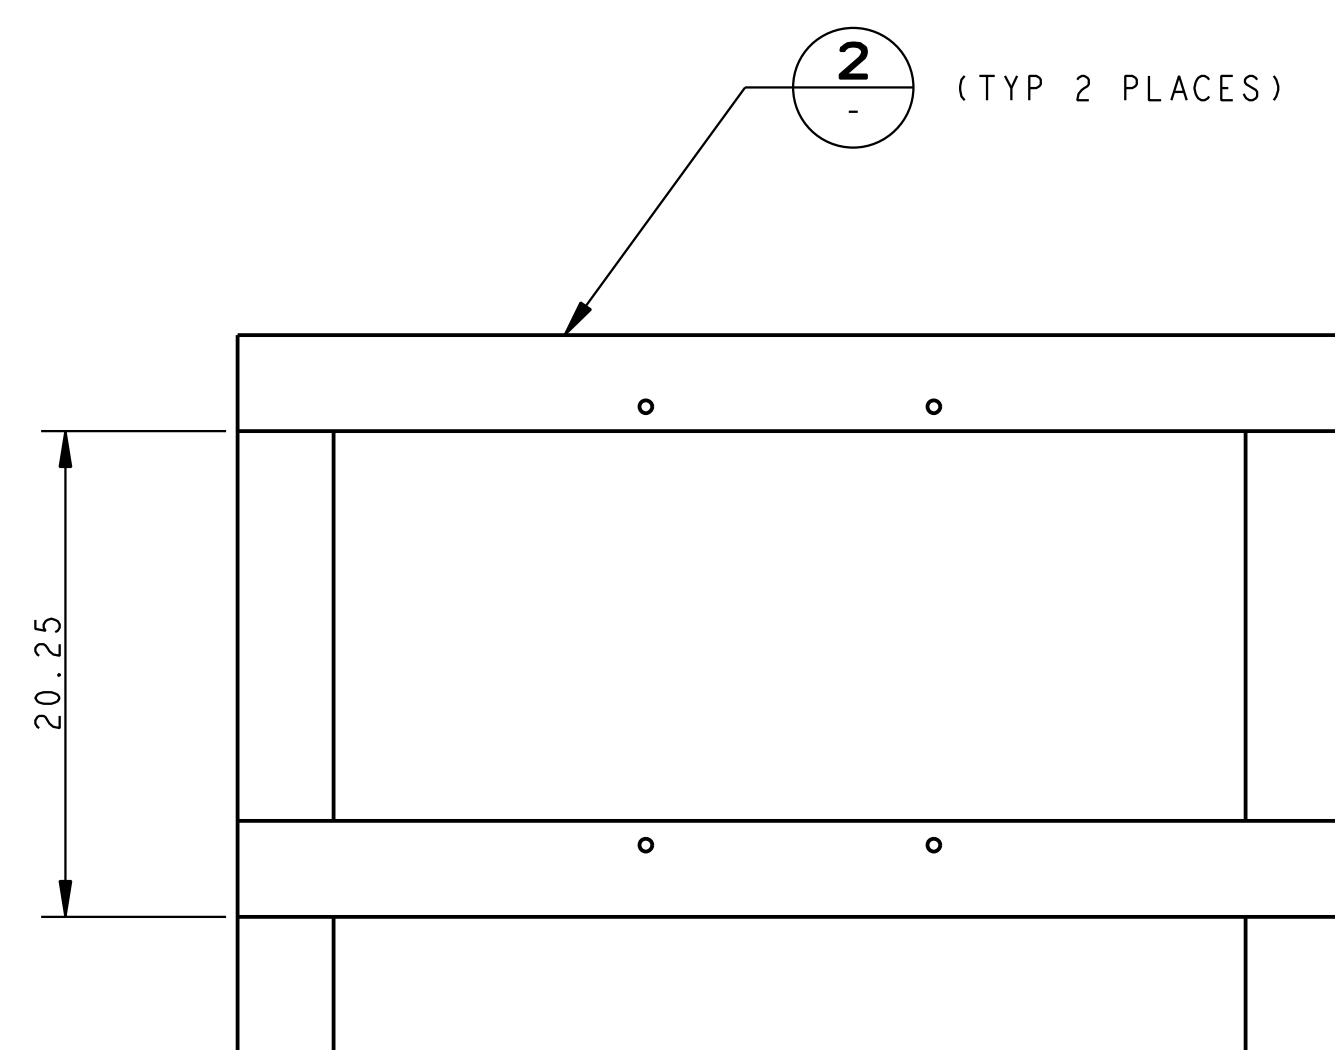


2 (TYP 2 PLACES)

3 (TYP 2 PLACES)

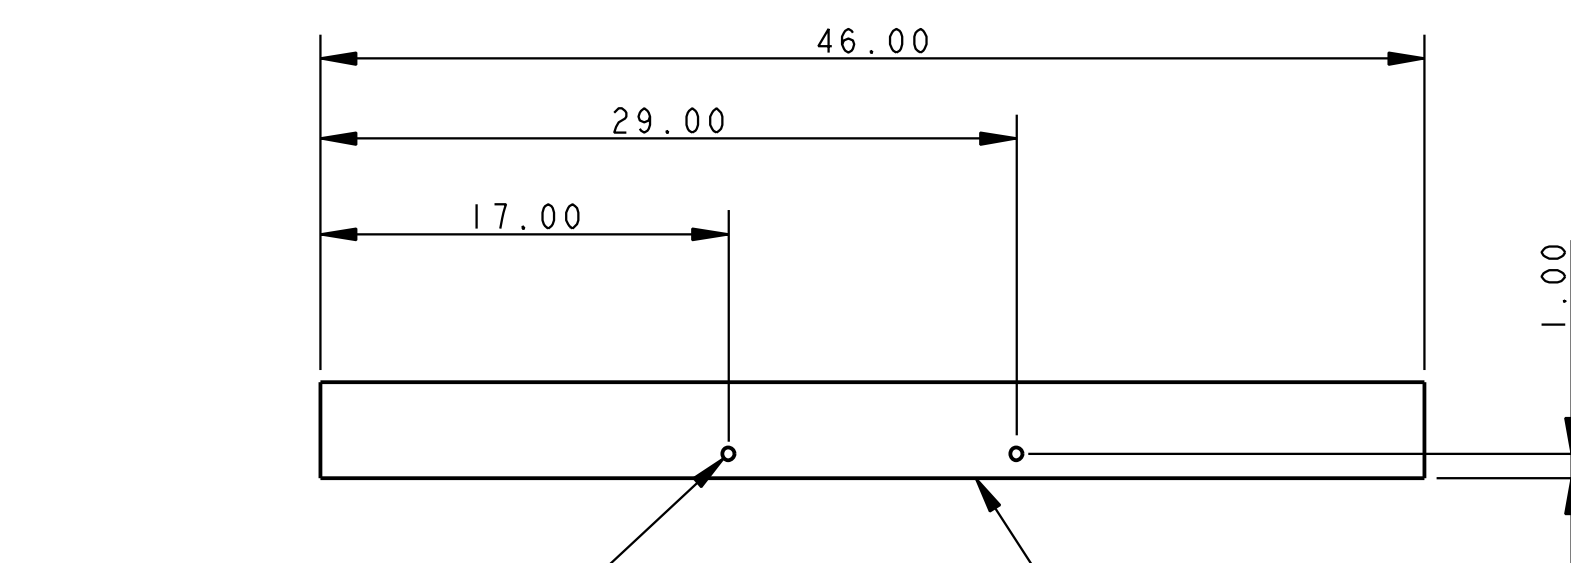


Ø.531 (TYP 2 PLACES)

—W4X13

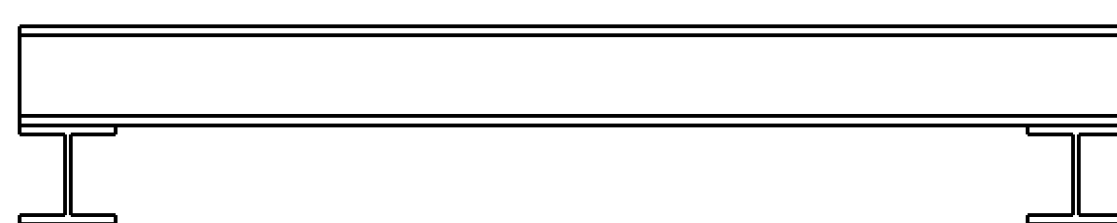

FRAME ASSEMBLY



SCALE: 1/2" = 1'-0"

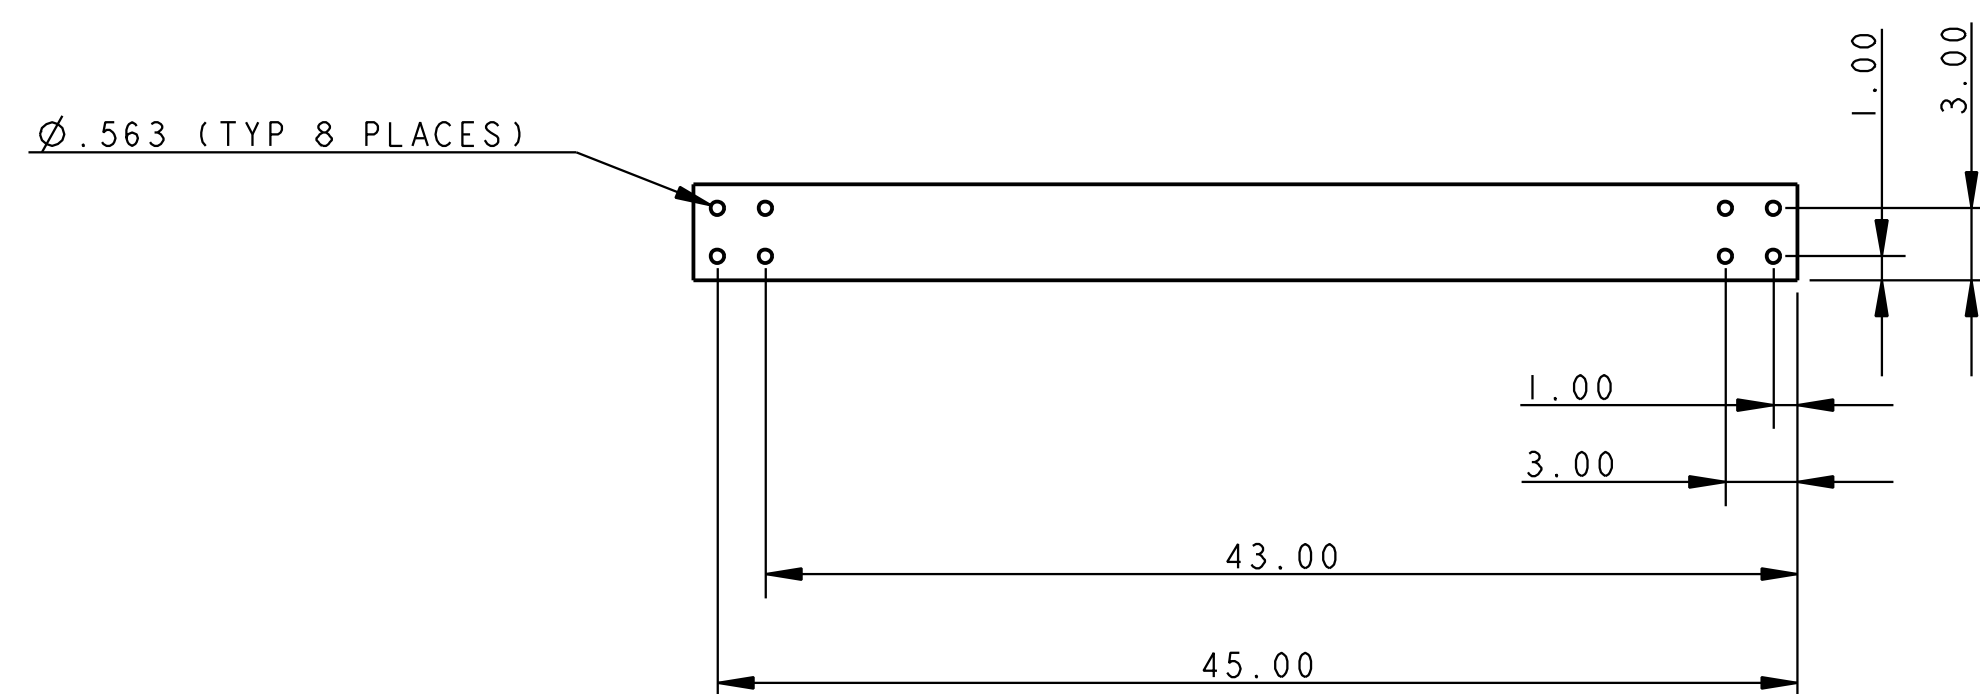


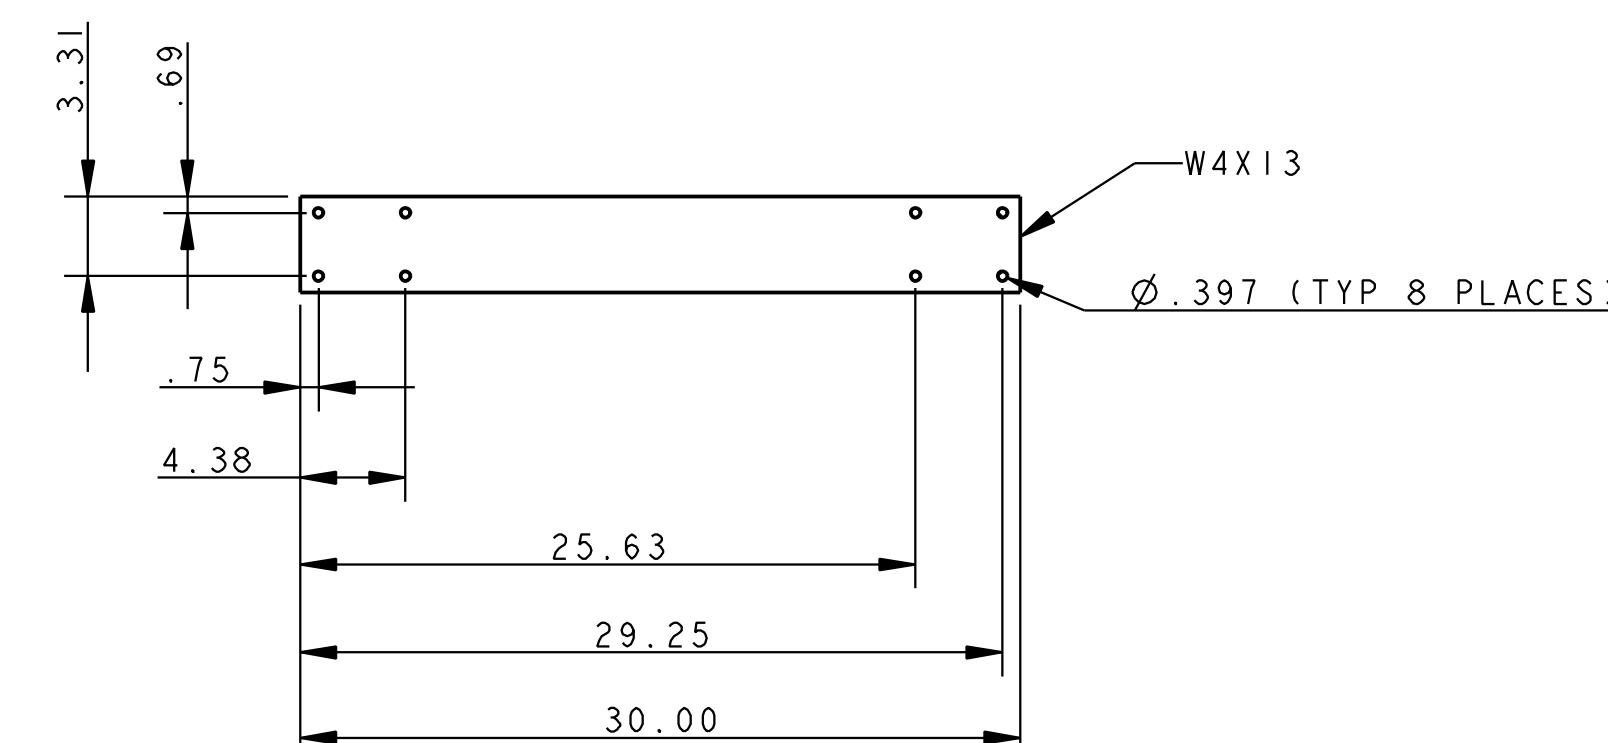
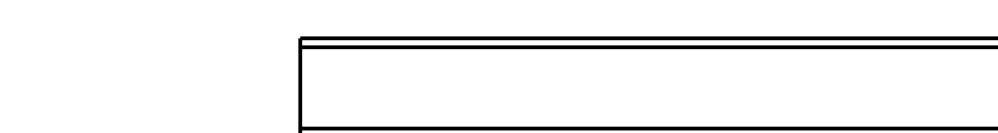
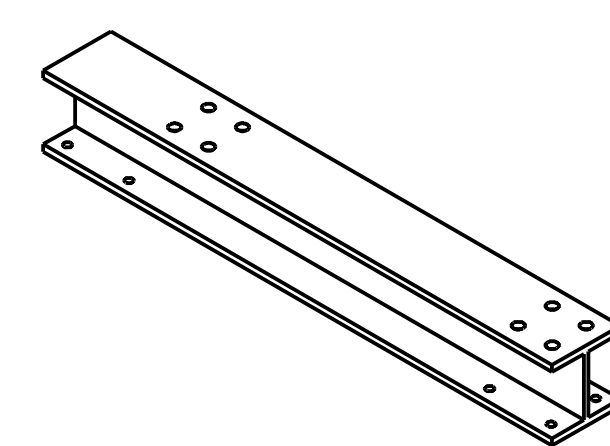
Ø.563 (TYP 8 PLACES)

CROSS BEAM

SCALE: 1 1/2" = 1' - 0"

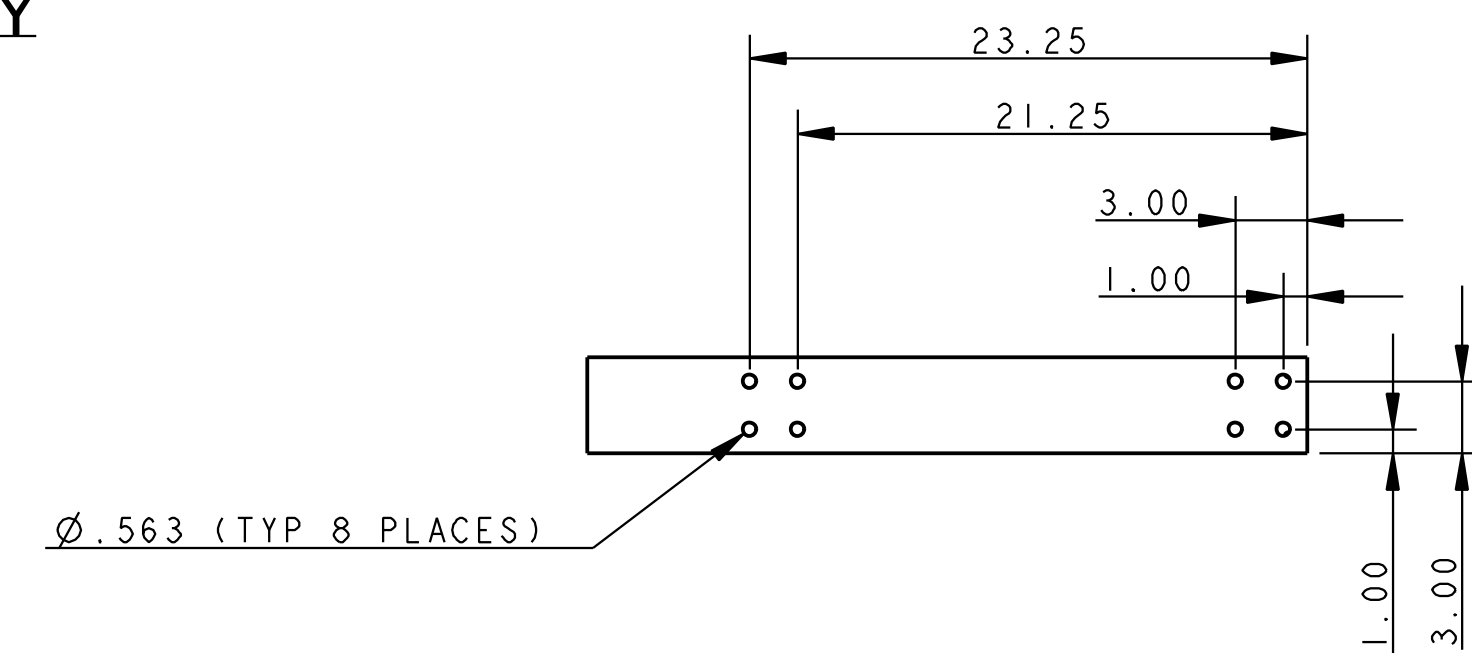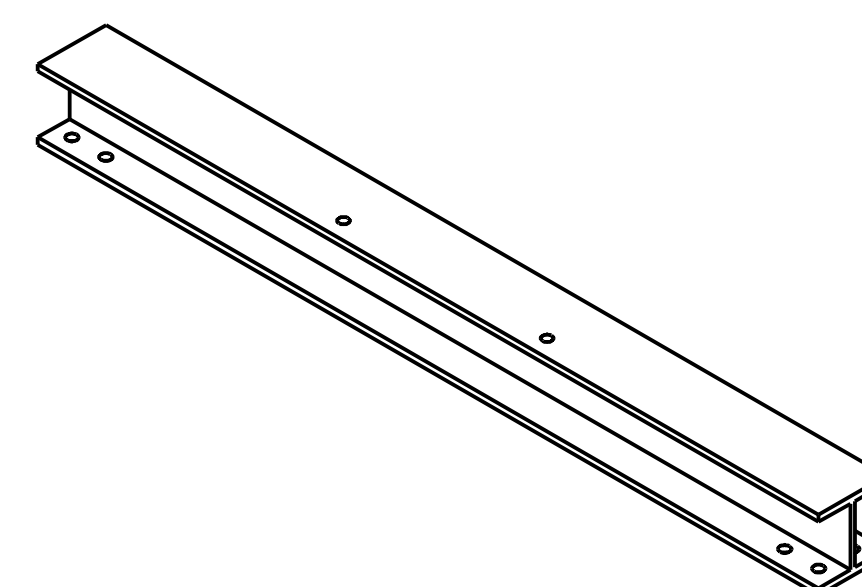


Ø.563 (TYP 8 PLACES)




Ø.397 (TYP 8 PLACES

BASE_BEAM

SCALE: 1 1/2" = 1' - 0'

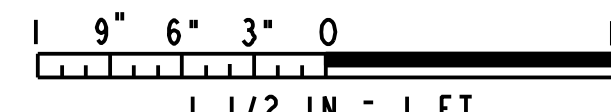

SYM	ZONE	DESCRIPTION	DATE	APPROVAL
REVISONS				
			Reynolds, Smith and Hills, Inc. 115 Alma Blvd, Suite 101 Merritt Island, Florida 32953-4101 (321) 453-0212 (321) 453-0212 FAX www.rsandh.com	
SIGNATURES		DATE	NATIONAL AERONAUTICS AND SPACE ADMINISTRATION JOHN F. KENNEDY SPACE CENTER, NASA KENNEDY SPACE CENTER, FLORIDA LAUNCH COMPLEX 39 VEHICLE ASSEMBLY BUILDING MODIFY VEHICLE ASSEMBLY BUILDING HIGH BAY 3 FOR SLS - HOISTS ELEVATOR PLATFORMS HOIST HOIST CART	
DRAWN: SAM MCMULLEN		08/20/2013	FILE NO. 302-6058-043 SIZE DWG. NO. 79K39667 PROJ. NO. PCN 99000.5 SHEET 32 OF	
CHECKED: JOE D'AMICO		08/20/2013		
SUBMITTED: ARCH/ENG OF RECORD				
ROBERT PRUSS				
ST OF LICENSURE: FL				
LICENSE NO:				
APPROVED:				
STEVE MOORE				
MIKE HARTNETT				

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CREATED IN PRO/ENGINEER AND
FILED UNDER THE DRAWING NUMBER


M-817

FILE NO.	SIZE	DWG. NO.
302-6058-043	E	79K39667

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TOWER F - HOIST (1)
SCALE: NTS



TOWER F - HOIST (2)
SCALE: NTS

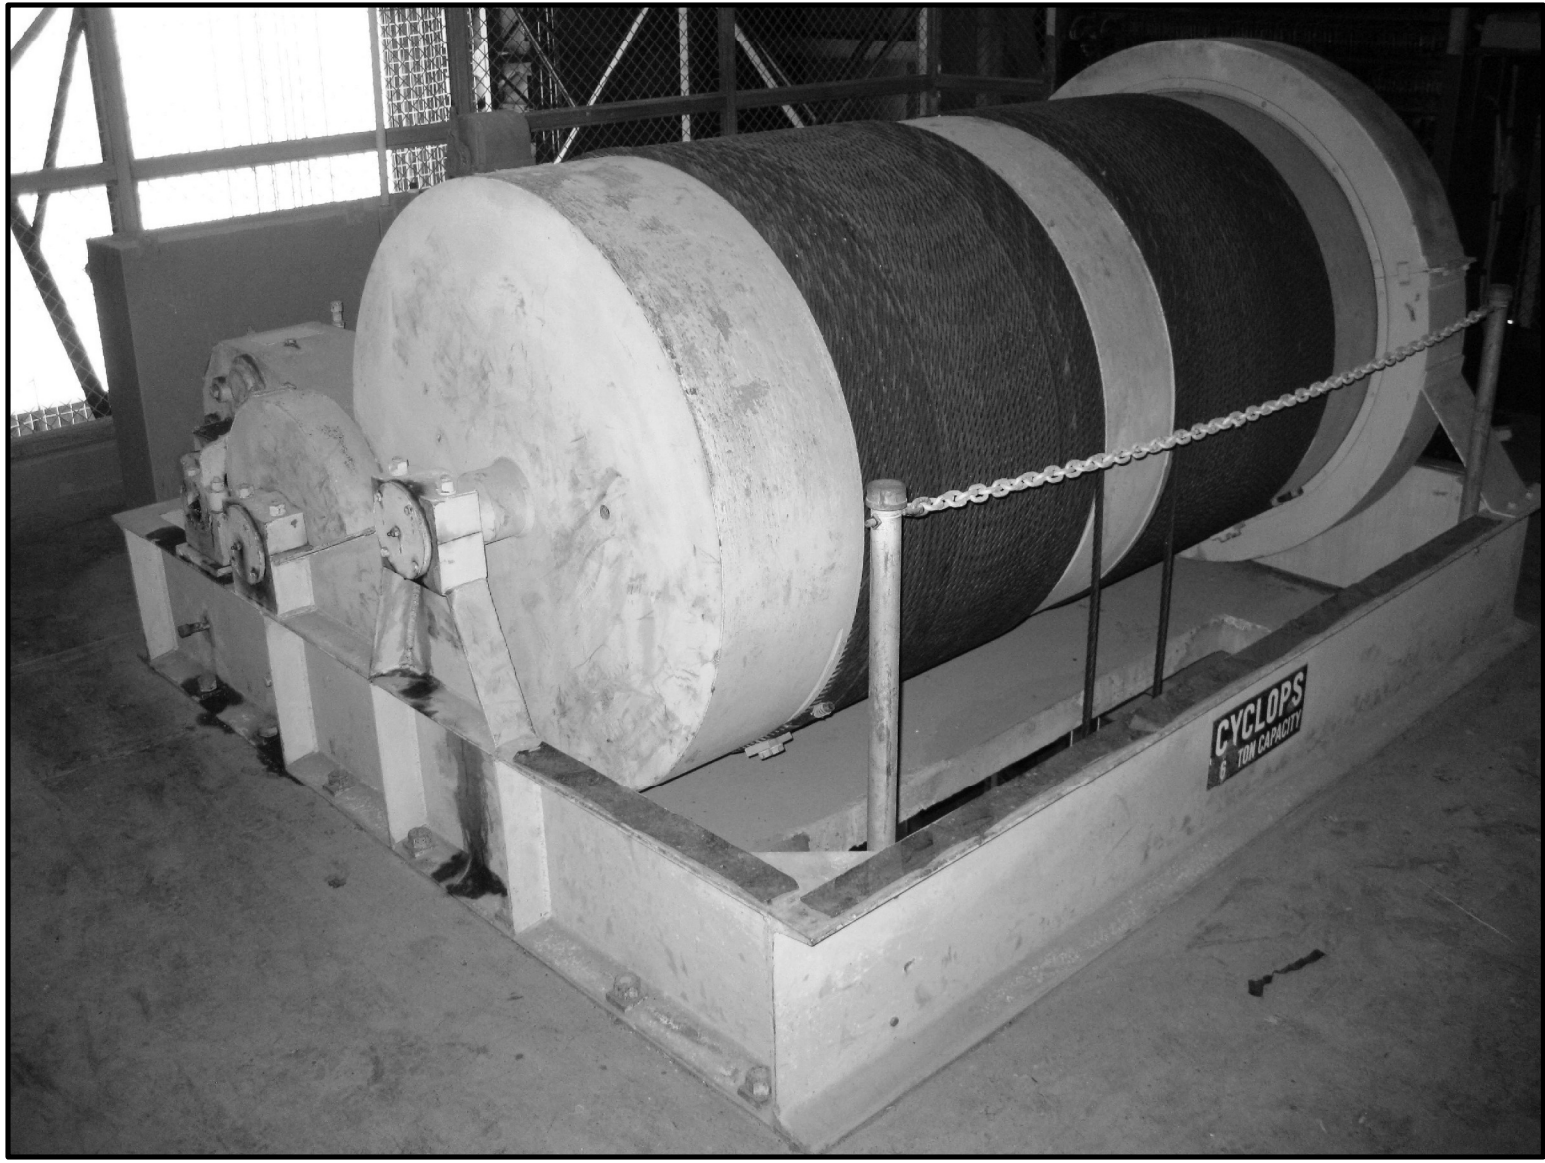


TOWER F - HOIST CNTR (3)
SCALE: NTS




TOWER F - DISPATCHER (4)
SCALE: NTS




TOWER F - CONTROLLER (5)
SCALE: NTS

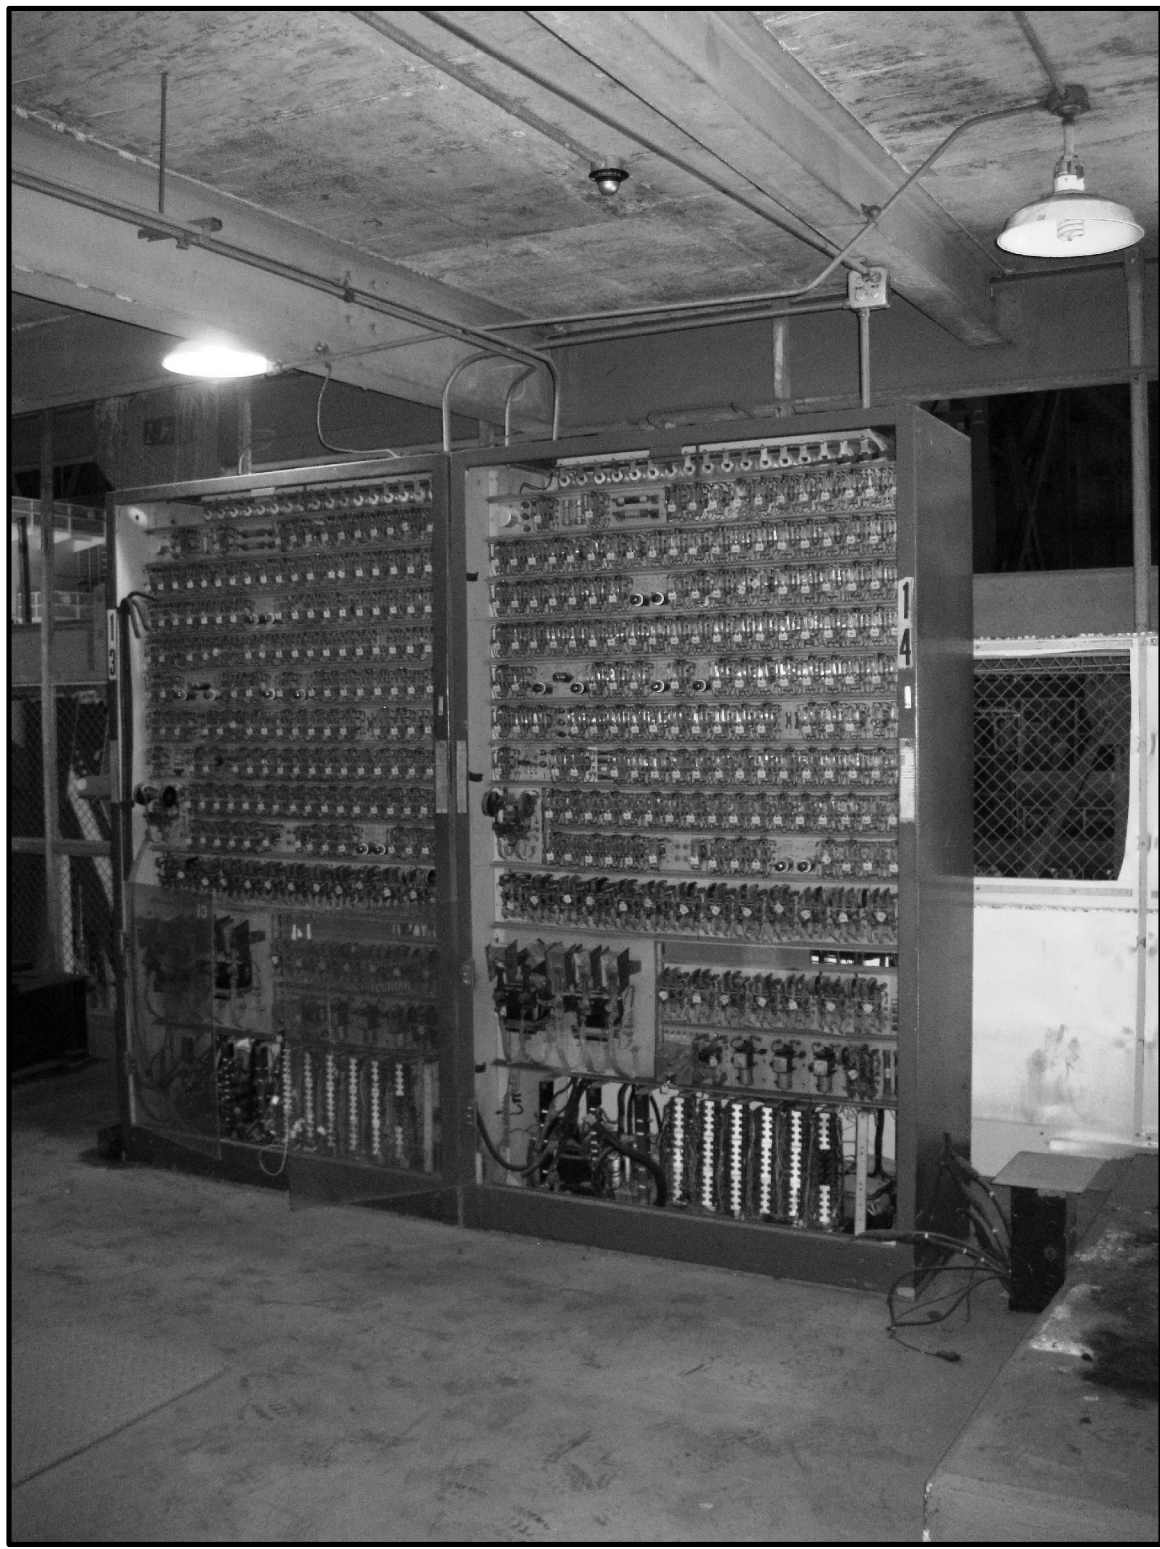


TOWER E - CONTROL (6)
SCALE: NTS

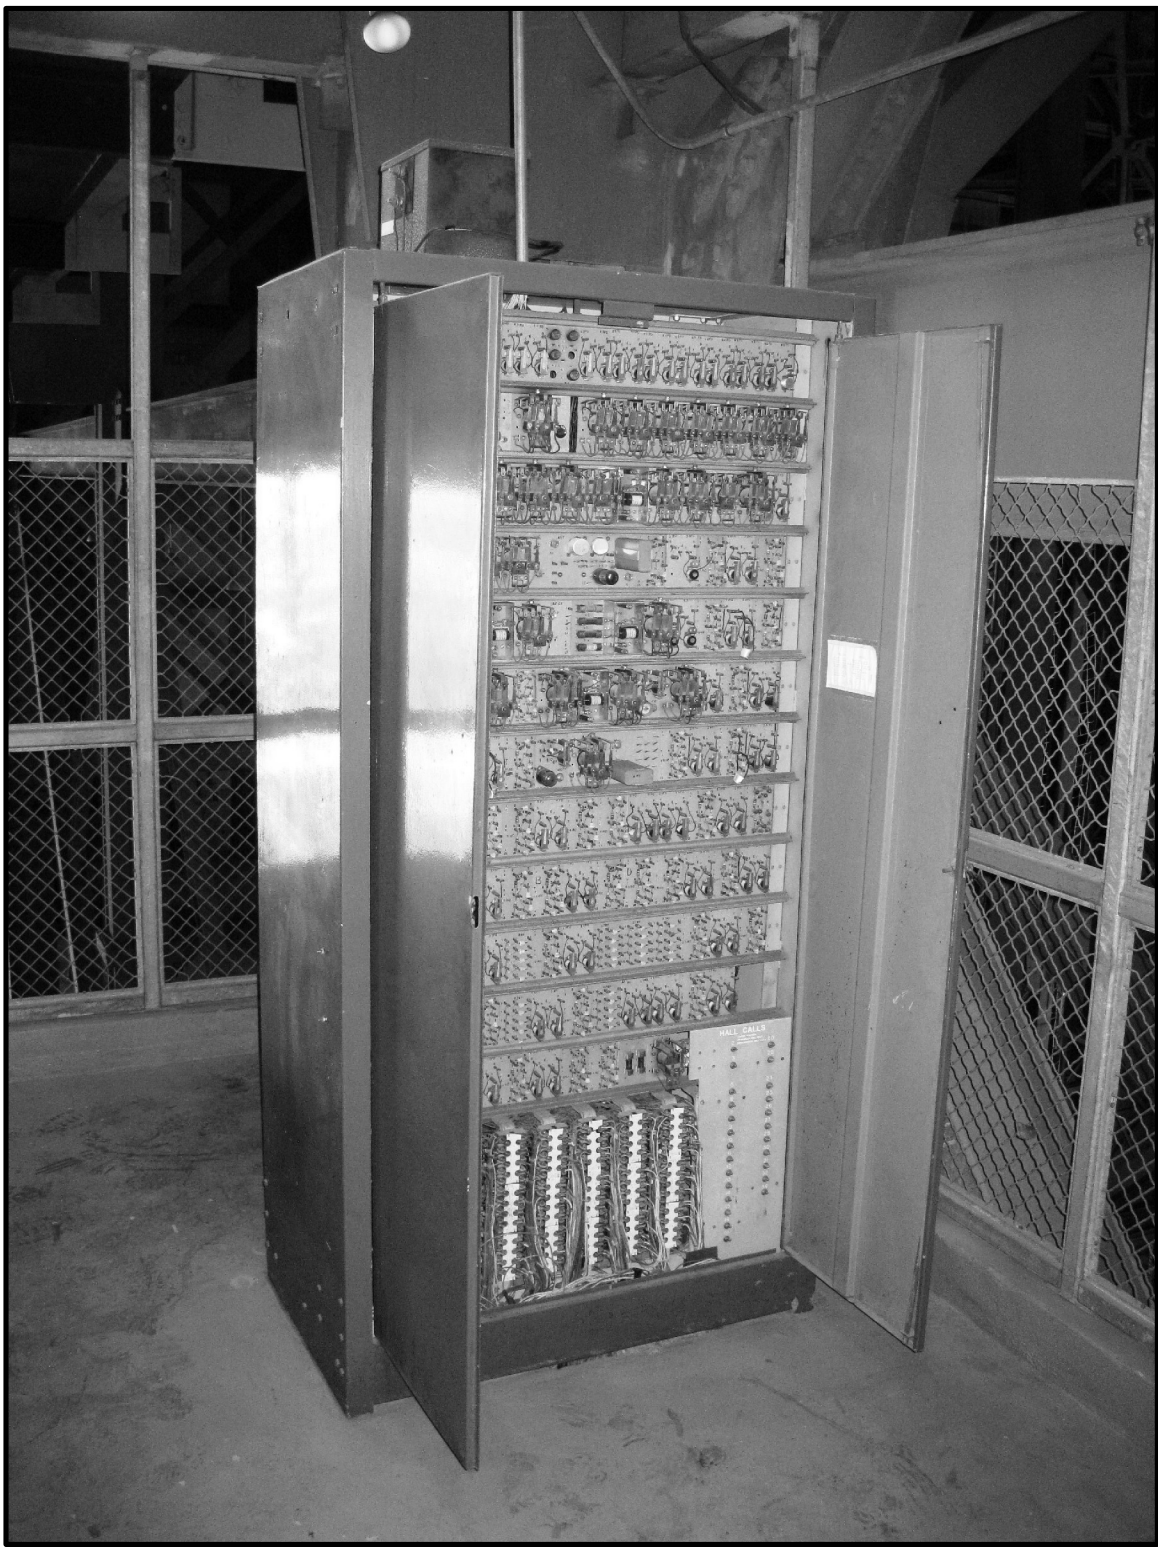

TOWER E - DISPATCHER (7)
SCALE: NTS

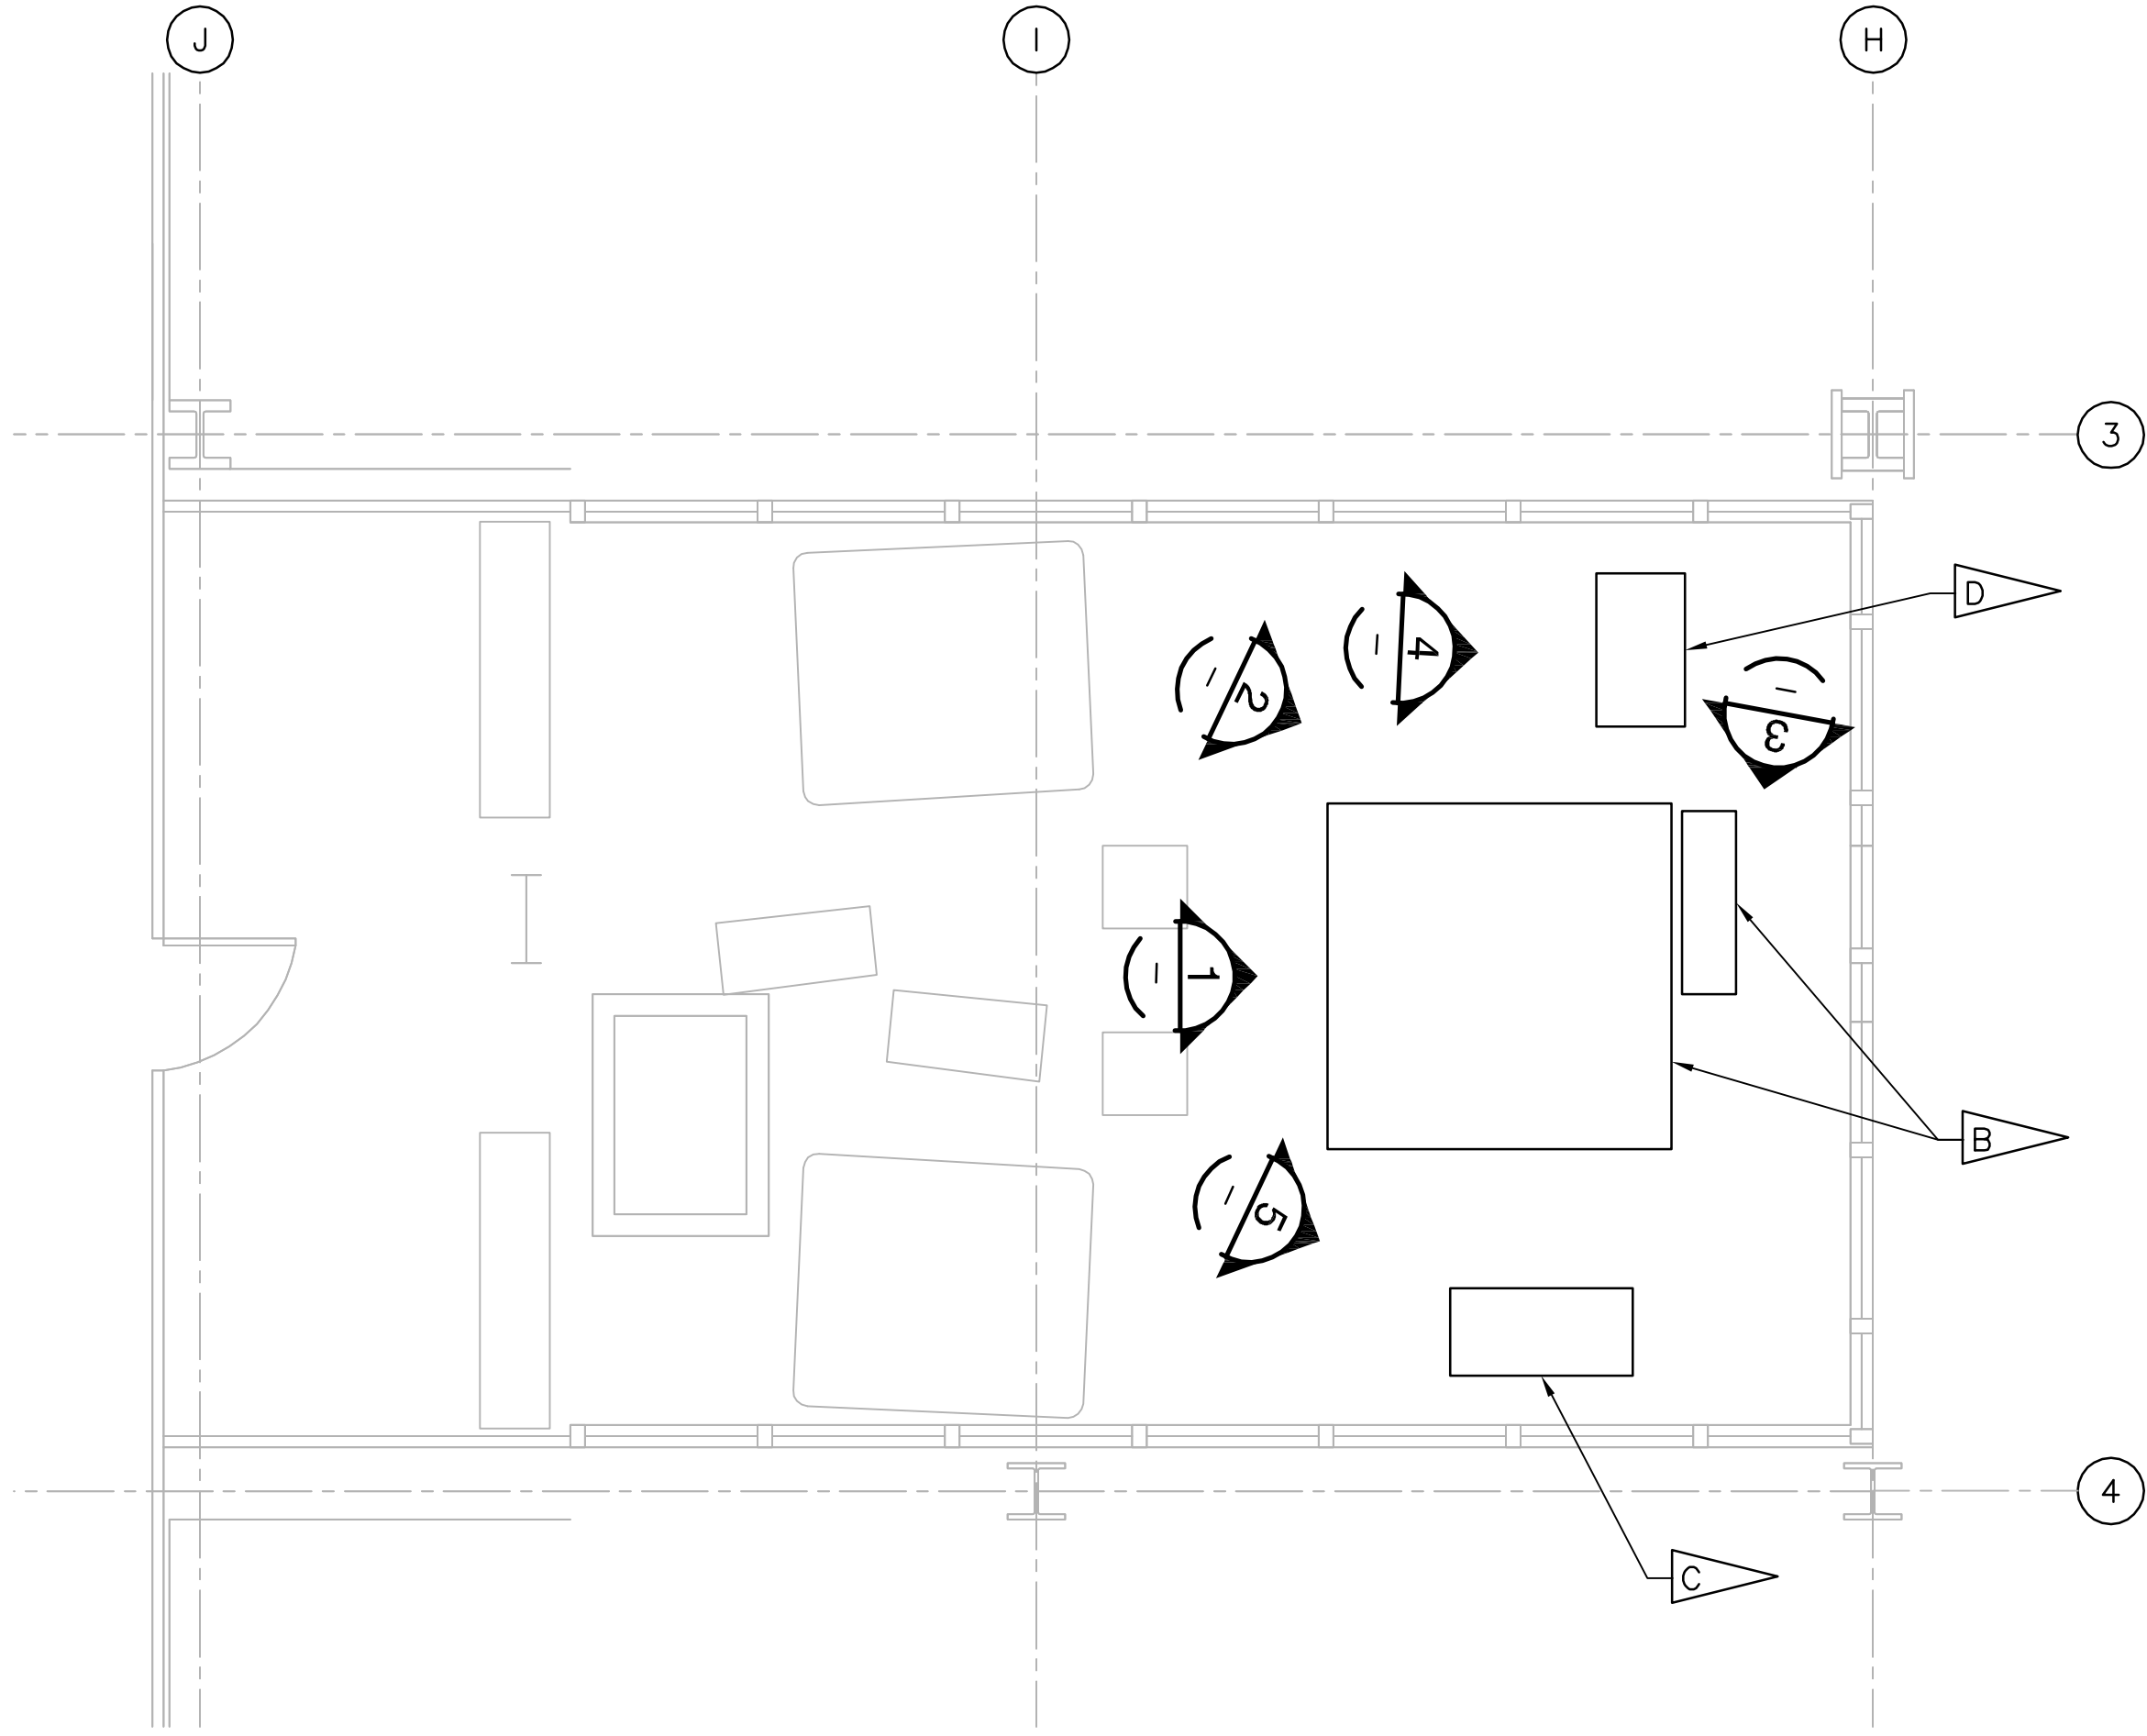


LEVEL 36 - ELECTRICAL DEMOLITION - TOWER F
SCALE: 1/4" = 1'-0"

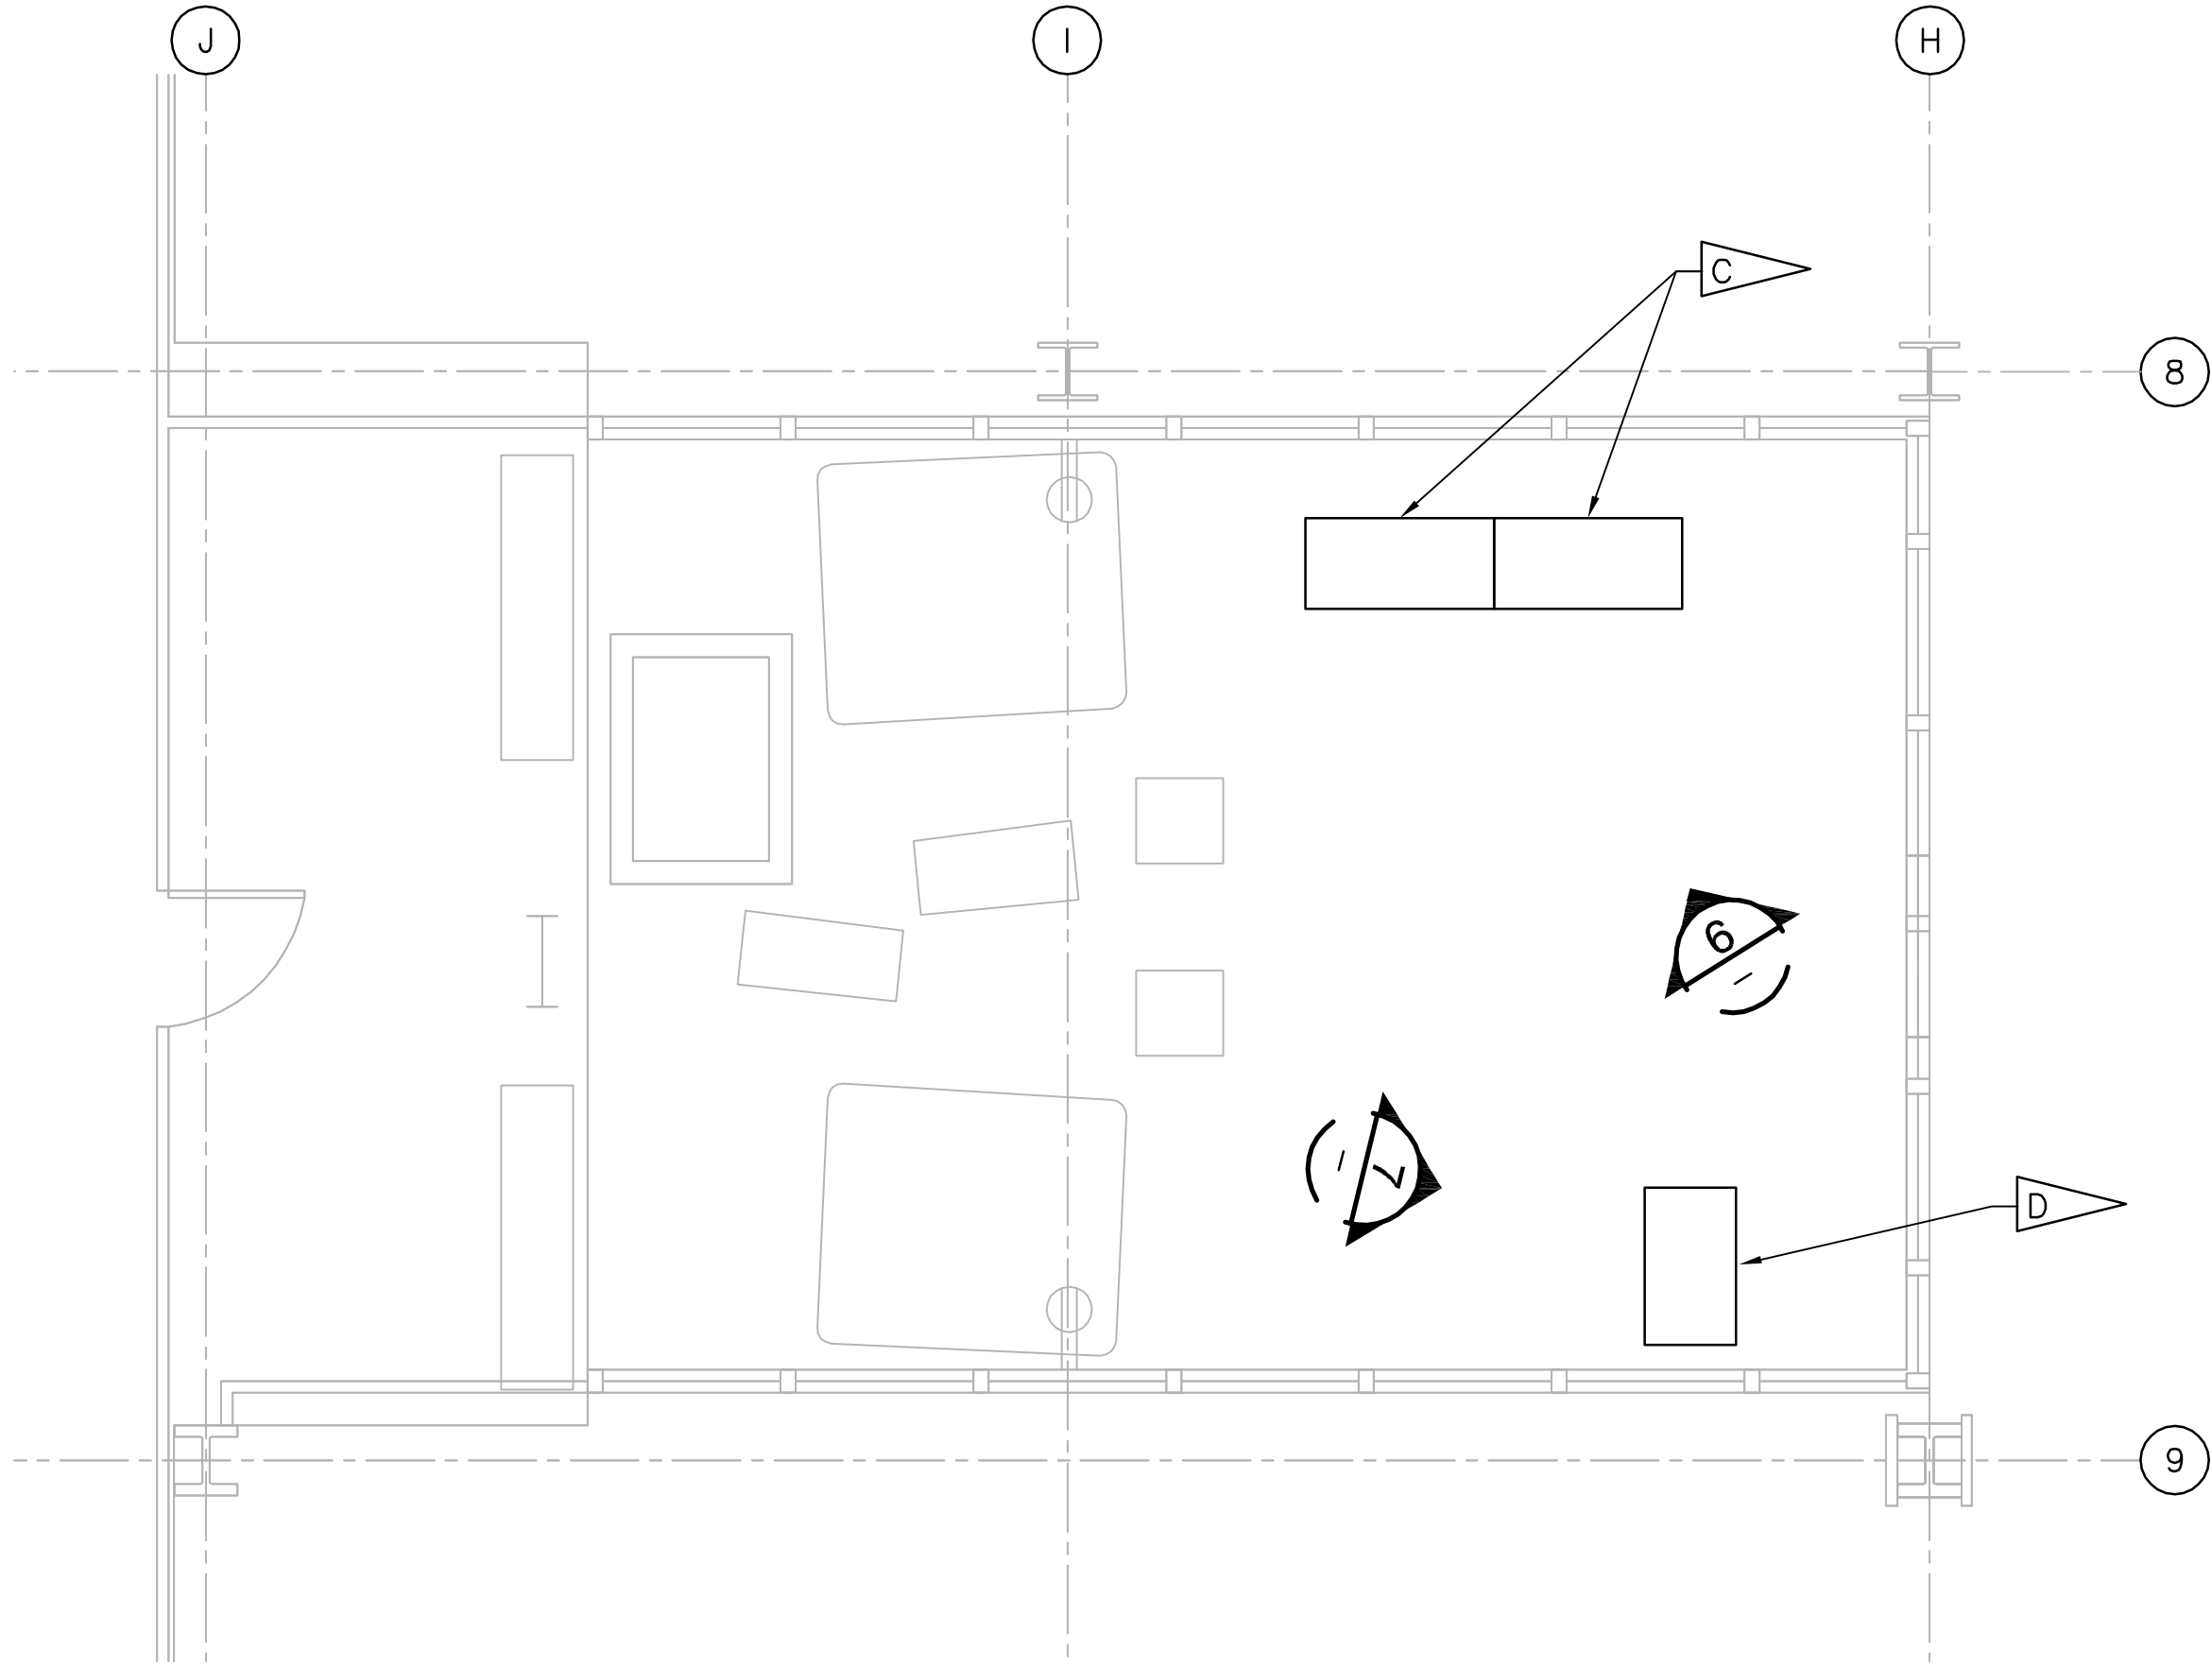

LEVEL 36 - ELECTRICAL DEMOLITION - TOWER E
SCALE: 1/4" = 1'-0"

SPECIFIC NOTES:

- A. NOT ALL ELEVATOR EQUIPMENT AND ACCESSORY CABINETS ARE SHOWN.
- B. REMOVE EXISTING ABANDONED IN PLACE PLATFORM HOIST, ASSOCIATED CABLING, RACEWAYS AND CONTROLLER IN THEIR ENTIRETY.
- C. REMOVE EXISTING ABANDONED IN PLACE ELEVATOR CONTROL CABINET(S), ASSOCIATED CABLING AND RACEWAYS IN THEIR ENTIRETY.
- D. REMOVE EXISTING ABANDONED IN PLACE ELEVATOR DISPATCHER CABINET ASSOCIATED CABLING AND RACEWAYS IN THEIR ENTIRETY.
- E. CONTRACTOR SHALL COORDINATE HERITAGE EQUIPMENT REMOVAL WITH THE ENVIRONMENTAL SPECIFICATIONS.
- F. COORDINATE THE REMOVAL OF EQUIPMENT WITH MECHANICAL AND STRUCTURAL DISCIPLINES. REFER TO STRUCTURAL DRAWINGS FOR THE PATCHING OF FLOOR PENETRATIONS.

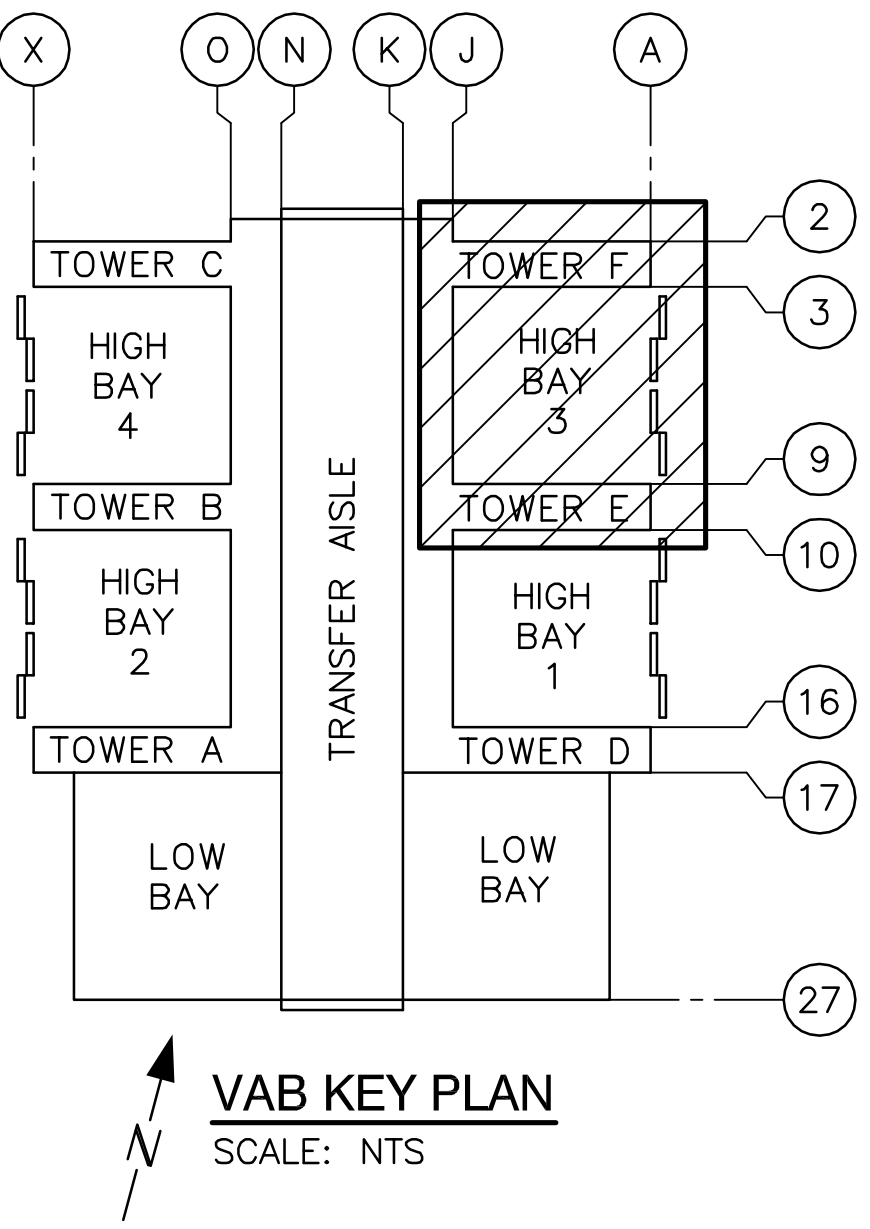


VAB KEY PLAN
SCALE: NTS

2 1 0 2 4 6 8 10
1/4 IN = 1 FT
WHEN PRINTED FULL SIZE, THIS SHEET IS 34"x44"
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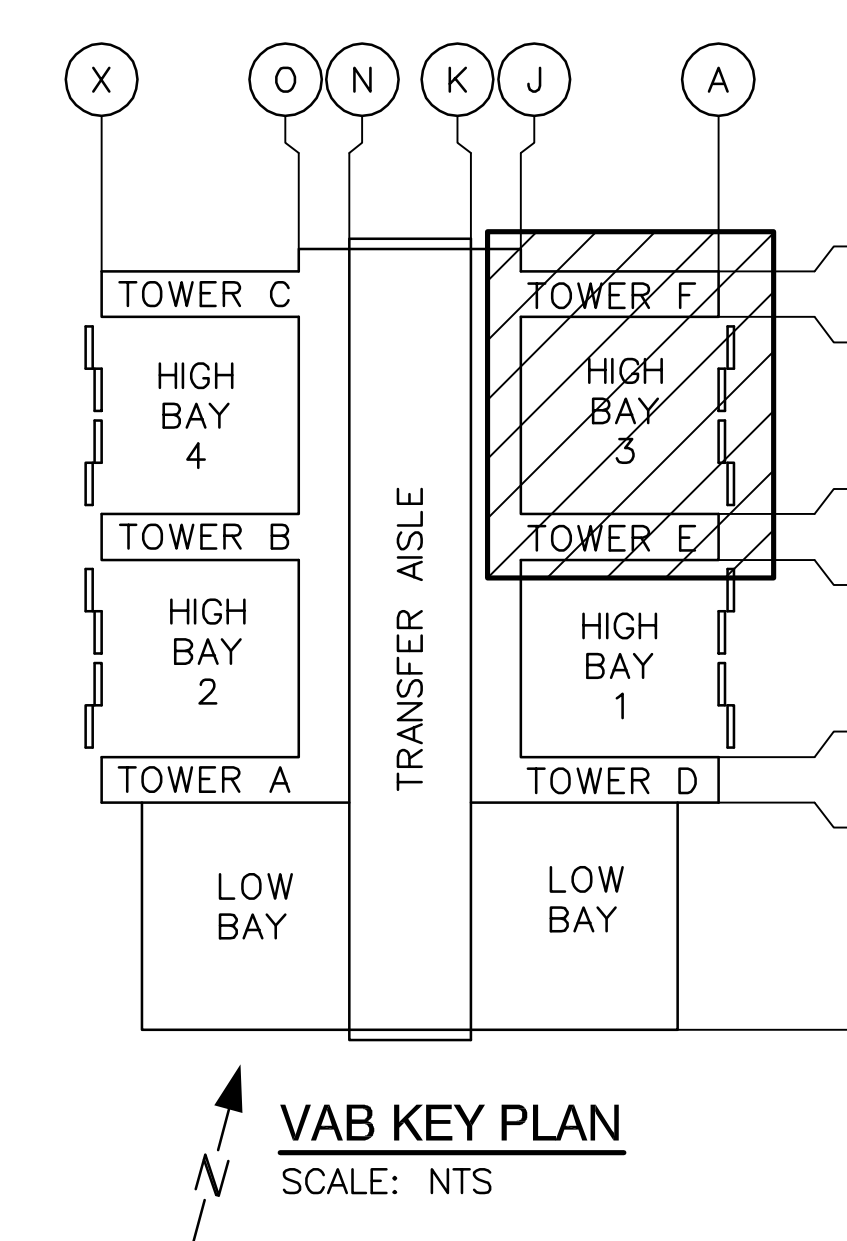
ED-136

SYM	ZONE	DESCRIPTION	DATE	APPROVAL
REVISIONS				
SIGNATURES		DATE	REVISIONS	
DRAWN: JOSEPH HAUER		08-20-2013	NATIONAL AERONAUTICS AND SPACE ADMINISTRATION	
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SUBMITTED ARCHIVING OF RECORD:			KENNEDY SPACE CENTER, FLORIDA	
KEVIN HARRIS			LAUNCH COMPLEX 39	
ST OF LICENSE: FL			VEHICLE ASSEMBLY BUILDING	
LICENSE NO:			MODIFY VEHICLE ASSEMBLY BUILDING	
APPROVED:			HIGH BAY 3 FOR SLS - HOISTS	
JOHN KERCSMAR			LEVEL 36 - ELECTRICAL	
MIKE HARTNETT			DEMOLITION PLANS	
FILE NO.		302-6058-043	SIZE	
PCN		99000.5	DWG. NO.	
SHEET		34	REV	
OF				

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- SPECIFIC NOTES:**
- A** PROVIDE 1200A, 480V, 3PH, 3W DISTRIBUTION SWITCHBOARD 32EPA1. SEE E-601 FOR ONE-LINE AND PANEL SCHEDULE AND E-580 FOR MOUNTING DETAILS. EXTEND EXISTING LIGHTING CIRCUITS OVER SS809 FOR NEW TYPE A FIXTURE OVER SWBD 32EPA1.
 - B** SEE E-641 FOR PLATFORM HOIST ELEMENTARY CONTROLLER DIAGRAM AND TYPICAL OPERATOR CONSOLE ELEVATION. SEE SPECIFICATIONS 41 22 23.19 FOR REQUIRED EQUIPMENT PARAMETERS. COORDINATE LOCATION OF CONTROLLER WITH HOIST EQUIPMENT MANUFACTURER AND EXISTING FACILITY STRUCTURE.
 - C** PROVIDE NEW CONVENIENCE RECEPTACLE RECEIVING POWER FROM EXISTING PANEL 32FEB CIRCUIT 14. SURFACE MOUNT RECEPTACLE ON EXISTING STRUCTURAL COLUMN. REFER TO DRAWING E-580 FOR ADDITIONAL DETAIL.
 - D** PROVIDE STRUCTURE TO INDEPENDENTLY SUPPORT EXISTING PANELBOARD 32FEB AND RACEWAYS. PANELBOARD 32FEB AND ITS ASSOCIATED RACEWAYS ARE CURRENTLY SUPPORTED BY THE FENCING BEING REMOVED. SEE SHEET A-506 FOR FENCING MODIFICATION PLANS.
 - E** PROVIDE NEW LAMPS FOR EXISTING 400W MERCURY VAPOR HID AND SINGLE TUBE FLUORESCENT EMERGENCY LIGHTING. CONTRACTOR TO SERVICE FIXTURES AND REWORK LIGHTING CIRCUITS BACK TO PANEL 32FLA FOR HID LIGHTING AND EMERGENCY PANEL 28FEA FOR THE EMERGENCY FIXTURES AS REQUIRED FOR FULLY FUNCTIONING FIXTURES. PROVIDE SWITCH-RATED CIRCUIT BREAKERS FOR CONTROLLING FIXTURES.

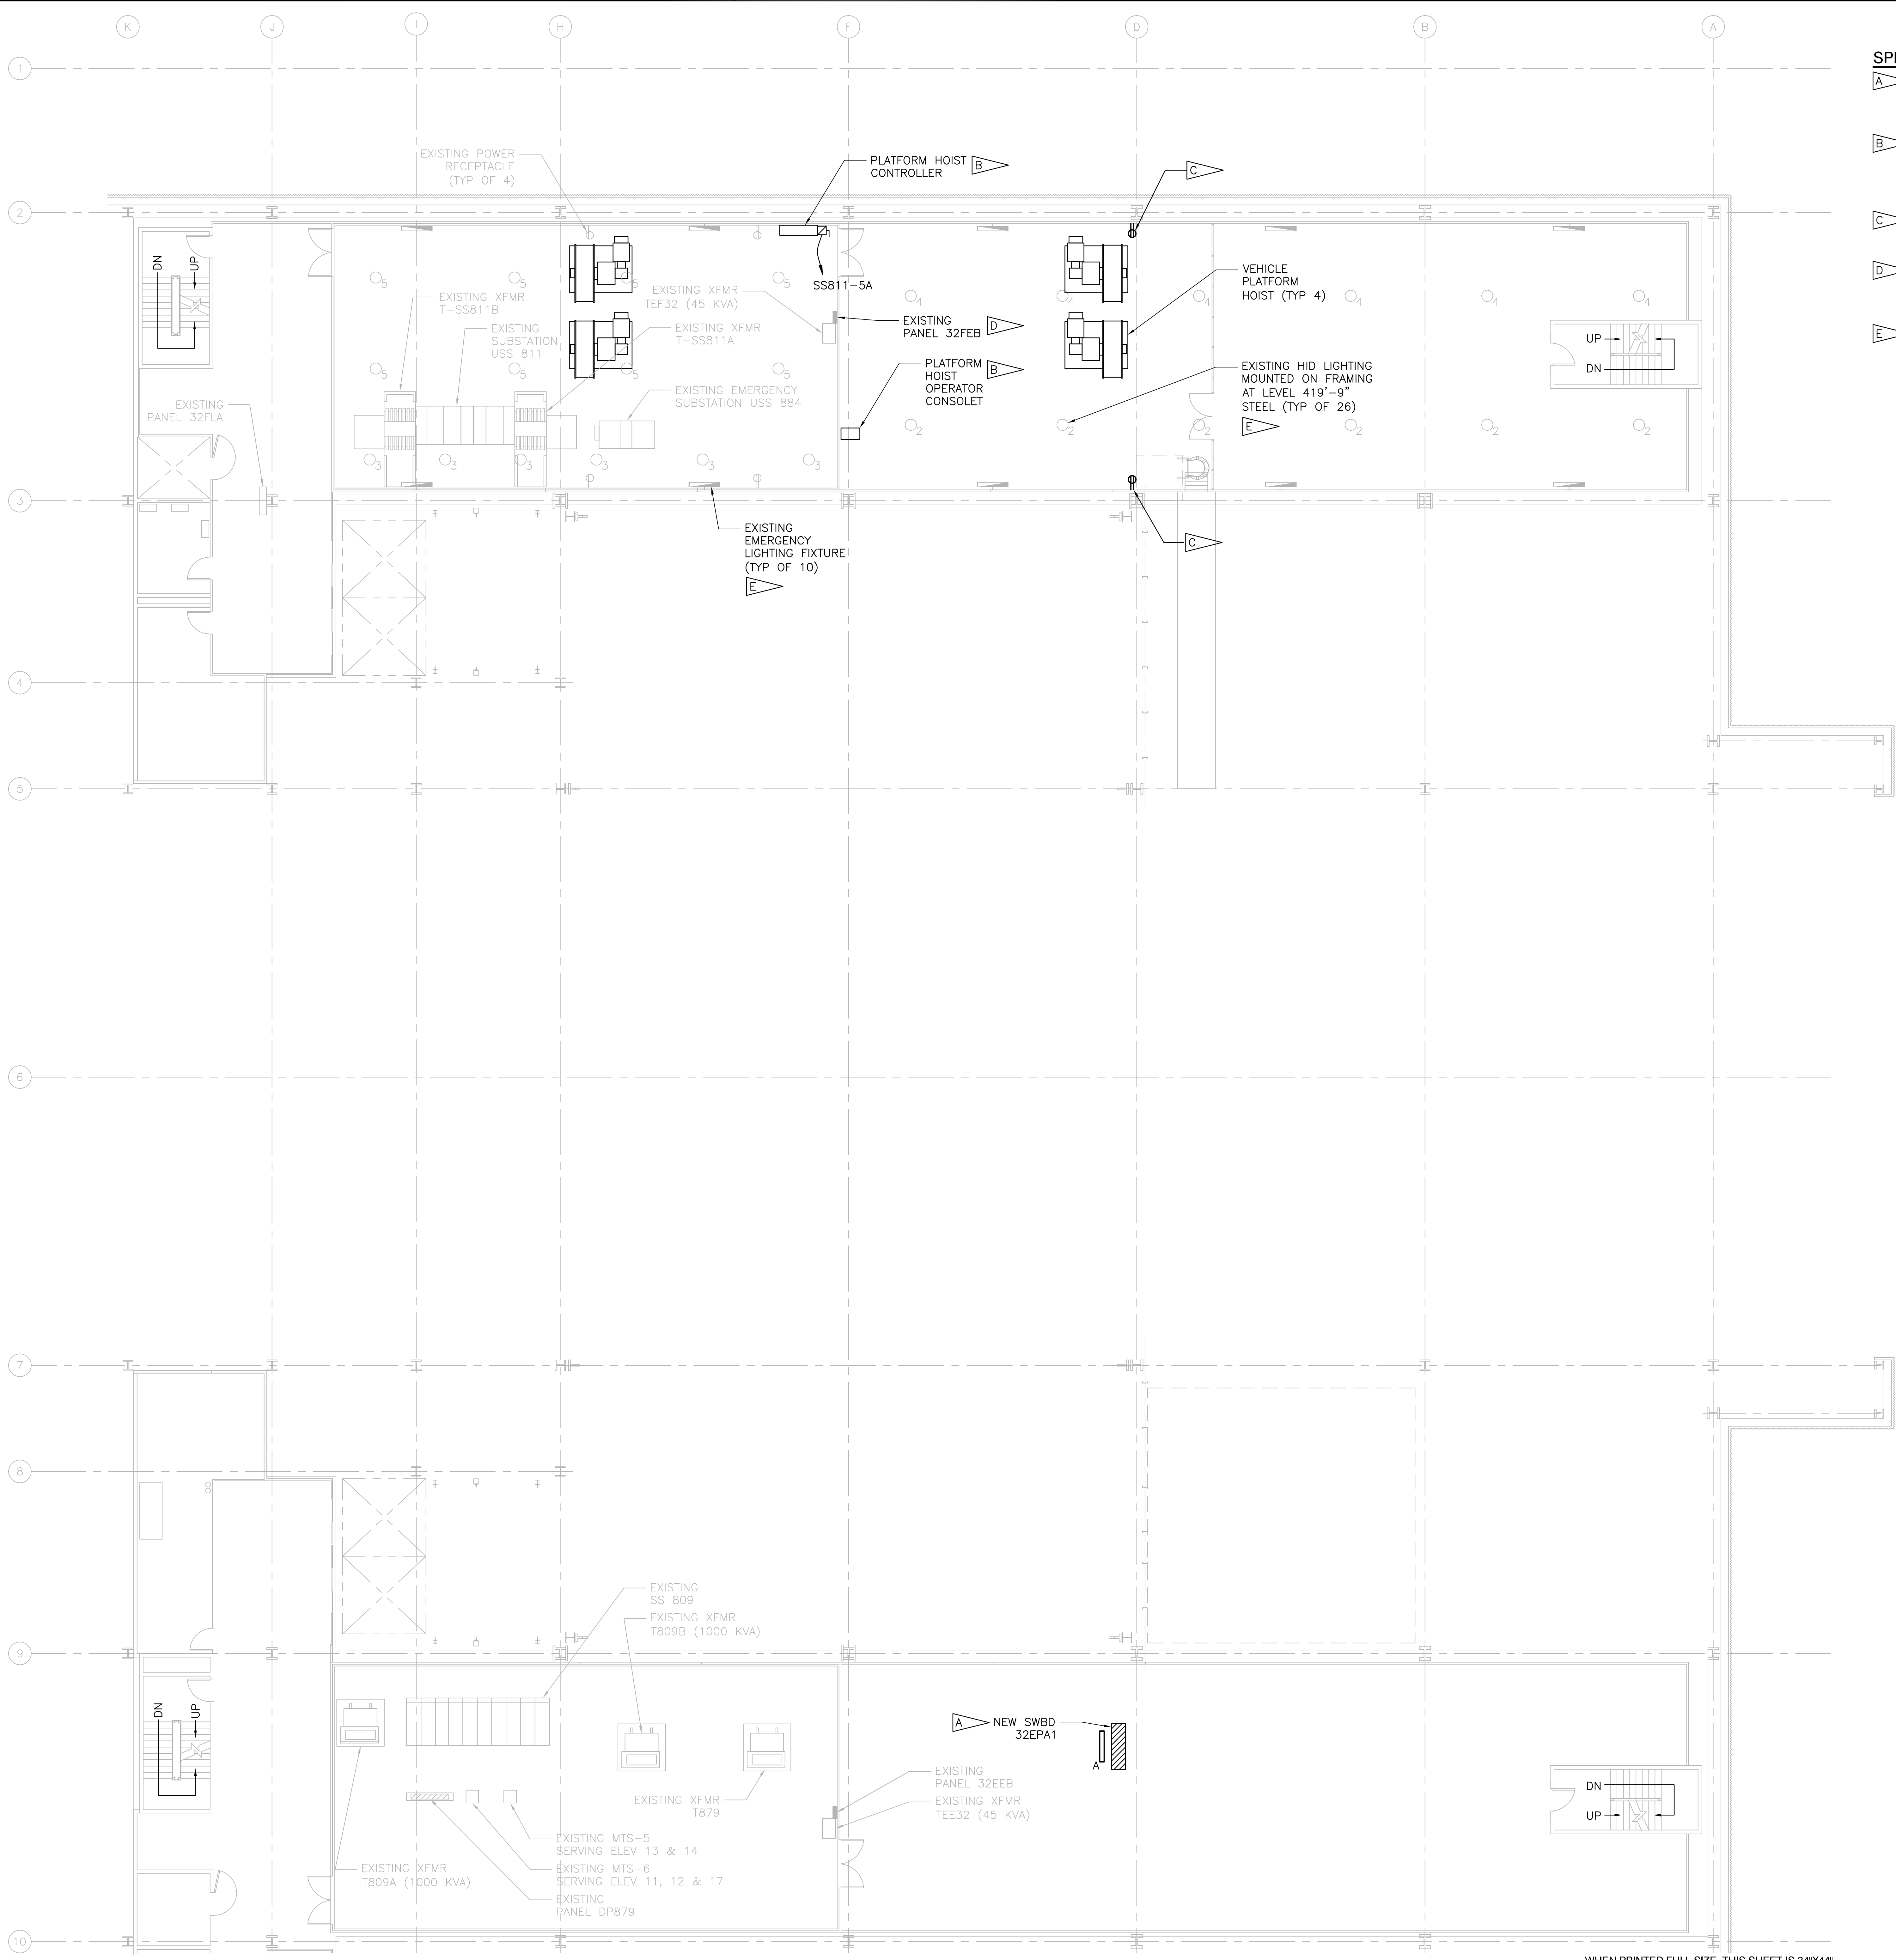


POWER AND SYSTEMS PLAN
SCALE: 1/8" = 1'-0"

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1/8 IN = 1 FT
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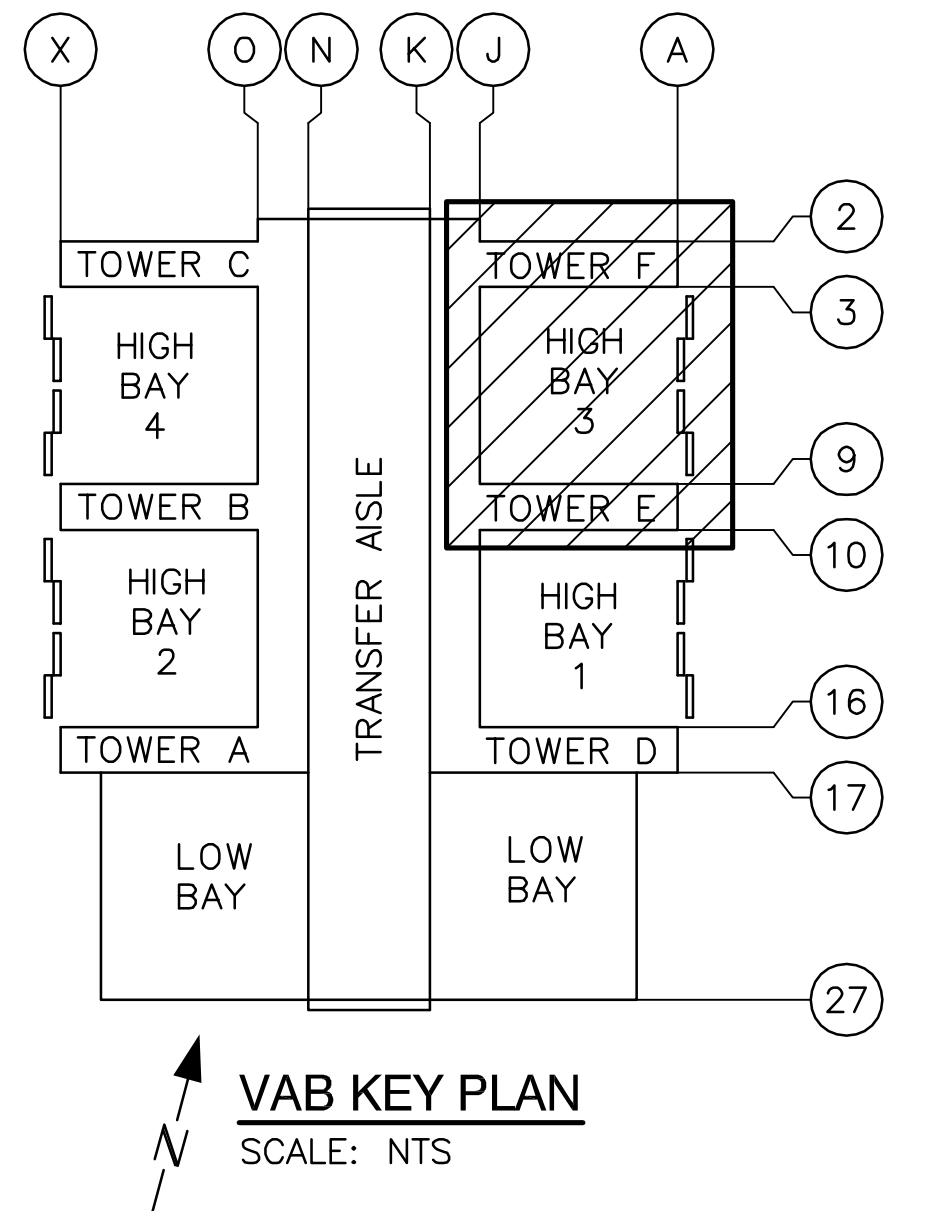
SYM	ZONE	DESCRIPTION	DATE	APPROVAL
REVISIONS				
SIGNATURES		DATE	NATIONAL AERONAUTICS AND SPACE ADMINISTRATION	
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CHECKED: DANIEL VIGANT		08-20-2013	KENNEDY SPACE CENTER, FLORIDA	
SUBMITTED ARCHIVING OF RECORD			LAUNCH COMPLEX 39	
KEVIN HARRIS			VEHICLE ASSEMBLY BUILDING	
ST OF LICENSURE: FL			MODIFY VEHICLE ASSEMBLY BUILDING	
LICENSE NO:			HIGH BAY 3 FOR SLS - HOISTS	
APPROVED:			LEVEL 32 - ELECTRICAL PLAN	
JOHN KERESMAR			FILE NO. 302-6058-043	
MIKE HARTNETT			SIZE DWG NO. 79K39667	
			PROJ. NO. PCN 99000.5	
			SHEET 35 OF	

E-132

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- SPECIFIC NOTES:**
- A** SEE E-641 FOR PLATFORM HOIST ELEMENTARY CONTROLLER DIAGRAM AND TYPICAL OPERATOR CONSOLE ELEVATION. SEE SPECIFICATIONS 41 22 23.19 FOR REQUIRED EQUIPMENT PARAMETERS. COORDINATE LOCATION OF CONTROLLER WITH HOIST EQUIPMENT MANUFACTURER AND EXISTING FACILITY STRUCTURE.
 - B** PROVIDE NEW CONVENIENCE RECEPTACLE RECEIVING POWER FROM EXISTING PANEL 32EEB CIRCUIT 17. SURFACE MOUNT RECEPTACLE ON EXISTING STRUCTURAL COLUMN. REFER TO DRAWING E-580 FOR ADDITIONAL DETAIL.
 - C** PROVIDE NEW LAMPS FOR EXISTING 400W MERCURY VAPOR HID. CONTRACTOR TO SERVICE FIXTURES AND REWORK LIGHTING CIRCUITS BACK TO PANEL 34ELA FOR HID LIGHTING AS REQUIRED FOR FULLY FUNCTIONING FIXTURES. PROVIDE SWITCH-RATED CIRCUIT BREAKERS FOR CONTROLLING FIXTURES.

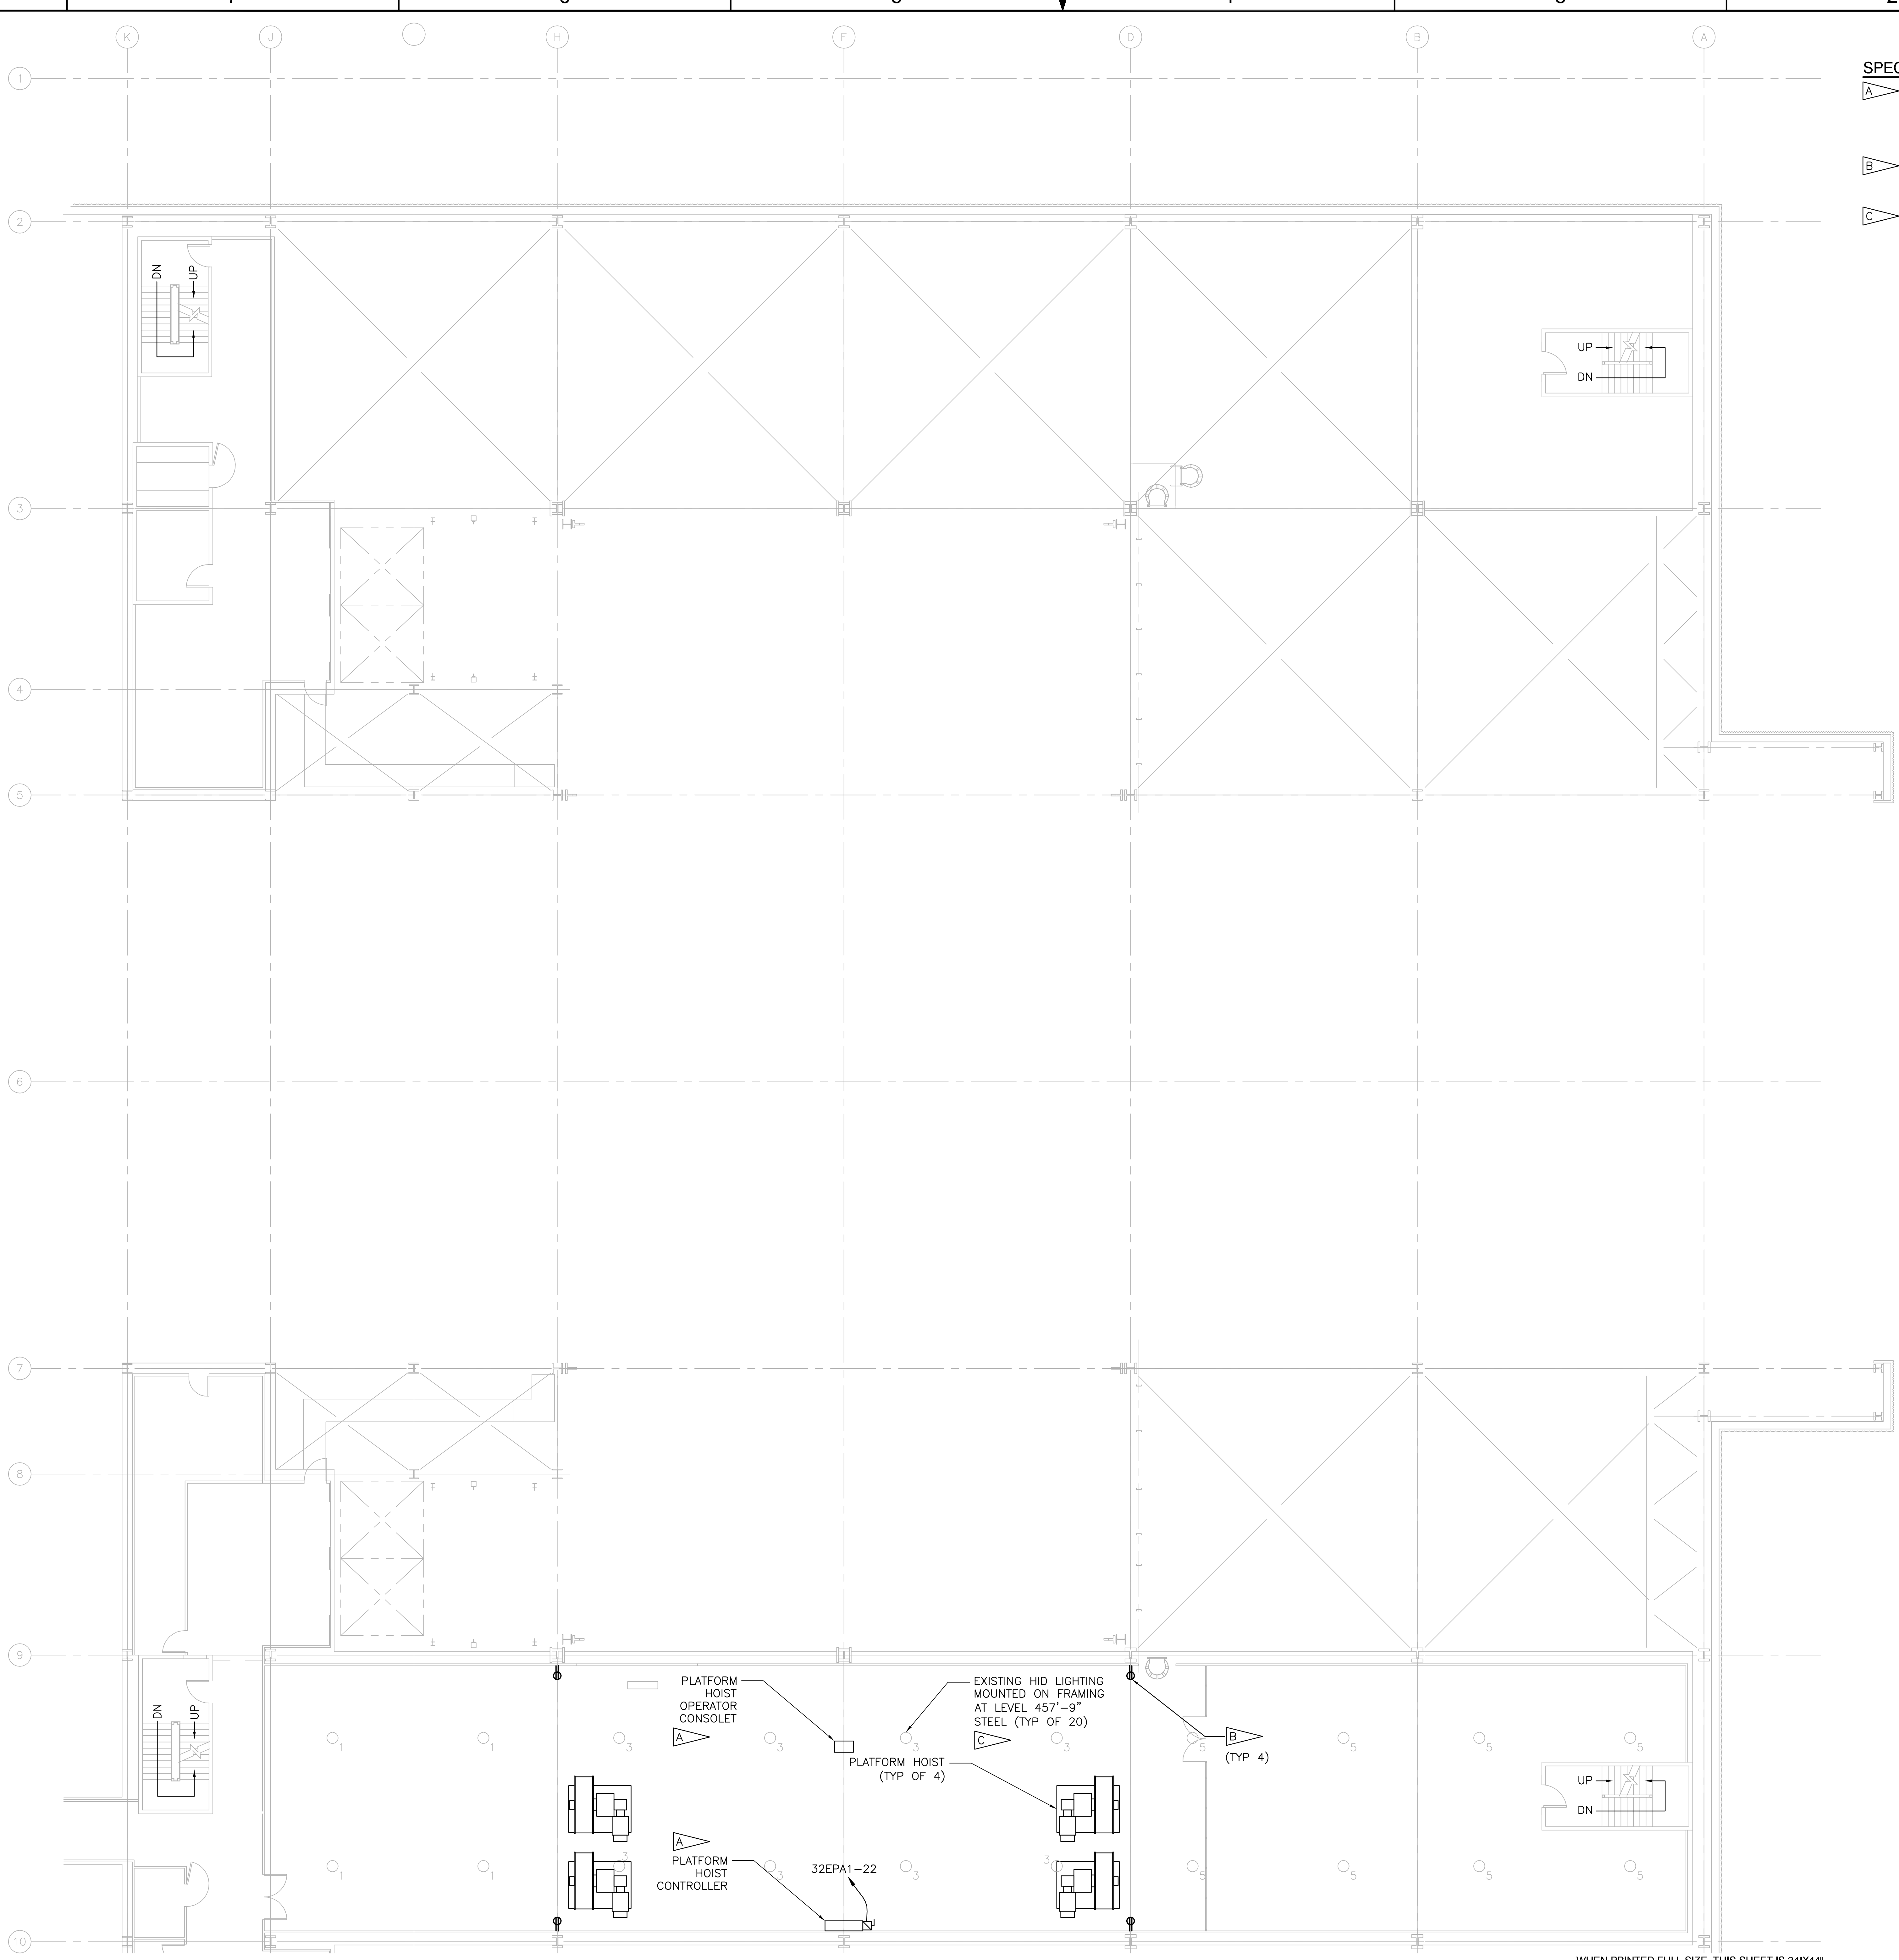

POWER AND SYSTEMS PLAN
SCALE: 1/8" = 1'-0"

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REVISIONS				
SIGNATURES				
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CHECKED: DANIEL VIGANT		DATE: 08-20-2013		
SUBMITTED ARCHIVING OF RECORD:				
KEVIN HARRIS				
ST OF LICENSE: FL				
LICENSE NO:				
APPROVED:				
JOHN KERCSMAR				
MIKE HARTNETT				

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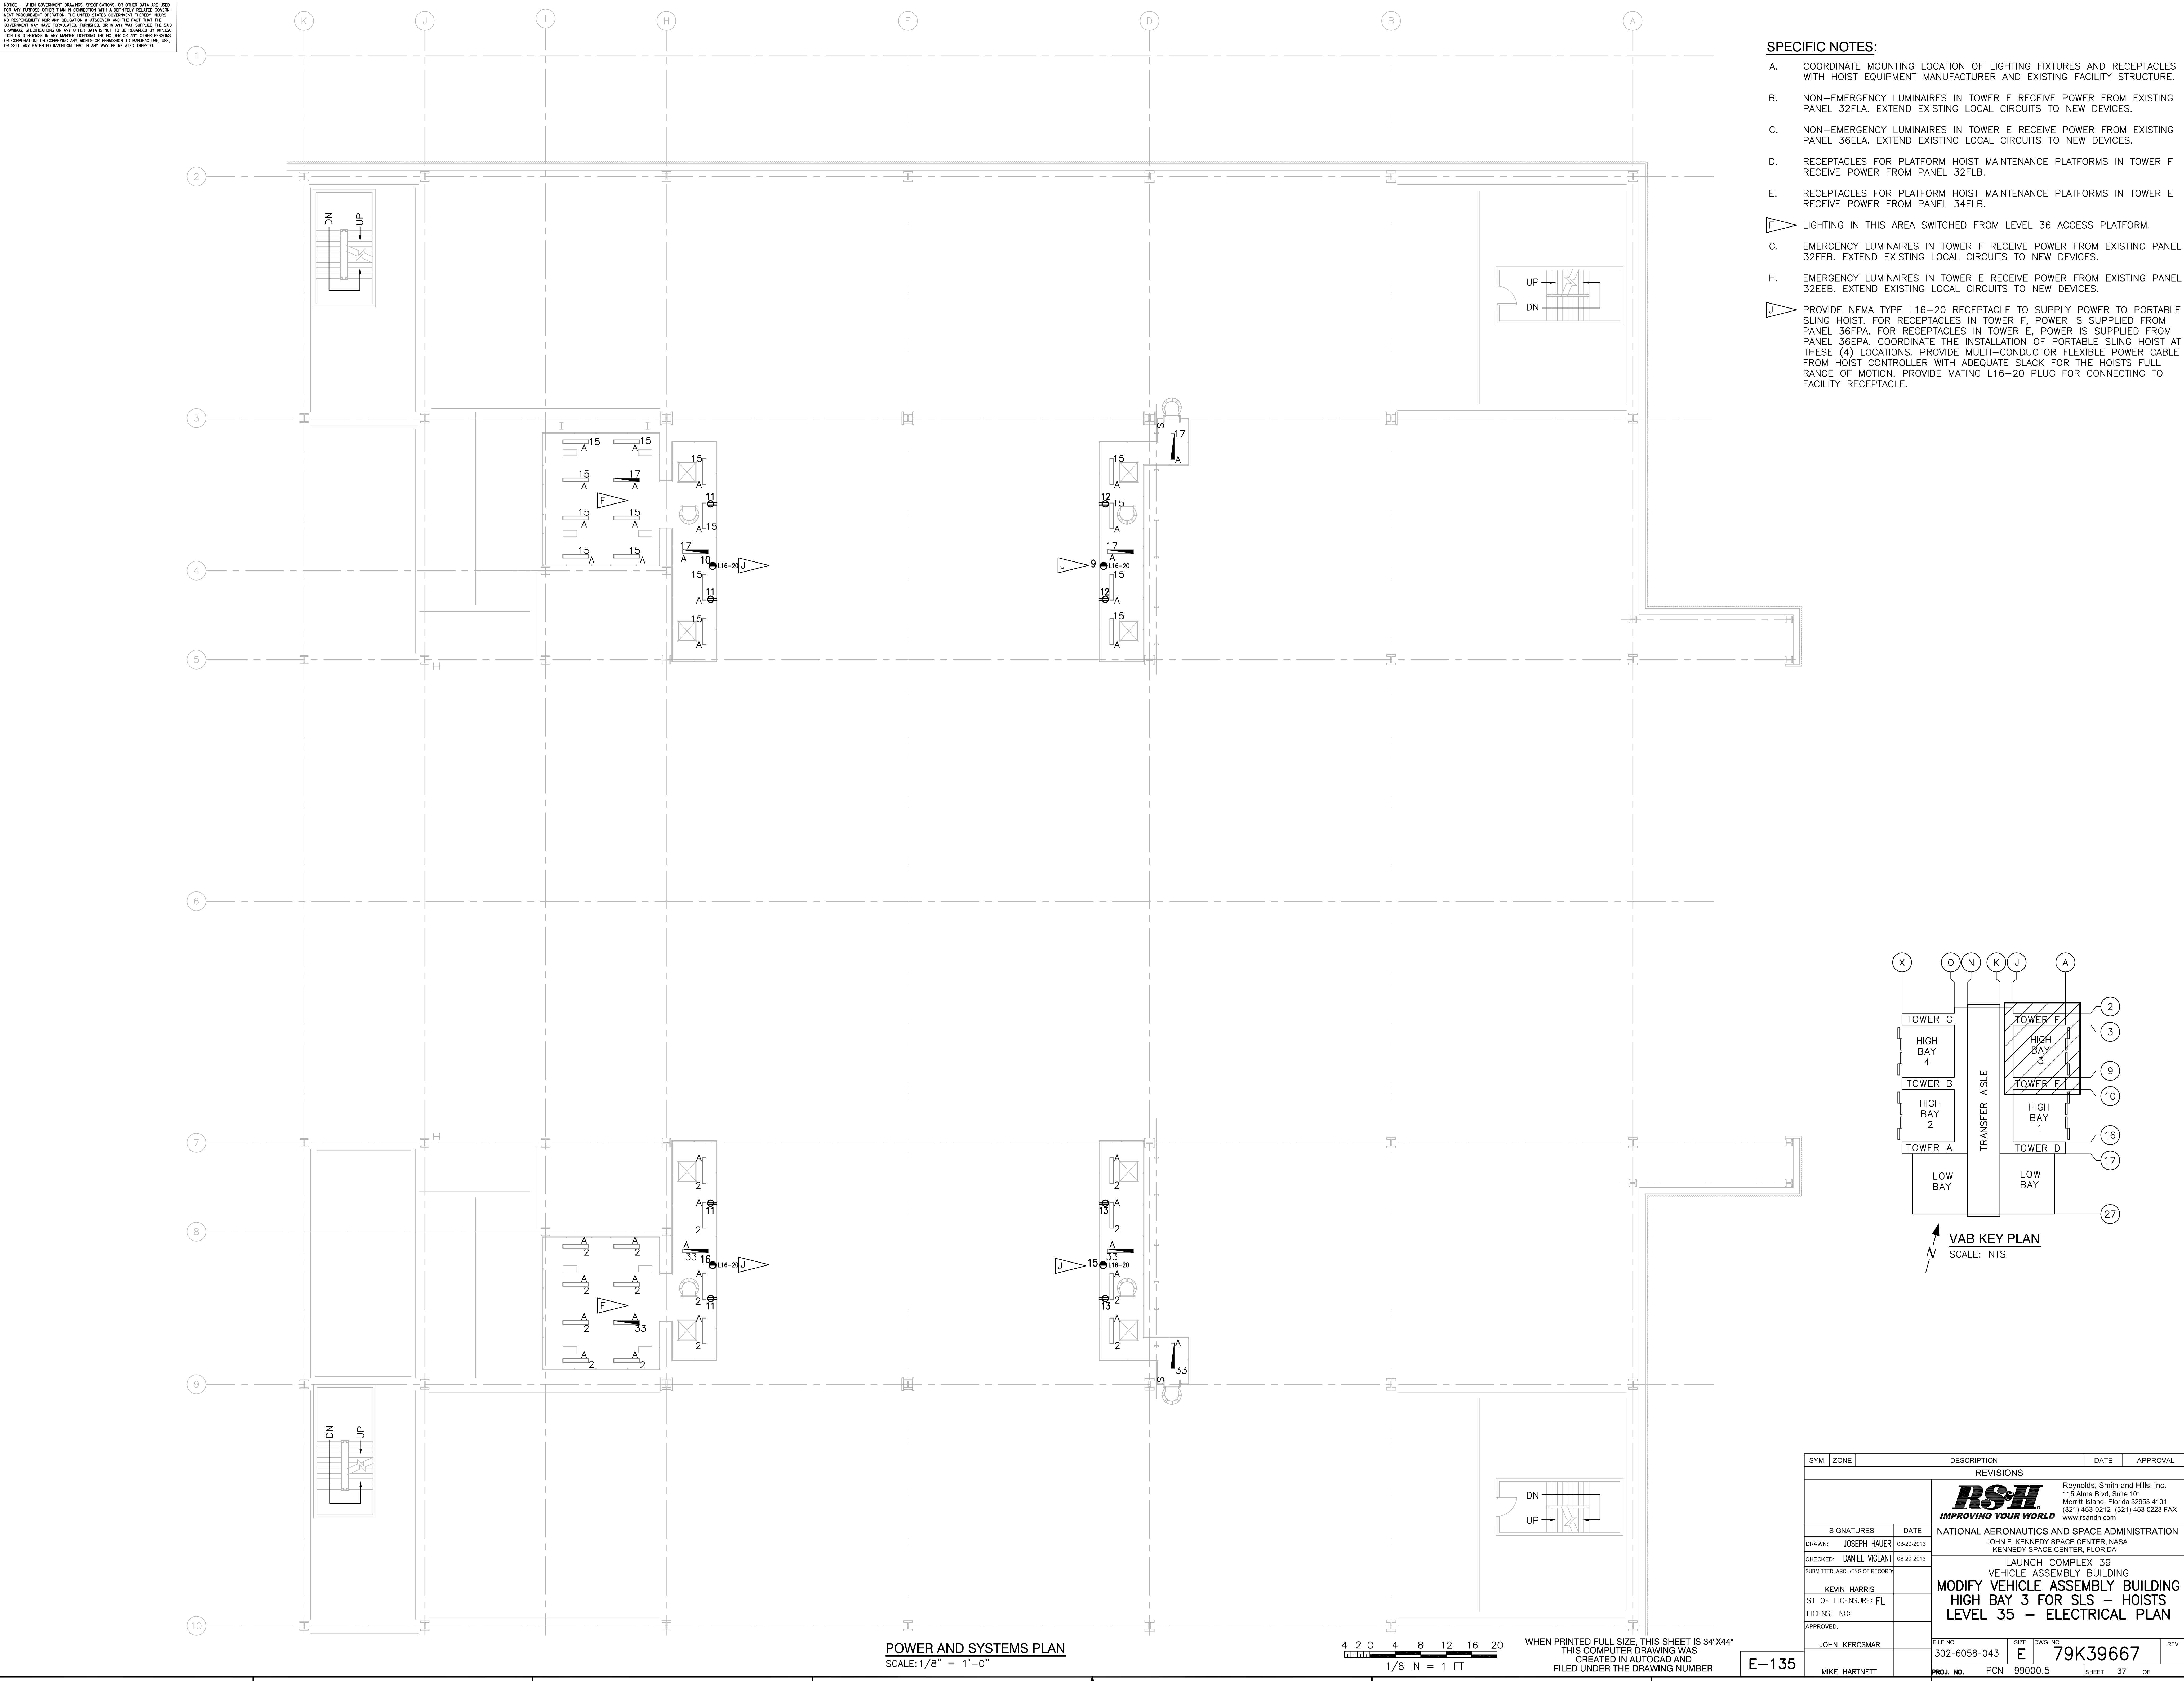
NATIONAL AERONAUTICS AND SPACE ADMINISTRATION
JOHN F. KENNEDY SPACE CENTER, NASA
KENNEDY SPACE CENTER, FLORIDA

LAUNCH COMPLEX 39
VEHICLE ASSEMBLY BUILDING
MODIFY VEHICLE ASSEMBLY BUILDING
HIGH BAY 3 FOR SLS - HOISTS
LEVEL 34 - ELECTRICAL PLAN


FILE NO. 302-6058-043
SIZE E
DWS NO. 79K39667
REV

PROJ. NO. PCN 99000.5
SHEET 36 OF

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- SPECIFIC NOTES:**
- A. COORDINATE MOUNTING LOCATION OF LIGHTING FIXTURES AND RECEPTACLES WITH HOIST EQUIPMENT MANUFACTURER AND EXISTING FACILITY STRUCTURE.
 - B. NON-EMERGENCY LUMINAIRES IN TOWER F RECEIVE POWER FROM EXISTING PANEL 32FLA. EXTEND EXISTING LOCAL CIRCUITS TO NEW DEVICES.
 - C. NON-EMERGENCY LUMINAIRES IN TOWER E RECEIVE POWER FROM EXISTING PANEL 36ELA. EXTEND EXISTING LOCAL CIRCUITS TO NEW DEVICES.
 - D. RECEPTACLES FOR PLATFORM HOIST MAINTENANCE PLATFORMS IN TOWER F RECEIVE POWER FROM PANEL 32FLB.
 - E. RECEPTACLES FOR PLATFORM HOIST MAINTENANCE PLATFORMS IN TOWER E RECEIVE POWER FROM PANEL 34ELB.
 - F. LIGHTING IN THIS AREA SWITCHED FROM LEVEL 36 ACCESS PLATFORM.
 - G. EMERGENCY LUMINAIRES IN TOWER F RECEIVE POWER FROM EXISTING PANEL 32FEB. EXTEND EXISTING LOCAL CIRCUITS TO NEW DEVICES.
 - H. EMERGENCY LUMINAIRES IN TOWER E RECEIVE POWER FROM EXISTING PANEL 32EEB. EXTEND EXISTING LOCAL CIRCUITS TO NEW DEVICES.
 - J. PROVIDE NEMA TYPE L16-20 RECEPTACLE TO SUPPLY POWER TO PORTABLE SLING HOIST. FOR RECEPTACLES IN TOWER F, POWER IS SUPPLIED FROM PANEL 36FPA. FOR RECEPTACLES IN TOWER E, POWER IS SUPPLIED FROM PANEL 36EPA. COORDINATE THE INSTALLATION OF PORTABLE SLING HOIST AT THESE (4) LOCATIONS. PROVIDE MULTI-CONDUCTOR FLEXIBLE POWER CABLE FROM HOIST CONTROLLER WITH ADEQUATE SLACK FOR THE HOISTS FULL RANGE OF MOTION. PROVIDE MATING L16-20 PLUG FOR CONNECTING TO FACILITY RECEPTACLE.



POWER AND SYSTEMS PLAN
SCALE: 1/8" = 1'-0"

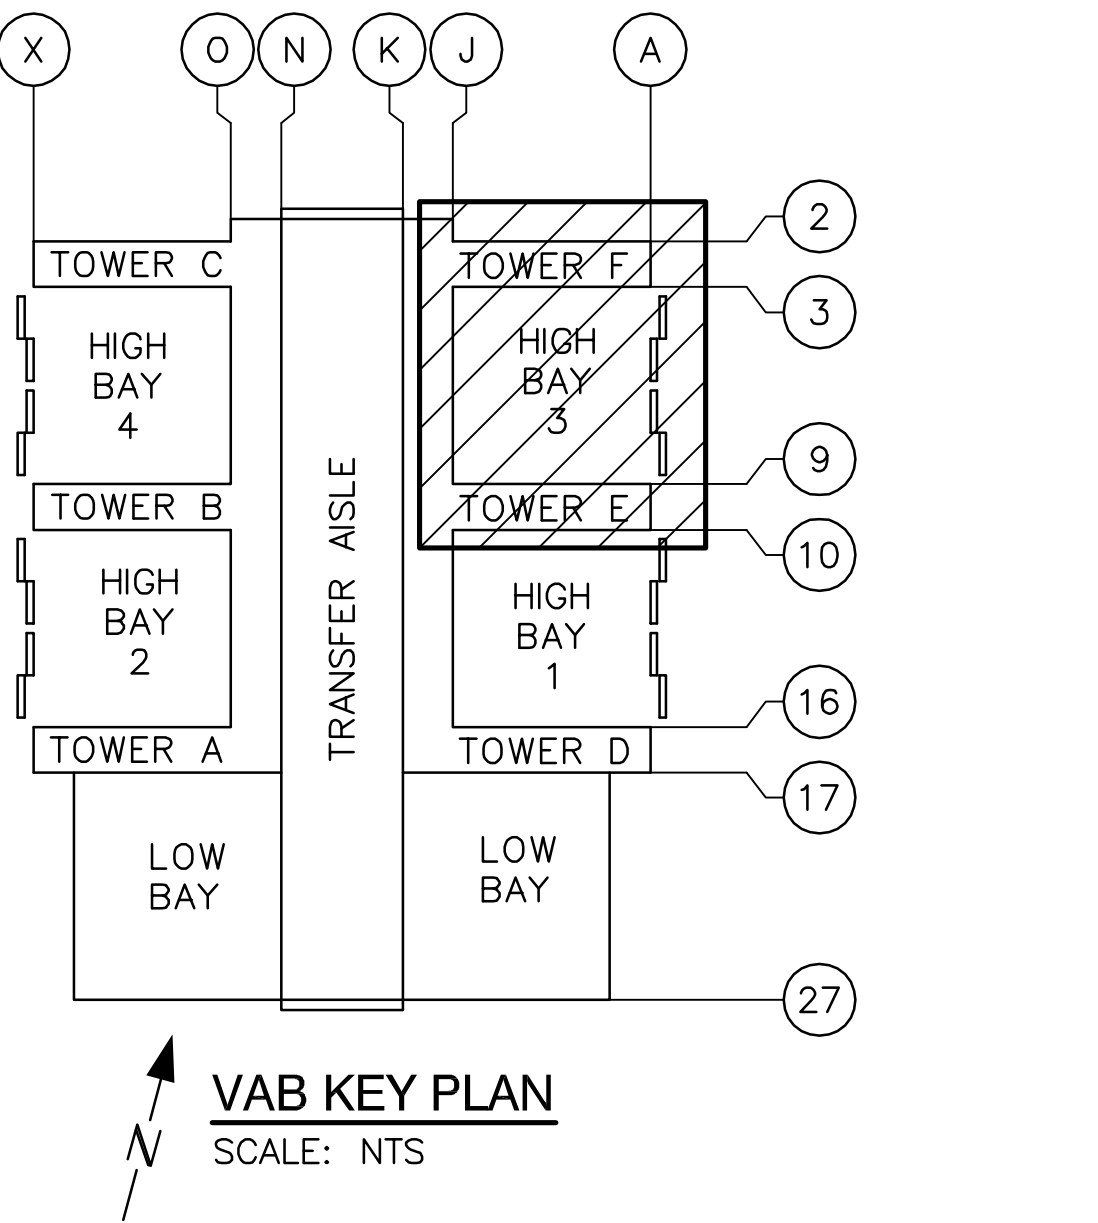
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REVISIONS				
SIGNATURES		DATE	NATIONAL AERONAUTICS AND SPACE ADMINISTRATION	
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CHECKED: DANIEL VIGANT		08-20-2013	KENNEDY SPACE CENTER, FLORIDA	
SUBMITTED ARCHIVING OF RECORD			LAUNCH COMPLEX 39	
KEVIN HARRIS			VEHICLE ASSEMBLY BUILDING	
ST OF LICENSURE: FL			MODIFY VEHICLE ASSEMBLY BUILDING	
LICENSE NO:			HIGH BAY 3 FOR SLS - HOISTS	
APPROVED:			LEVEL 35 - ELECTRICAL PLAN	
JOHN KERCSMAR			FILE NO.	SIZE
MIKE HARTNETT			302-6058-043	E
			DWG. NO.	79K39667
			PROJ. NO.	PCN 99000.5
			SHEET	37 OF


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SPECIFIC NOTES:

- A. SEE E-641 FOR PLATFORM HOIST ELEMENTARY CONTROLLER DIAGRAM AND TYPICAL OPERATOR CONSOLE/ELEVATION. SEE SPECIFICATIONS 41.22.23.19 FOR REQUIRED EQUIPMENT PARAMETERS. COORDINATE LOCATION OF CONTROLLER WITH HOIST EQUIPMENT MANUFACTURER AND EXISTING FACILITY STRUCTURE.
- B. NON-EMERGENCY LUMINAIRES IN TOWER F RECEIVE POWER FROM EXISTING PANEL 32FLA. EXTEND EXISTING LOCAL CIRCUITS TO NEW DEVICES.
- C. NON-EMERGENCY LUMINAIRES IN TOWER E RECEIVE POWER FROM EXISTING PANEL 36ELA. EXTEND EXISTING LOCAL CIRCUITS TO NEW DEVICES.
- D. LIGHTING IN THIS AREA SWITCHED FROM LEVEL 35 ACCESS PLATFORM.
- E. EMERGENCY LUMINAIRES IN TOWER F RECEIVE POWER FROM EXISTING PANEL 32FEB. EXTEND EXISTING LOCAL CIRCUITS TO NEW DEVICES.
- F. EMERGENCY LUMINAIRES IN TOWER E RECEIVE POWER FROM EXISTING PANEL 32EEB. EXTEND EXISTING LOCAL CIRCUITS TO NEW DEVICES.



VAB KEY PLAN
SCALE: NTS

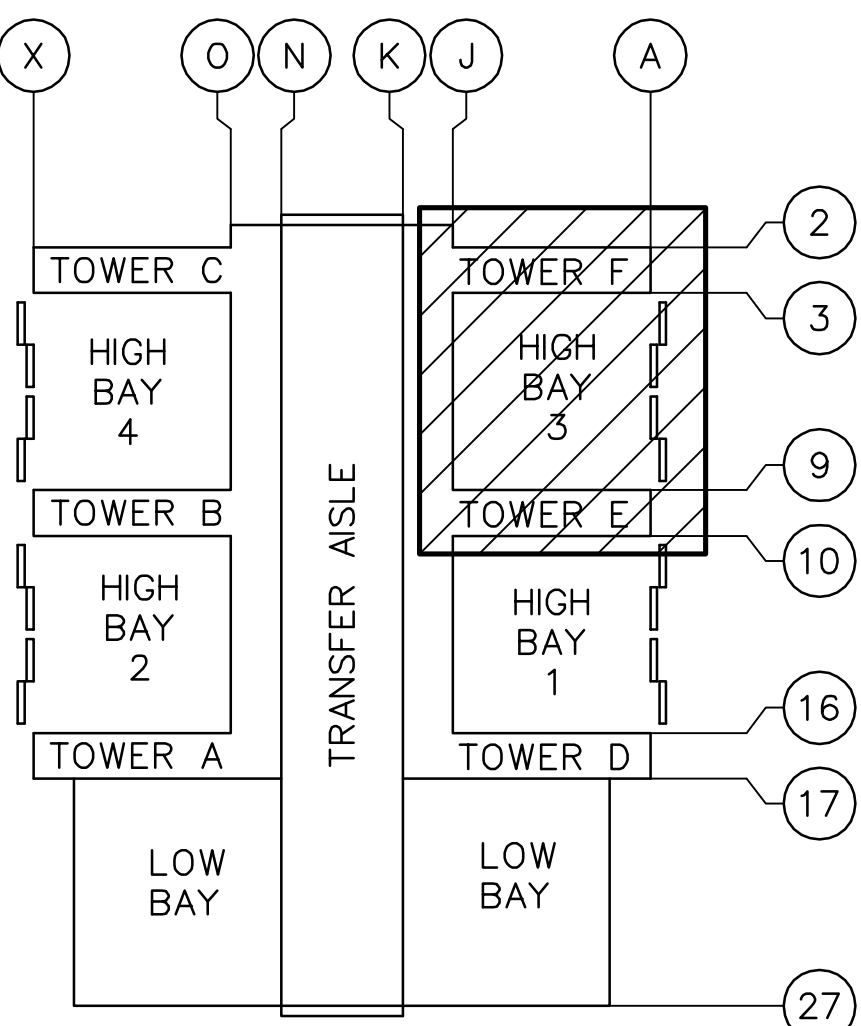

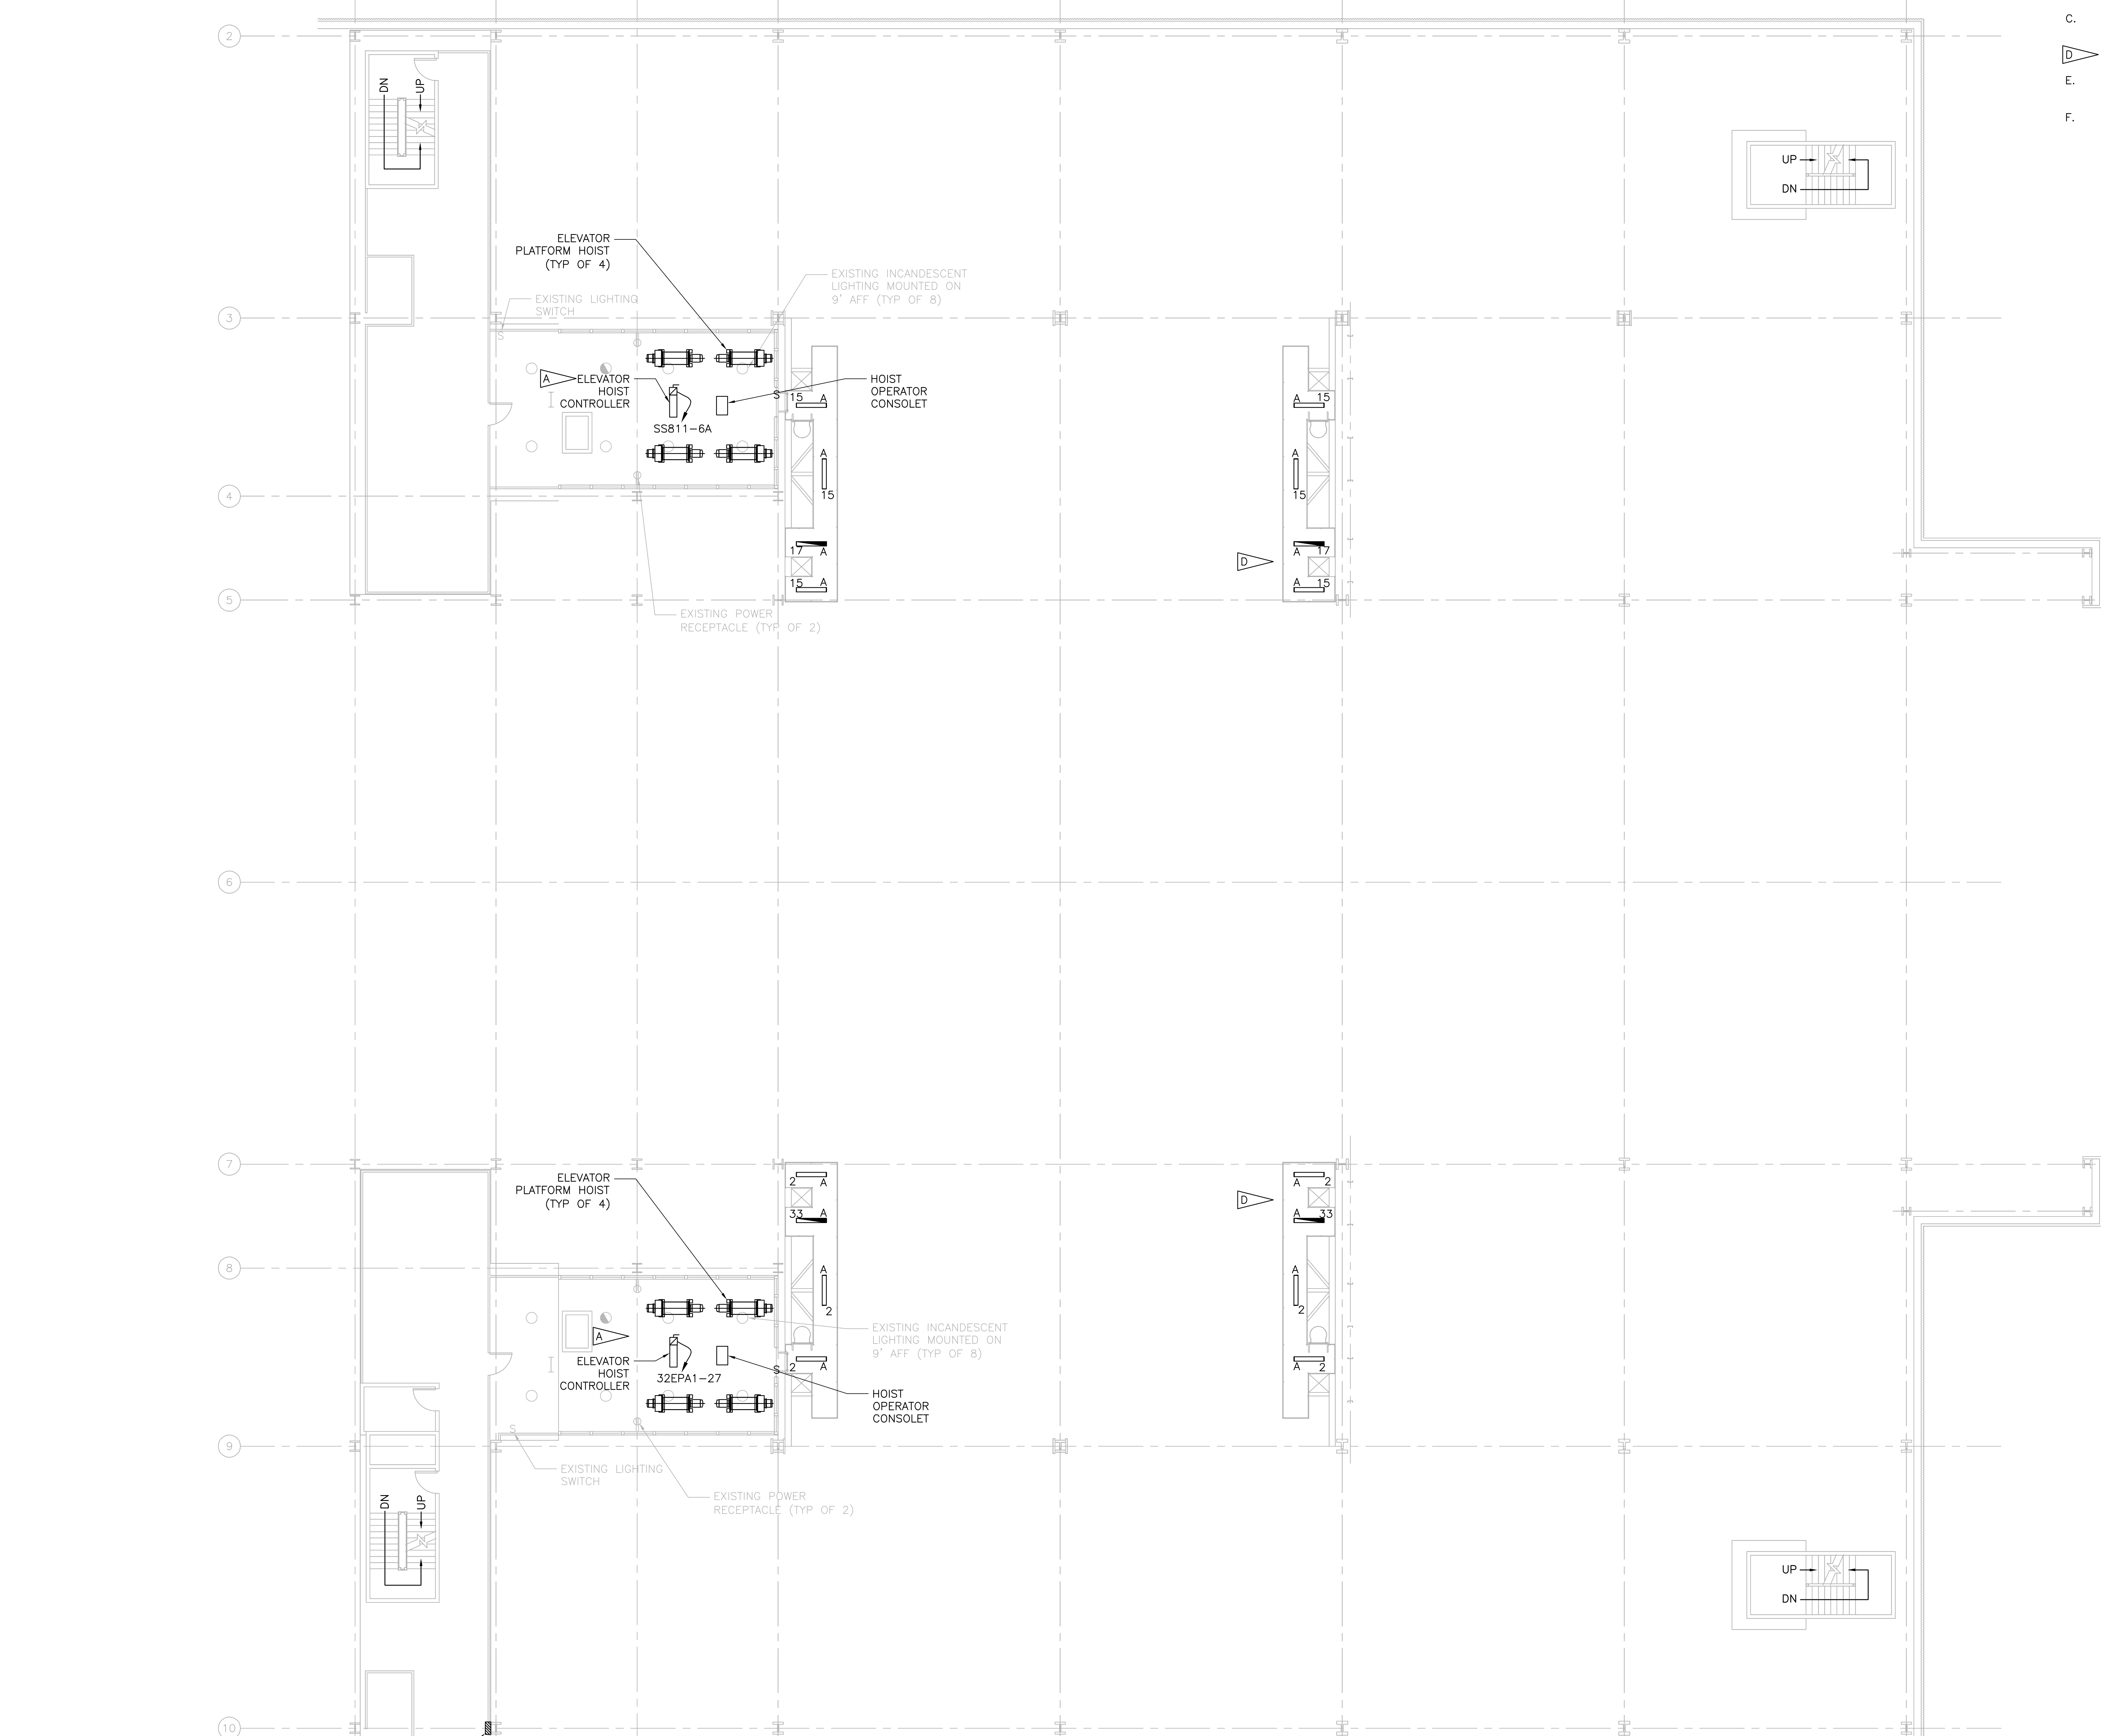POWER AND SYSTEMS PLAN
SCALE: 1/8" = 1'-0"


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1/8 IN = 1 FT

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E-136

SYM	ZONE	DESCRIPTION	DATE	APPROVAL
REVISIONS				
SIGNATURES		DATE	REVISIONS	
DRAWN: JOSEPH HAUER		08-20-2013	NATIONAL AERONAUTICS AND SPACE ADMINISTRATION	
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SUBMITTED ARCHIVING OF RECORD:			KENNEDY SPACE CENTER, FLORIDA	
KEVIN HARRIS			LAUNCH COMPLEX 39	
ST OF LICENSURE: FL			VEHICLE ASSEMBLY BUILDING	
LICENSE NO:			MODIFY VEHICLE ASSEMBLY BUILDING	
APPROVED:			HIGH BAY 3 FOR SLS - HOISTS	
JOHN KERCSMAR			LEVEL 36 - ELECTRICAL PLAN	
MIKE HARTNETT				
FILE NO.	302-6058-043	SIZE	DWG. NO.	REV
PROJ. NO.	PCN	99000.5	79K39667	
		SHEET 38 OF		

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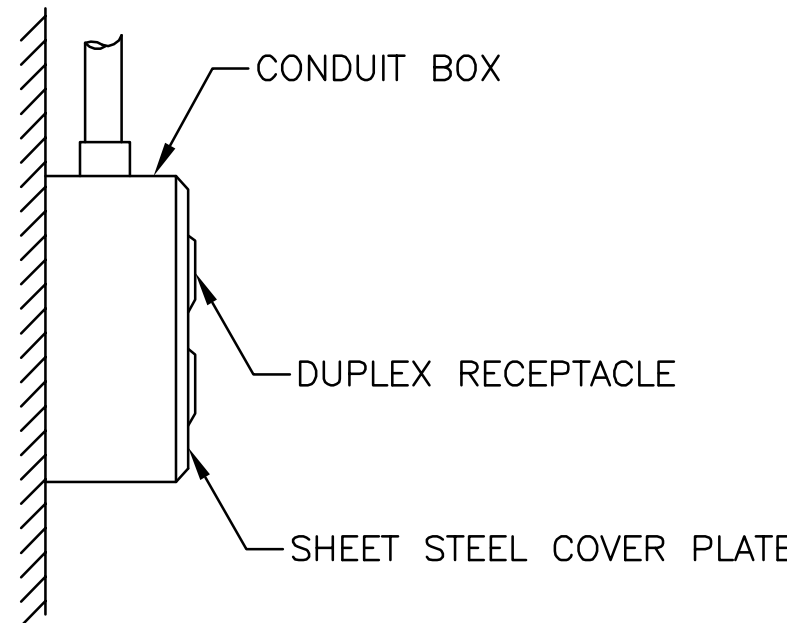


LUMINAIRE REQUIREMENTS:

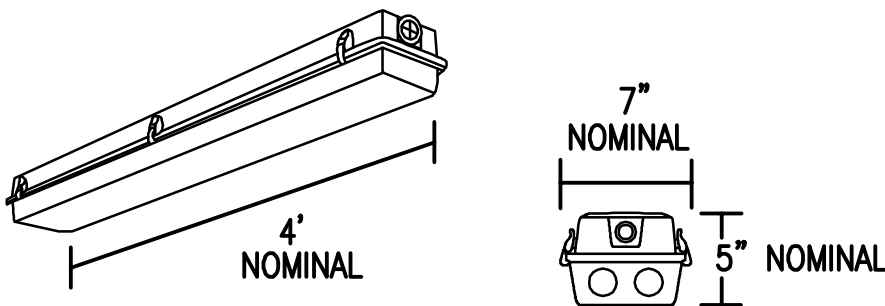1. HOUSING - ONE-PIECE, IMPACT-RESISTANT, FIBERGLASS REINFORCED POLYESTER WITH ENCLOSED COLD-ROLLED STEEL WIREWAY.
2. FINISH - STEEL REFLECTOR WITH MULTI-STAGE PHOSPHATE BONDING TREATMENT FINISHED WITH HIGH REFLECTANCE (MINIMUM 85%), BAKED WHITE ENAMEL FINISH.
3. LENS - 100% CLEAR ACRYLIC/DR OPTICAL DIFFUSER. STIPPLED INTERIOR SURFACES AND SMOOTH EXTERIOR. CLOSED CELL NEOPRENE GASKET WITH CAPTIVE NONMETALLIC, SNAP ACTION CAM LATCHES TO SECURE LENS TO HOUSING.
4. LAMPS - LINEAR FLUORESCENT T5, WITH (2) 28W LAMPS.
5. BALLAST - CLASS P, THERMALLY-PROTECTED, HIGH POWER FACTOR (.95), ELECTRONIC TYPE WITH SOUND RATING A. SEE SPECIFICATION OR LIGHTING FIXTURE SCHEDULE FOR BALLAST OPTIONS AND SPECIFICS.
6. CERTIFICATION - UL LISTED AND LABELED. SUITABLE FOR DAMP OR WET LOCATION AS DESIGNATED IN LIGHTING FIXTURE SCHEDULE.
7. INSTALLATION - SURFACE CEILING MOUNTING OR SUSPENDED MOUNTED AT 9'-0" AFF.

TYPE A: WET LOCATION INDUSTRIAL FLUORESCENT


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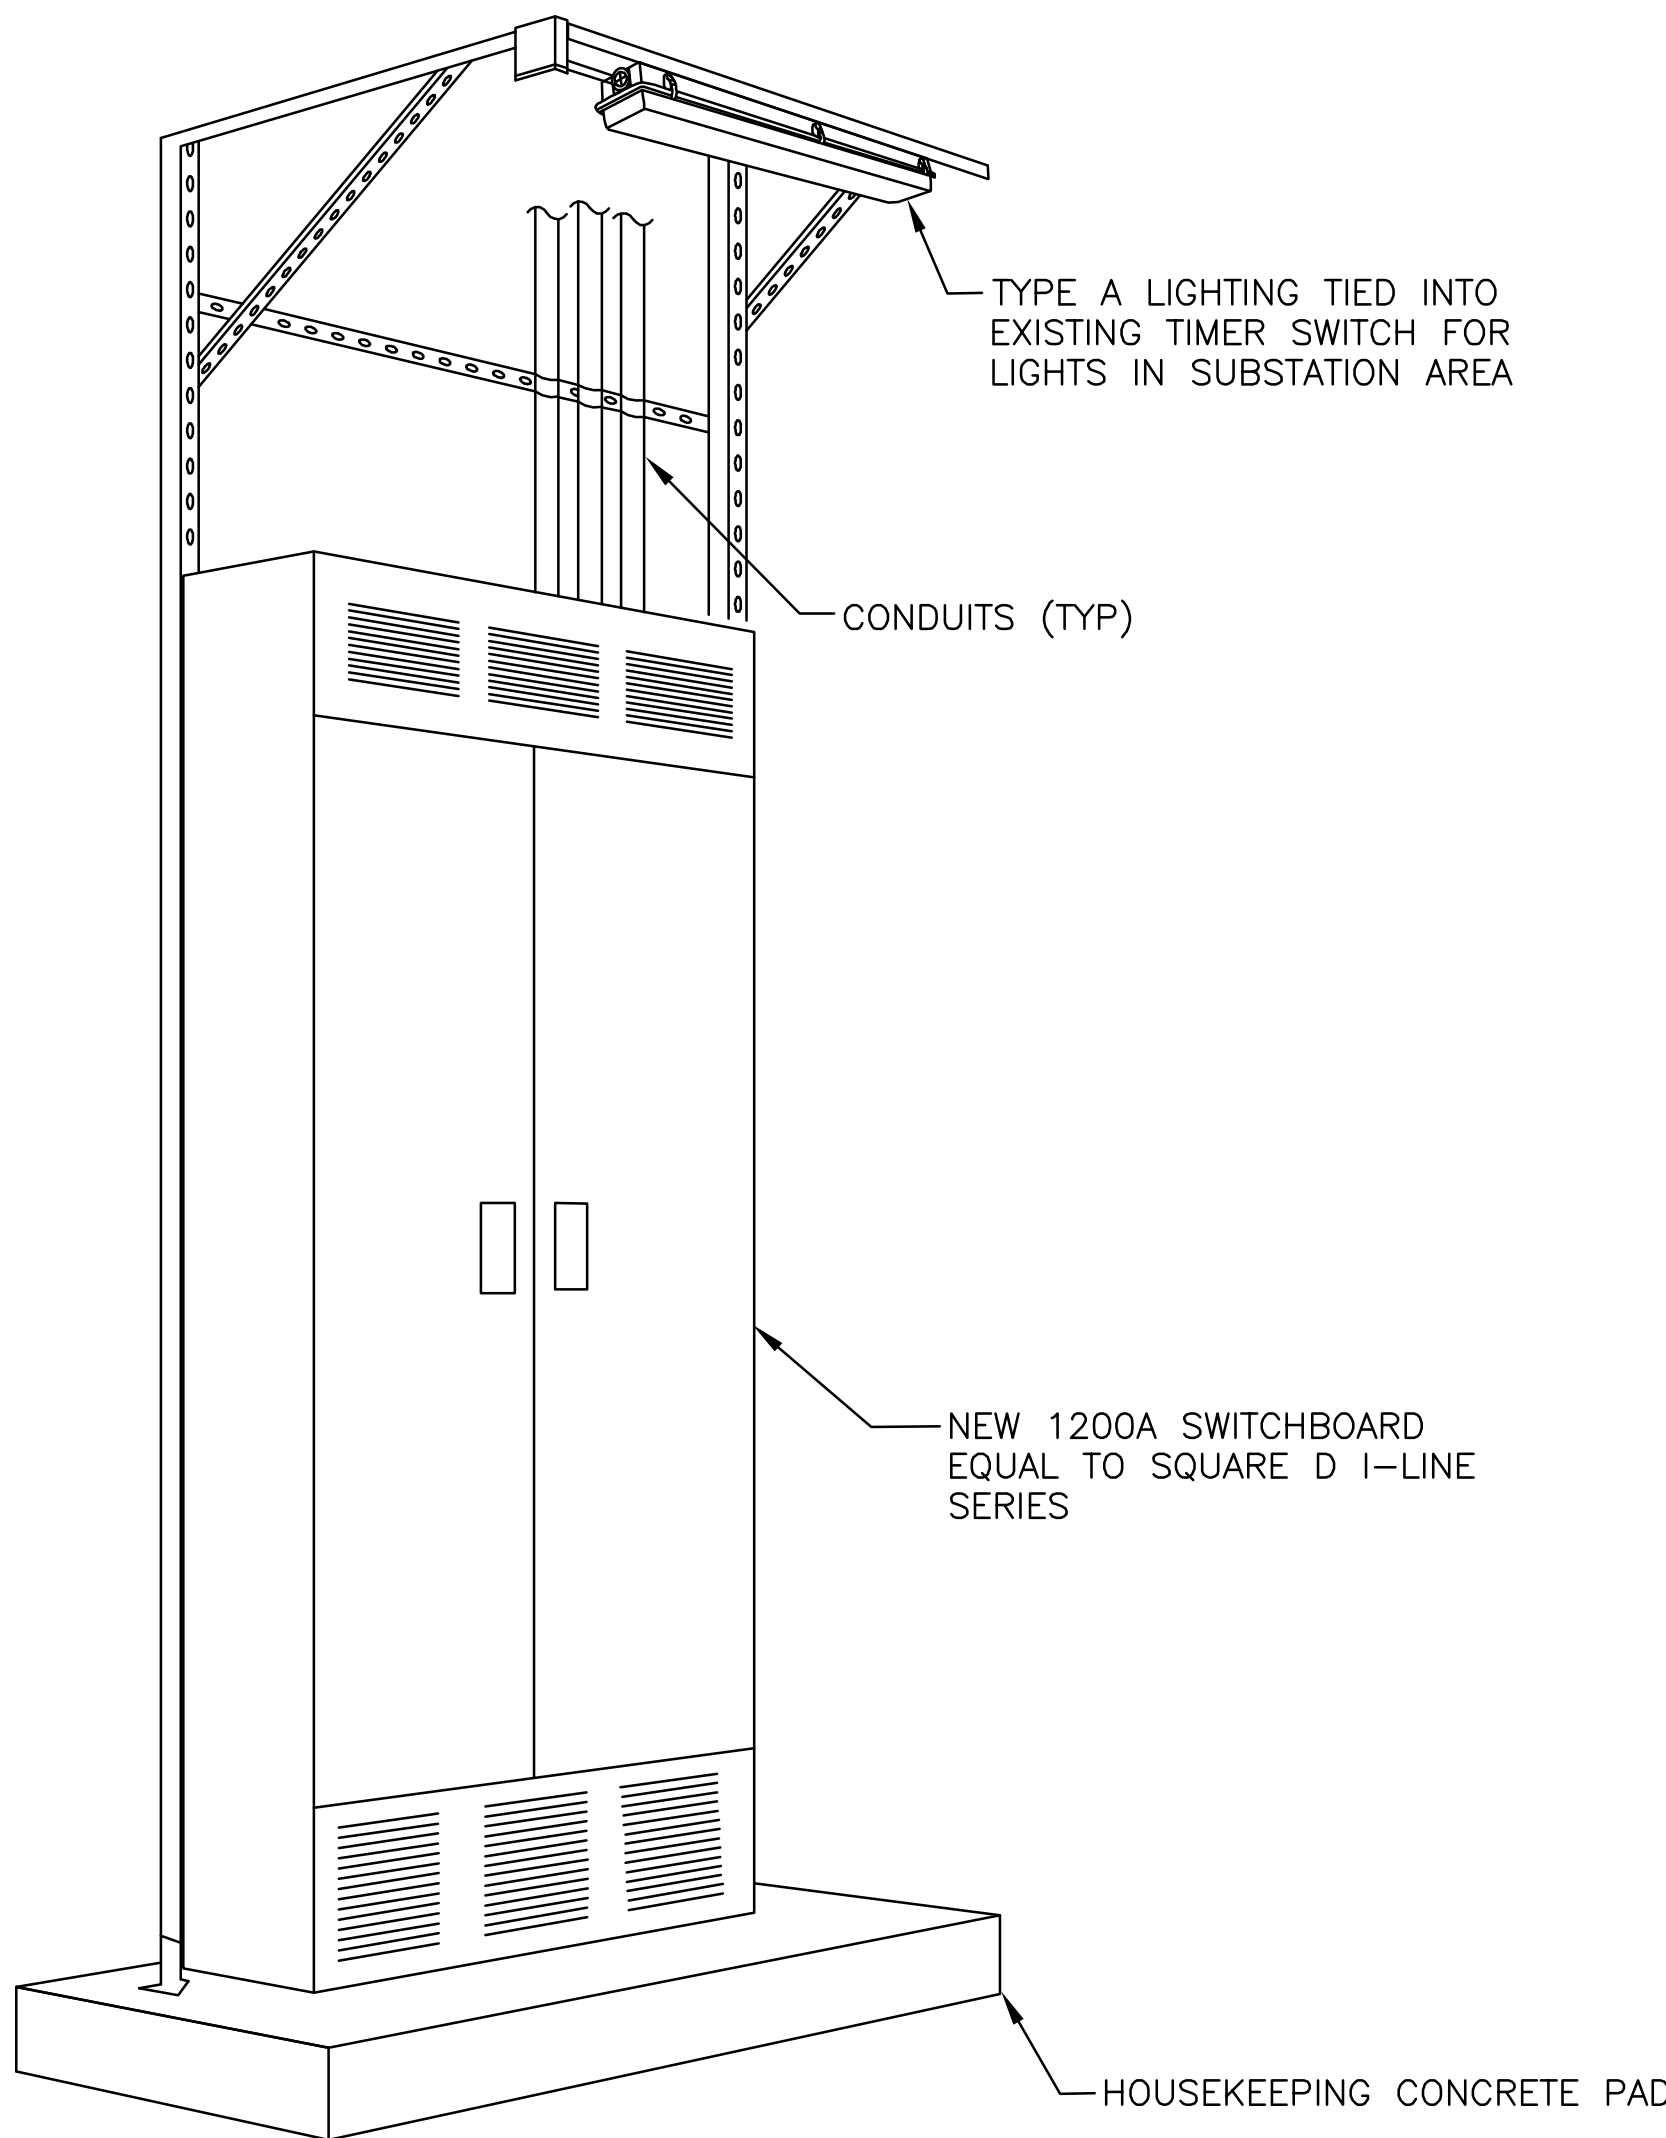
SIDE VIEW

TYPICAL RECEPTACLE SURFACE MOUNTING

SCALE: NTS




FRONT VIEW

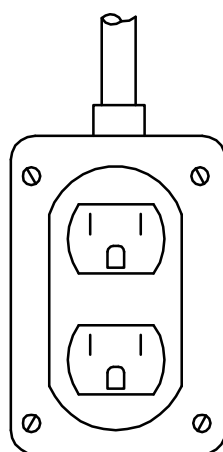


TYPICAL SWITCHBOARD MOUNTING DETAIL

SCALE: NTS

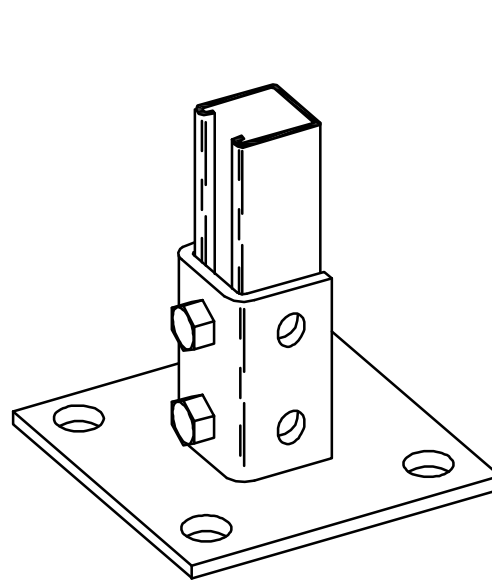

POST BASE FITTING

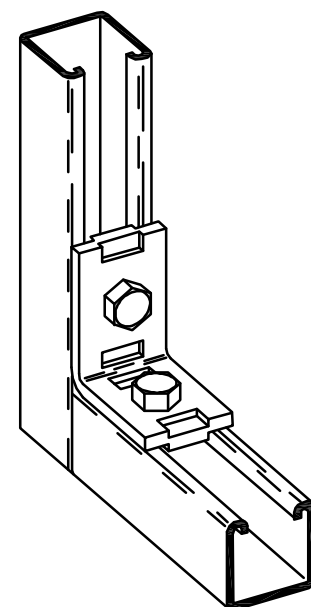

90 DEGREE ANGLE FITTING

TYPICAL STRUT SYSTEM FITTINGS



SCALE: NTS

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E-580

SYM	ZONE	DESCRIPTION	DATE	APPROVAL
REVISIONS				
SIGNATURES		DATE	REVISIONS	
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CHECKED: DANIEL VIGANT		08-20-2013	JOHN F. KENNEDY SPACE CENTER, NASA	
SUBMITTED ARCHIVING OF RECORD:			KENNEDY SPACE CENTER, FLORIDA	
KEVIN HARRIS			LAUNCH COMPLEX 39	
ST OF LICENSURE: FL			VEHICLE ASSEMBLY BUILDING	
LICENSE NO:			MODIFY VEHICLE ASSEMBLY BUILDING	
APPROVED:			HIGH BAY 3 FOR SLS - HOISTS	
JOHN KERCSMAR			ELECTRICAL DETAILS	
MIKE HARTNETT				
FILE NO.	302-6058-043	SIZE	DWG. NO.	REV
PROJ. NO.	PCN	99000.5	79K39667	
			SHEET	39 OF

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TOWER F - SS811 PARTIAL SINGLE-LINE DIAGRAM
SCALE: NTS

FEEDER SCHEDULE						
FEEDER #	CABLING		SOURCE		LOAD	
	TYPE	DESCRIPTION	CIRCUIT	LOCATION	DESCRIPTION	LOCATION
1	THWN	2 SETS - (3) #350, (1) #1G IN 3"C	SWBD 32EPA1-22	FLOOR 32 - TOWER E	PLATFORM HOIST CONTROLLER	FLOOR 34 - TOWER E
2	THWN	(3) #3/0, (1) #6G IN 2"C	SWBD 32EPA1-27	FLOOR 32 - TOWER E	ELEVATOR HOIST CONTROLLER	FLOOR 36 - TOWER E
3	VFD RATED	(3) #1, (1) #6G IN 1-1/4"C	PLATFORM HOIST CONTROLLER	FLOOR 34 - TOWER E	PLATFORM HOIST MOTOR	FLOOR 34 - TOWER E
4	VFD RATED	(3) #6, (1) #10G IN 1"C	ELEVATOR HOIST CONTROLLER	FLOOR 36 - TOWER E	ELEVATOR HOIST MOTOR	FLOOR 36 - TOWER E
5	THWN	2 SETS - (3) #350, (1) #1G IN 3"C	SS811-5A	FLOOR 32 - TOWER F	PLATFORM HOIST CONTROLLER	FLOOR 32 - TOWER F
6	THWN	(3) #3/0, (1) #6G IN 2"C	SS811-6A	FLOOR 32 - TOWER F	ELEVATOR HOIST CONTROLLER	FLOOR 36 - TOWER F
7	VFD RATED	(3) #1, (1) #6G IN 1-1/4"C	PLATFORM HOIST CONTROLLER	FLOOR 32 - TOWER F	PLATFORM HOIST MOTOR	FLOOR 32 - TOWER F
8	VFD RATED	(3) #6, (1) #10G IN 1"C	ELEVATOR HOIST CONTROLLER	FLOOR 36 - TOWER F	ELEVATOR HOIST MOTOR	FLOOR 36 - TOWER F
9	THWN	4 SETS - (3)#350, (1) #3/0G IN 3"C	SS809-4A	FLOOR 32 - TOWER E	SWBD 32EPA1	FLOOR 32 - TOWER E
NOTES: 1. PROVIDE RACEWAY SIZED FOR HOIST MANUFACTURER VFD MOTOR AND CONTROL CABLING.						

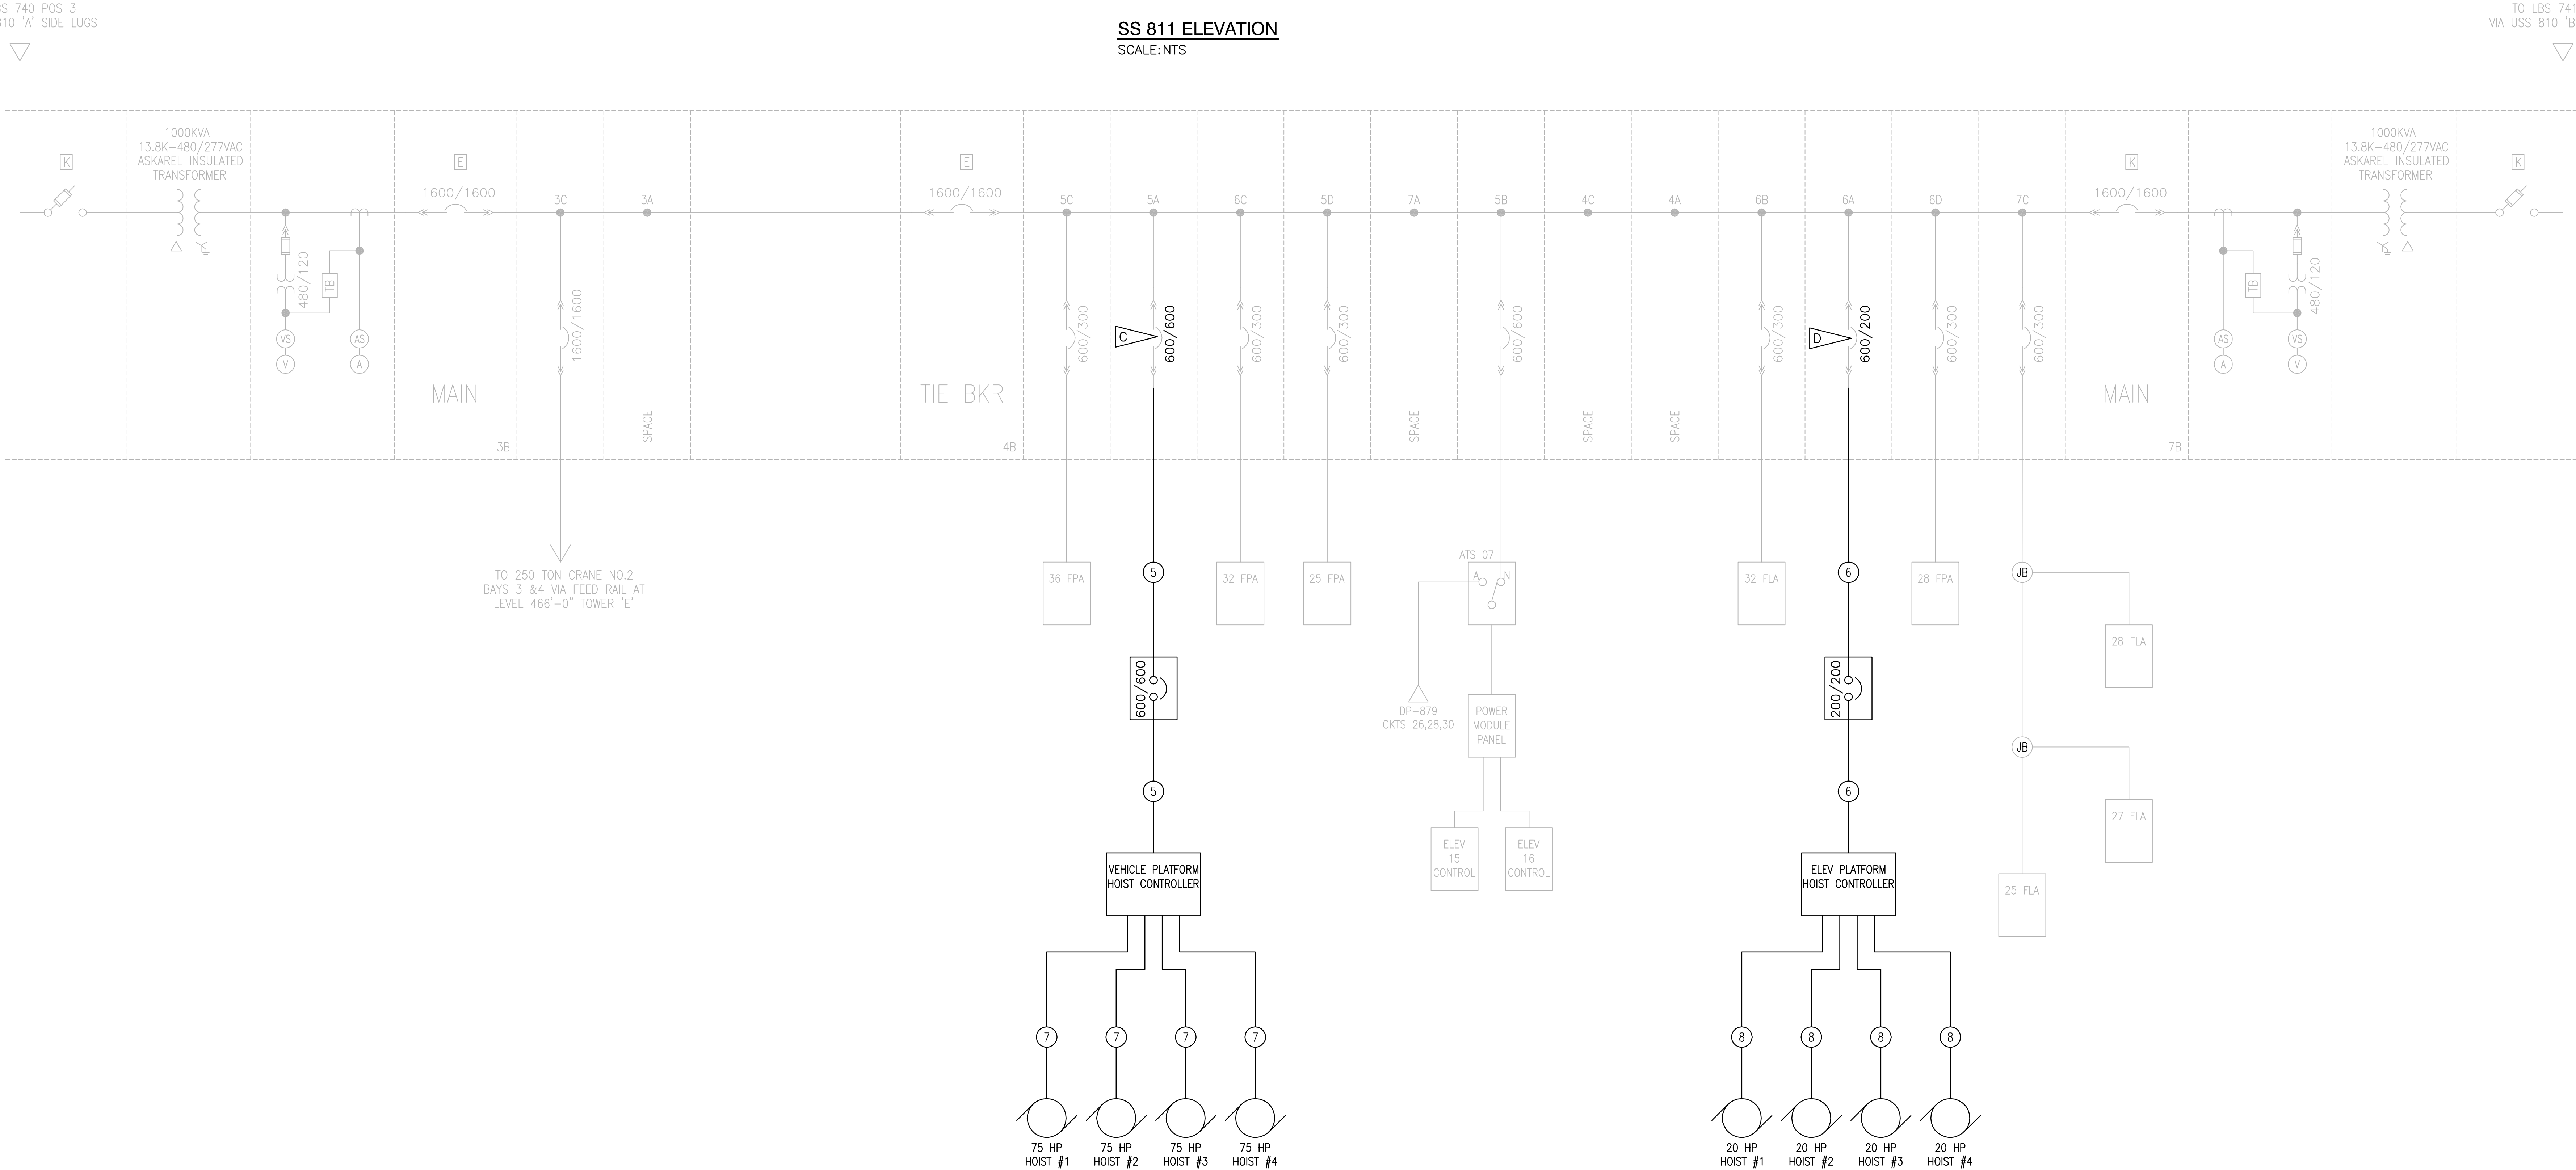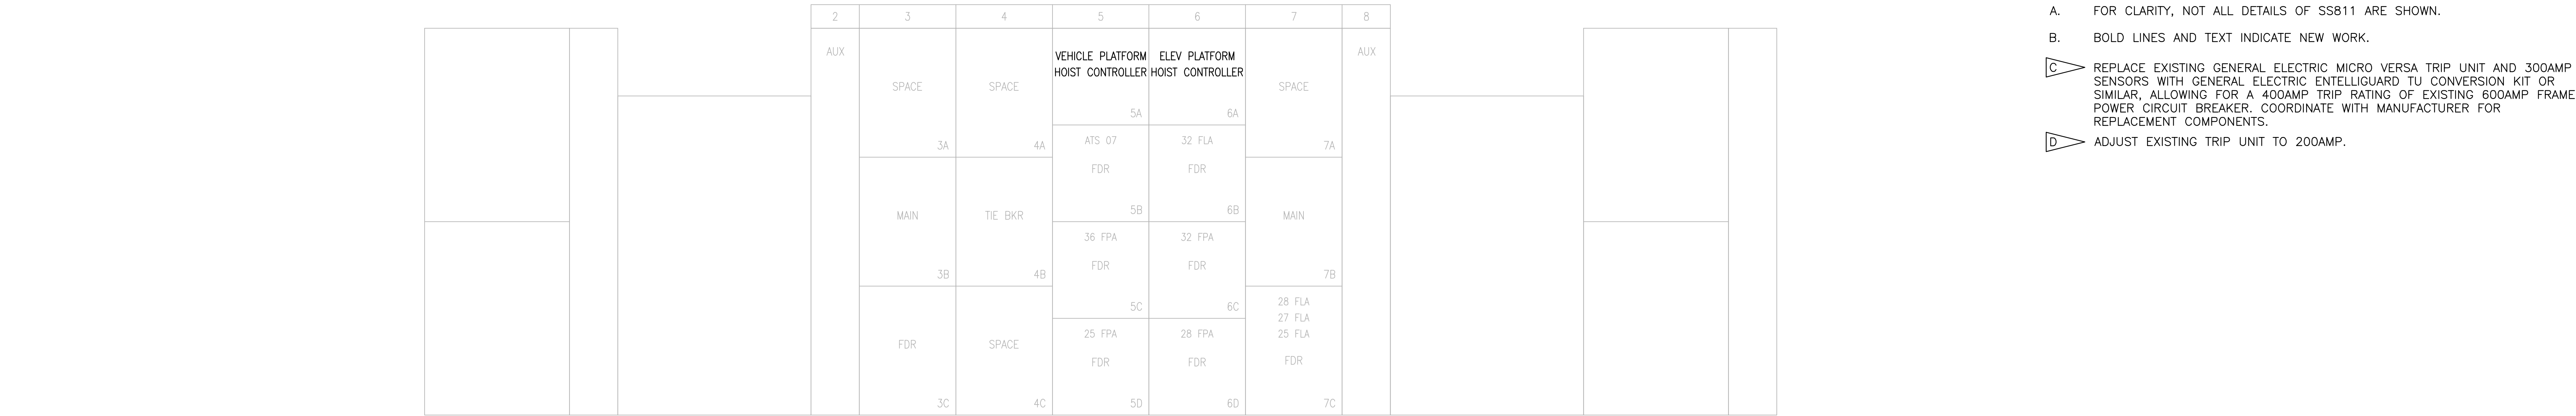- SPECIFIC NOTES:**
- A. FOR CLARITY, NOT ALL DETAILS OF SS811 ARE SHOWN.
- B. BOLD LINES AND TEXT INDICATE NEW WORK.
- C. REPLACE EXISTING GENERAL ELECTRIC MICRO VERSA TRIP UNIT AND 300AMP SENSORS WITH GENERAL ELECTRIC ENTELLIGUARD TU CONVERSION KIT OR SIMILAR, ALLOWING FOR A 400AMP TRIP RATING OF EXISTING 600AMP FRAME POWER CIRCUIT BREAKER. COORDINATE WITH MANUFACTURER FOR REPLACEMENT COMPONENTS.
- D. ADJUST EXISTING TRIP UNIT TO 200AMP.

WHEN PRINTED FULL SIZE, THIS SHEET IS 34"x44"
THIS COMPUTER DRAWING WAS
CREATED IN AUTOCAD AND
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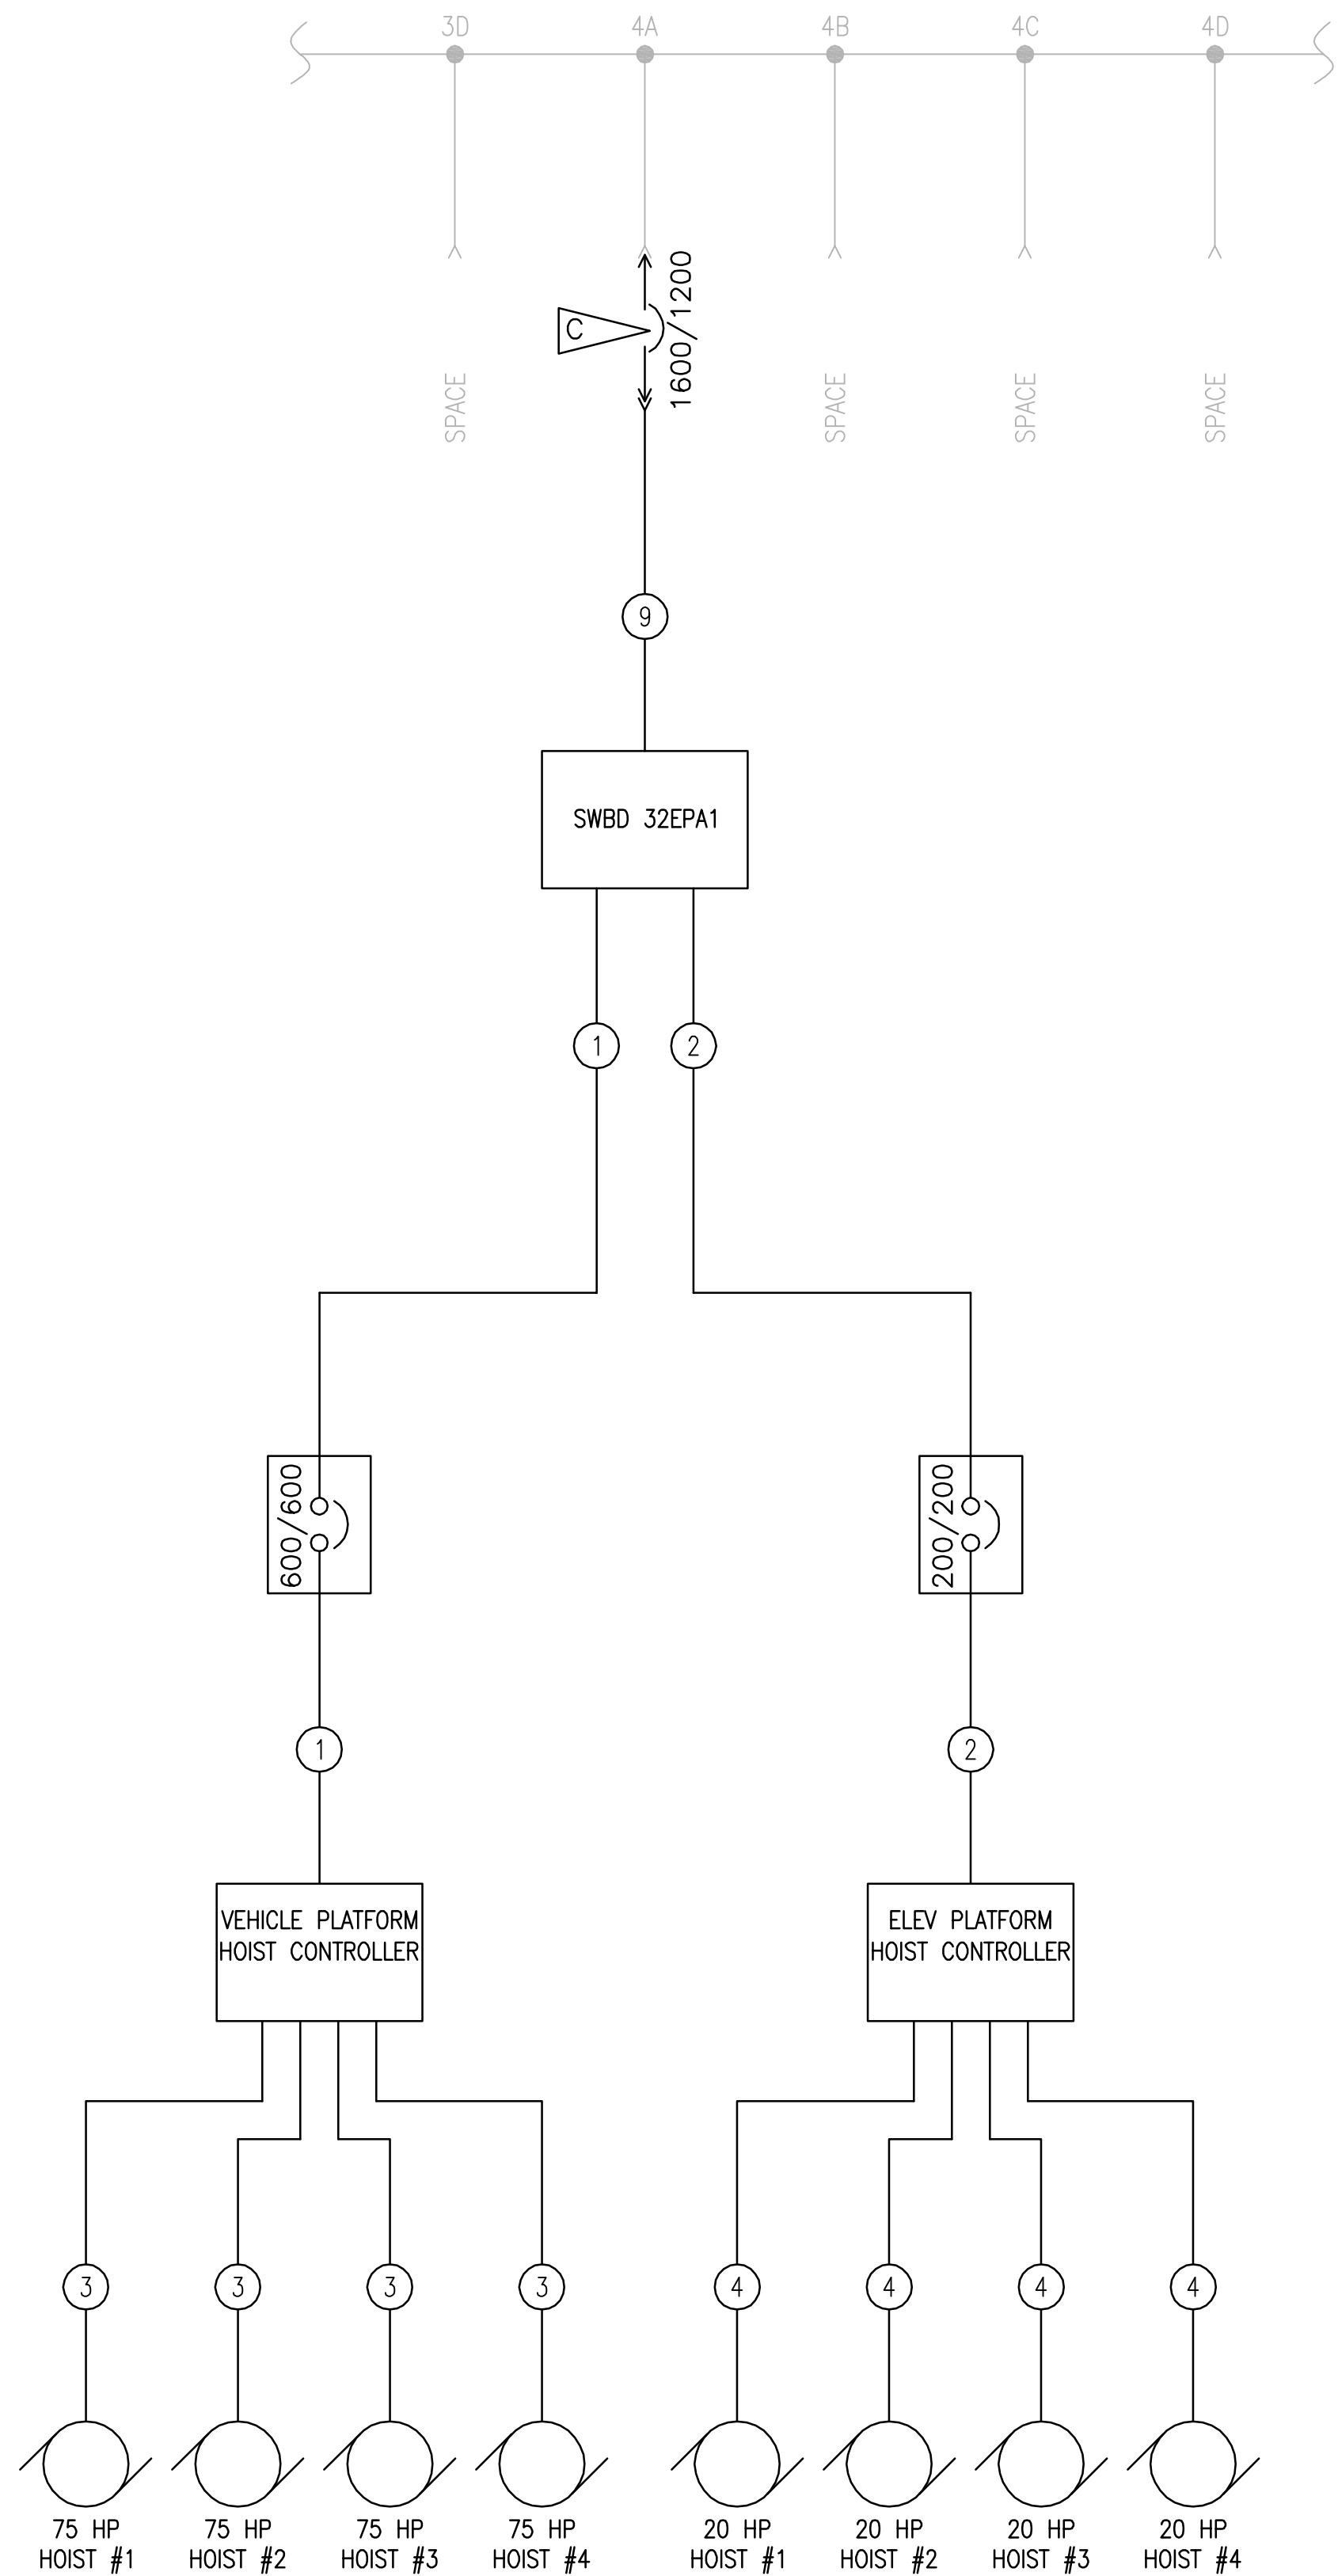
E-600

SYM	ZONE	DESCRIPTION	DATE	APPROVAL
REVISIONS				
		RS&H IMPROVING YOUR WORLD		
		Reynolds, Smith and Hills, Inc. 115 Alma Blvd, Suite 101 Merritt Island, Florida 32953-4101 (321) 453-0212 (321) 453-0223 FAX www.rsandh.com		
SIGNATURES		NATIONAL AERONAUTICS AND SPACE ADMINISTRATION		
DRAWN: JOSEPH HAUER		JOHN F. KENNEDY SPACE CENTER, NASA KENNEDY SPACE CENTER, FLORIDA		
CHECKED: DANIEL VIGANT		LAUNCH COMPLEX 39		
SUBMITTED ARCHIVING OF RECORD		VEHICLE ASSEMBLY BUILDING		
KEVIN HARRIS		MODIFY VEHICLE ASSEMBLY BUILDING		
ST OF LICENSE: FL		HIGH BAY 3 FOR SLS - HOISTS		
LICENSE NO:		POWER ONE-LINE - DIAGRAM 1		
APPROVED:				
JOHN KERCSMAR				
MIKE HARTNETT				
FILE NO.		SIZE		REV
302-6058-043		E		79K39667
PROJ. NO.		PCN	99000.5	SHEET 40 OF

NOTICE - WHEN GOVERNMENT DRAWINGS, SPECIFICATIONS, OR OTHER DATA ARE USED FOR ANY PURPOSE OTHER THAN IN CONNECTION WITH A SPECIFICALLY RELATED GOVERNMENT PROCUREMENT OPERATION, THE UNITED STATES GOVERNMENT THEREBY WAIVES ITS REQUIREMENT THAT ANY INVENTION, INVENTORSHIP, AND THE PATENT RIGHT THEREIN BE MADE AVAILABLE TO THE GOVERNMENT AND THAT THE GOVERNMENT MAY HAVE FORFEITED THE RIGHT TO SUE FOR INFRINGEMENT OF ANY PATENT RIGHTS IN ANY INVENTION, INVENTORSHIP, OR OTHER DATA IS NOT TO BE RECOVERED BY IMPLICATION OR OTHERWISE IN ANY MANNER EXCEEDING THE RIGHTS OF ANY OTHER PERSONS OR CORPORATION, OR CONVEYING ANY RIGHT OF PERMISSION TO MANUFACTURE, USE, OR SELL ANY PATENTED INVENTION THAT IS ANY PART OF THE RELATED INVENTION.

1	2	3	4	5	6	7	8	9	10
METERING A 1A	MTS #6 ELEV #11/12/17 2A	PANELS 31EPA/32EPA 3A	SWBD 32EPA1 C 4A	CTRL PWR SW 5A	PLC	MCC 41E1 MCC 41E2 7A	SPACE 8A	PANEL 41ELA 9A	METERING B 10A
MAIN BKR A 1B	PANELS 34EPA/36EPA 2B	PANELS 22EPA/24EPA 3B	SPACE 4B	TIE BKR 5B		PANELS 30ELA/31ELA 32ELA 7B	PANEL 28EPA 8B	PANELS 34ELA/36ELA 9B	MAIN BKR B 10B
CPT 1C	SPACE 2C	PANELS 25ELA/26ELA 27ELA/28ELA 3C	SPACE 4C	UPS 5C		MTS #5 ELEV #13/14 7C	PANEL 42E4 8C	PANELS 22ELA/24ELA 9C	CPT 10C
RECEPT CM-MAIN A 1D	SPACE 2D	SPACE 3D	SPACE 4D	SPACE 5D		PANEL BOARD 7D	PANELS 25EPA/27EPA 8D	SPACE 9D	RECEPT CM-MAIN B 10D

SS 809 ELEVATION
SCALE:NTS



TOWER E - SS809 PARTIAL SINGLE-LINE DIAGRAM
SCALE:NTS

SPECIFIC NOTES:

- A. CONNECTION OF LOAD SHOWN FOR PLATFORM INTERFACE IS NOT IN CONTRACT. PROVIDE ALL BRANCH CIRCUIT BREAKERS AS SHOWN. WHERE LOADS ARE NOT CONNECTED, LABEL BREAKERS AS SPARE.
- B. BOLD LINES AND TEXT INDICATE NEW WORK.
- C. PROVIDE 1600AF SQUARE D MASTERPACT POWER CIRCUIT BREAKER TO BE INSTALLED IN EXISTING AVAILABLE SWITCHGEAR CELL 4A AS INDICATED. INCLUDE MICROLOGIC TRIP UNIT WITH POWER CIRCUIT BREAKER WITH ADJUSTABLE LSIIG. AIC RATING TO BE PROVIDED TO MAINTAIN EXISTING EQUIPMENT RATING.
- D. SEE SHEET E-600 FOR FEEDER SCHEDULE.
- E. FOR CLARITY, NOT ALL DETAILS OF SS809 ARE SHOWN.

480... VOLTS SURFACE MOUNT 1200 AMP BUS										3 PHASE 3 WIRE 1200 MOB (TOP)										SWBD 32EPA1										LOCATION: TOWER E-FLOOR 32 FED FROM: SS809-4A ENCLOSURE: NEVA 1									
OKT	TRIP	PHASE	NEUTRAL	GND	COND	DEMAND				KVA	NOTES	LOAD	A	B	C	LOAD	NOTES	KVA	DEMAND				COND	GND	NEUTRAL	PHASE	TRIP	OKT											
						HVAC	LGTS	RECP	GEN										HVAC	LGTS	RECP	GEN																	
1									X	17.1	A	PLATFORM INTERFACE - FLOOR 32 (TOWER E)	X				A	17.1			X						2												
3	200	#3/0	---	#6	2"				X	17.1				X							17.1			X	2"	#6	---	#3/0	200	4									
5									X	17.1				X					17.1			X					6												
7										17.1			X						17.1			X					8												
9	200	#3/0	---	#6	2"				X	17.1	A	PLATFORM INTERFACE - FLOOR 28 (TOWER E)	X				A	17.1			X	2"	#6	---	#3/0	200	10												
11									X	17.1					X						17.1			X					12										
13									X	17.1			X						17.1			X					14												
15	200	#3/0	---	#6	2"				X	17.1	A	PLATFORM INTERFACE - FLOOR 24 (TOWER E)	X				A	17.1			X	2"	#6	---	#3/0	200	16												
17									X	17.1					X						17.1			X					18										
19									X	17.1			X						17.1			X					20												
21	200	#3/0	---	#6	2"				X	17.1	A	PLATFORM INTERFACE - FLOOR 20 (TOWER E)	X				1	96.0			X	3"	#1	---	(2)350	600	22												
23									X	17.1					X						96.0			X					24										
25									X	29.0			X								X						26												
27	200	#3/0	---	#6	2"				X	29.0	1	ELEVATOR HOIST CONTROLLER (TOWER E)	X														28												
29									X	29.0					X														30										
31													X														32												
33													X														34												
35													X														36												
37													X														38												
39													X														40												
41													X									1"	#6	---	#6	60	42												
Notes: 1 PROVIDED UNDER 79K39667													NEC 220.51 100% EST DEMAND LOAD HVAC (KVA):				0.0 PHASE A CONNECTED LOAD (KVA):				244.7																		
													NEC 220.42 for All others 100% EST DEMAND LOAD LGTS (KVA):				0.0 PHASE B CONNECTED LOAD (KVA):				244.7																		
													NEC 220.44 (0-10KVA@100%, X>10KVA@50%) EST DEMAND LOAD RECP (KVA):				0.0 PHASE C CONNECTED LOAD (KVA):				244.7																		
													DEMAND FACTOR OF 50% 50% EST DEMAND LOAD GEN (KVA):				367.1 TOTAL CONNECTED LOAD (KVA):				734.1																		
													TOTAL ESTIMATED DEMAND LOAD (KVA):				367.1				TOTAL CONNECTED LOAD (AMPS):				883.0														

SYM	ZONE	DESCRIPTION	DATE	APPROVAL
REVISIONS				
SIGNATURES		DATE	NATIONAL AERONAUTICS AND SPACE ADMINISTRATION	
DRAWN: JOSEPH HAUER	08-20-2013		JOHN F. KENNEDY SPACE CENTER, NASA	
CHECKED: DANIEL VIGANT	08-20-2013		KENNEDY SPACE CENTER, FLORIDA	
SUBMITTED ARCHIVING OF RECORD			LAUNCH COMPLEX 39	
KEVIN HARRIS			VEHICLE ASSEMBLY BUILDING	
ST OF LICENSEURE: FL			MODIFY VEHICLE ASSEMBLY BUILDING	
LICENSE NO:			HIGH BAY 3 FOR SLS - HOISTS	
APPROVED:			POWER ONE-LINE - DIAGRAM 2	
JOHN KERCSMAR			FILE NO. 302-6058-043	SIZE E
MIKE HARTNETT			DWG NO. 79K39667	REV
PROJ. NO. PCN 99000.5		SHEET 41 OF		

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FILED UNDER THE DRAWING NUMBER

E-601

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[illegible]

1. PANEL 36FPA PROVIDED UNDER #79K39289.

120/208V _{LL} VOLTS						3 PHASE						PANEL 32EEB										LOCATION: TOWER E - 32ND FL					
SURFACE MOUNT						4 WIRE						GE NLAB										FED FROM: ESS-879 OCT 9					
225 AMP BUS						200 MCB (BOTTOM)																ENCLOSURE: NEMA 1					
OCT	TRIP	PHASE	NEUTRAL	GND	COND	DEMAND				KVA	NOTES	LOAD			NOTES	KVA	DEMAND				COND	GND	NEUTRAL	PHASE	TRIP	OCT	
						HVAC	LGTS	REC'D	GEN			A	B	C			HVAC	LGTS	REC'D	GEN							
1	20	#12	#12		3/4"	X						LTG-E STAIRS FL 20-31	X				LTG-W STAIRS FL 20-31	X				3/4"	#12	#12	20	2	
3	20	#12	#12		3/4"	X						LTG-W STAIRS, EXIT FL 20-41	X				LTG-E STAIRS, EXIT FL 20-31	X				3/4"	#12	#12	20	4	
5	20	#12	#12		3/4"	X						LTG-W STAIRS FL 20-30		X			LTG-E STAIRS FL 19-31	X				3/4"	#12	#12	20	6	
7	20	#12	#12		3/4"	X						LTG-W STAIRS FL 32-42	X				LTG-E STAIRS FL 32-42	X				3/4"	#12	#12	20	8	
9	20	#12	#12		3/4"	X						LTG-W STAIRS FL 32-41		X			LTG-E STAIRS FL32-40	X				3/4"	#12	#12	20	10	
11	20	#12	#12		3/4"	X						LTG-W STAIRS, EXIT FL 32		X			LTG-E STAIRS, EXIT FL 32-41	X				3/4"	#12	#12	20	12	
13	20	#12	#12		3/4"	X						LTG-CATWALK EXT PLAT A FL 2	X				LTG-CATWALK EXT PLAT A FL 2	X				3/4"	#12	#12	20	14	
15	20	#12	#12		3/4"	X						LTG-CATWALK EXT PLAT B FL 2	X				LTG-CATWALK EXT PLAT B FL 2	X				3/4"	#12	#12	20	16	
17	20	#12	#12	#12	3/4"	X			0.7			REC'D: SUBSTA AND HOIST AREA		X			LTG-MACH RM, ELEV 17 PH	X				3/4"	#12	#12	20	18	
19	20	#12	#12		1/2"		X					REC'D: SUBSTA AREA	X				PA-BASE RM 28E1 NET A		X		1/2"	#12	#12	20	20		
21	20											SPARE		X			PA-BASE RM 24E1 NET A			X	1/2"	#12	#12	20	22		
23	20	#12	#12		3/4"	X						LTG-EMER FL 37	X		X		LTG-CATWALK EXT PLAT C FL 2	X				3/4"	#12	#12	20	24	
25	20	#12	#12		1-1/2"	X						LTG-EMER SUBSTA AREA	X				FA-I-J-BOX			X	1-1/4"	#10	#10	20	26		
27	20	#10	#10		1-1/4"							FA-BOX 3 FL 32		X			FA-BOX 1 FL 32			X	1-1/4"	#10	#10	20	28		
29	20	#10	#10		1-1/4"		X					FA-BOX 3 FL 32		X			FA-BOX 1 FL 32			X	1-1/4"	#10	#10	20	30		
31	20											SPARE	X				SPARE							20	32		
33	20	#10	#10	#10	3/4"	X			0.5			BM LTG HOIST MAINT PLATFORMS	X				SPARE							20	34		
35												SPACE		X			SPARE							20	36		
37												SPACE	X				SPARE							20	38		
39												SPACE		X			SPARE							20	40		
41												SPACE		X			SPARE							20	42		
Notes:												NEC 220.51		100%	EST DEMAND LOAD HVAC (KVA):		0.0		PHASE A CONNECTED LOAD (KVA):		0.0						
												NEC 220.42 for All others		100%	EST DEMAND LOAD LGTS (KVA):		0.5		PHASE B CONNECTED LOAD (KVA):		0.5						
												NEC 220.44 (0-10KVA@100%, X>10KVA@50%)		0.7	EST DEMAND LOAD REC'D (KVA):		0.7		PHASE C CONNECTED LOAD (KVA):		0.7						
												NEC 220.14		100%	EST DEMAND LOAD GEN (KVA):		0.0		TOTAL CONNECTED LOAD (KVA):		1.2						
												TOTAL ESTIMATED DEMAND LOAD (KVA):				1.2		TOTAL CONNECTED LOAD (AMPS):				3.4					

120/208 : VOLTS										3 PHASE		PANEL 32FLB										LOCATION: TOWER F - RM32F VAB									
SURFACE MOUNT										4 WIRE												FED FROM: 32FPA CKT 9									
225 AMP BUS										200 MCB (BOTTOM)												ENCLOSURE: NEMA 1									
QKT	TRIP	PHASE	NEUTRAL	GND	COND	DEMAND				KVA	NOTES	LOAD	A	B	C	LOAD	NOTES	KVA	DEMAND				COND	GND	NEUTRAL	PHASE	TRIP	QKT			
						HVAC	LGTS	REC'D	GEN										HVAC	LGTS	REC'D	GEN									
1	20	#12	#12	#12	1/2"	X						LTO-RM 228FL AND UTIL SHAFT	X				SPACE									20	2				
3	20	#12	#12	#12	1/2"		X					RECTP-FM32F1		X			RECTP-CLEANING, 120V			X		3/4"	#12	#10	#10	20	4				
5	20	#12	#12	#12	3/4"		X					LTO-CATWALK, 31F1			X		RECTP-CLEANING, 208V				X	3/4"	#12		#10	20	6				
7	20	#12	#12	#12	3/4"			X				RECTP-CATWALK, 31F1	X							X					#10	20	8				
9	20	#12	#12	#12	3/4"		X					RECTP-MOVABLE PLATFORM	X				SPACE									20	10				
11	20	#10	#10	#10	3/4"			X		0.4		RECTP - HOIST MAINT PLAT - WEST	X	X		X	RECTP - HOIST MAINT PLAT - EAST		0.4		X		3/4"	#10	#10	#10	20	12			
13												SPACE	X				SPACE										14				
15												SPACE		X			SPACE										16				
17												SPACE			X		SPACE										18				
19												SPACE	X				SPACE										20				
21												SPACE		X			SPACE										22				
23												SPACE			X		SPACE										24				
25												SPACE	X				SPACE										26				
27												SPACE		X			SPACE										28				
29												SPACE			X		SPACE										30				
31												SPACE	X				SPACE										32				
33												SPACE		X			SPACE										34				
35												SPACE			X		SPACE										36				
37												SPACE	X				SPACE										38				
39												SPACE		X			SPACE										40				
41												SPACE			X		SPACE										42				
Notes:												NEC 220.51 100% EST DEMAND LOAD HVAC (KVA): 0.0 PHASE A CONNECTED LOAD (KVA): 0.0																			
												NEC 220.42 for All others 100% EST DEMAND LOAD LGTS (KVA): 0.0 PHASE B CONNECTED LOAD (KVA): 0.0																			
												NEC 220.44 (0-10KVA@100%, X>10KVA@50%) 50% EST DEMAND LOAD RECP (KVA): 0.7 PHASE C CONNECTED LOAD (KVA): 0.7																			
												NEC 220.14 100% EST DEMAND LOAD GEN (KVA): 0.0 TOTAL CONNECTED LOAD (KVA): 0.7																			
												TOTAL ESTIMATED DEMAND LOAD (KVA): 0.7 TOTAL CONNECTED LOAD (AMPS): 2.0																			

120/208V : VOLTS SURFACE MOUNT 225 AMP BUS												3 PHASE 4 WIRE 200 MCB (BOTTOM)												PANEL 34ELB GE NLAB												LOCATION: TOWER E - ELEC CLOSET 34TH FL. FED FROM: RNL 31EPA CKT 16 ENCLOSURE: NEMA 1																																																																																																																																																																																																																																																																																																																																																																																																																																																																																																																																																																																																																																																																																																																																																																																																																																																																																																																																																																																																																																																																																																																																																																																																																																																																																																																																																																																																																																																																																																																																																																																																																																		
OKT		TRIP		PHASE		COND		GND		120"		1/2"		HVAC		LGTS		REC'D		GEN		KVA		NOTES		LOAD			A			B			C			LOAD			NOTES		KVA		DEMAND		COND		GND		PHASE		TRIP		OKT																																																																																																																																																																																																																																																																																																																																																																																																																																																																																																																																																																																																																																																																																																																																																																																																																																																																																																																																																																																																																																																																																																																																																																																																																																																																																																																																																																																																																																																																																																																																																																																																															

277/480 V VOLTS SURFACE MOUNT 200 AMP BUS						3 PHASE 4 WIRE 200 MCB (TOP)		PANEL 36EPA AIC: 18,000A SQUARE D NF						LOCATION: TOWER E - 36TH FL FED FROM: SS-809 CKT 2B ENCLOSURE: NEMA 1												
CKT	TRIP	PHASE	NEUTRAL	GND	COND	HVAC LGTS	DEMAND RECP	GEN	KVA	NOTES	LOAD	A	B	C	LOAD	NOTES	KVA	HVAC LGTS	DEMAND RECP	GEN	COND	GND	NEUTRAL	PHASE	TRIP	CKT
1																										2
3	50									1	SPARE	X			SPARE	1										4
5													X													6
7		#10							X																	8
9	20	#10			1-1/4"				X		1	WATER PUMP 40TH FLOOR				WELDER	1									10
11		#10							X																	12
13		#12							X	1.3							1.3							#12		14
15	20	#12			3/4"				X	1.3		EAST SLING HOIST RECEPTACLE (L16-20 TWIST LOCK) LVL 35		X		WEST SLING HOIST RECEPTACLE (L16-20 TWIST LOCK) LVL 35		1.3				3/4"	#12	#12	20	16
17		#12							X	1.3				X			1.3							#12		18
19													X													20
21													X			SPACE										22
23														X												24
25													X													26
27														X												28
29														X												30
Notes:												NEC 220.51 100% EST DEMAND LOAD HVAC (KVA): 0.0 PHASE A CONNECTED LOAD (KVA): 2.7 NEC 220.42 for All others 100% EST DEMAND LOAD LGTS (KVA): 0.0 PHASE B CONNECTED LOAD (KVA): 2.7 NEC 220.44 (0-10KVA@100%, X>10KVA@50%) EST DEMAND LOAD RECP (KVA): 0.0 PHASE C CONNECTED LOAD (KVA): 2.7 NEC 220.14 100% EST DEMAND LOAD GEN (KVA): 8.0 TOTAL CONNECTED LOAD (KVA): 8.0 TOTAL ESTIMATED DEMAND LOAD (KVA): 8.0 TOTAL CONNECTED LOAD (AMPS): 9.6														
1. CIRCUITING PER 39K6150009, REV M.																										


277/480V - VOLTS SURFACE MOUNT 225 AMP BUS										3 PHASE 4 WIRE 200 MCB (BOTTOM)		PANEL 32FLA GE QMR2-CCB										LOCATION: TOWER F - CORRIDOR 32ND FLOOR FED FROM: USS-811 CKT 4D ENCLOSURE: NEMA 1									
CKT	TRIP	PHASE	NEUTRAL	GND	COND	HVAC LGTS	RECP	GEN	KVA	NOTES	A	B	C	LOAD	NOTES	KVA	HVAC LGTS	RECP	GEN	COND	GND	NEUTRAL	PHASE	TRIP	CKT						
1	20	#12	#12	#12	3/4"	X								LTG-FL 32 LOBBY, CORRIDOR																	
3	20	#12	#12	#12	3/4"	X							X	LTG-FL 32 EAST END TOWER			X			1/2"	#12	#12	#12	#12	20	2					
5	20	#12	#12	#12	3/4"	X							X	LTG-FL 36 ELEV LOBBY			X			1/2"	#12	#12	#12	#12	20	4					
7	20	#12	#12	#12	3/4"	X							X	LTG-FL 34 ELEV LOBBY			X			1/2"	#12	#12	#12	#12	20	6					
9	20	#12	#12	#12	3/4"	X							X	LTG-FL 34 EAST END TOWER			X			3/4"	#12	#12	#12	#12	20	8					
11	20	#12	#12	#12	3/4"	X							X	LTG-FL 34 ELEV LOBBY			X			1/2"	#12	#12	#12	#12	20	10					
13	20	#12	#12	#12	1/2"	X							X	LTG-FL 37 ELEV LOBBY			X			3/4"	#12	#12	#12	#12	20	12					
15	20	#10	#10	#10	3/4"	X			1.1				X	LTG-FL 37 EAST END TOWER											20	14					
17	20												X	LTG-FL 35/36 HOIST MAINT PLATS											20	16					
19													X	SPARE											20	18					
21													X	SPARE												20	20				
23													X	SPARE												20	22				
25													X	SPARE												20	24				
27													X	SPARE												20	26				
29													X	SPARE												20	28				
31													X	SPARE												20	30				
Notes:										NEC 220.51 100% EST DEMAND LOAD HVAC (KVA): 0.0 PHASE A CONNECTED LOAD (KVA): 0.0										NEC 220.42 for All others 100% EST DEMAND LOAD LGTS (KVA): 1.1 PHASE B CONNECTED LOAD (KVA): 1.1											
										NEC 220.44 (0-10KVA@100%, X-10KVA@50%) 0.0 EST DEMAND LOAD RECP (KVA): 0.0 PHASE C CONNECTED LOAD (KVA): 0.0										NEC 220.14 100% EST DEMAND LOAD GEN (KVA): 0.0 TOTAL CONNECTED LOAD (KVA): 1.1											
										TOTAL ESTIMATED DEMAND LOAD (KVA): 1.1										TOTAL CONNECTED LOAD (AMPS): 1.3											

120/208 : VOLTS SURFACE MOUNT 225 AMP BUS					3 PHASE 4 WIRE 200 MCB (BOTTOM)		PANEL 32FEB GE NLAB										LOCATION: TOWER F - SUBSTA A REA 32ND FL. FED FROM: USS-884 CKT 9 ENCLOSURE: NEMA 1									
CKT	TRIP	PHASE	NEUTRAL	GND	CON'D	HVAC LGTS RECP GEN	KVA	NOTES	LOAD			A	B	C	LOAD	NOTES	KVA	HVAC LGTS RECP GEN	COND	GND	NEUTRAL	PHASE	TRIP	CKT		
1	20	#12	#12		3/4"	X			LTG-W STAIRS FL 20,30		X				LTG-E STAIRS FL 32,34,40,EXIT			X	3/4"	#12	#12	#12	20	2		
3	20	#12	#12		3/4"	X			LTG-W STAIRS FL 22,26,27,28		X				LTG-E STAIRS FL 33,42			X	3/4"	#12	#12	#12	20	4		
5	20	#12	#12		3/4"	X			LTG-W STAIRS FL 20,30			X			LTG-E STAIRS FL 20,30			X	3/4"	#12	#12	#12	20	6		
7	20	#12	#12		3/4"	X			LTG-W STAIRS FL 31,41		X				LTG-E STAIRS FL 31,41			X	3/4"	#12	#12	#12	20	8		
9	20	#12	#12		3/4"	X			LTG-W STAIRS FL 31,41		X				LTG-E STAIRS FL 22,25,32,EXIT			X	3/4"	#12	#12	#12	20	10		
11	20	#12	#12		3/4"	X			LTG-W STAIRS FL 32,34,36,37,40			X			LTG-EXIT FL 21,31,32			X	3/4"	#12	#12	#12	20	12		
13	20	#12	#12		3/4"	X			LTG-EXTEND PLATFORM 27LB		X				RECP-T SUBSTA AND HOIST AREA		0.4	X	3/4"	#12	#12	#12	20	14		
15	20	#12	#12		3/4"	X			LTG-ELEV #15 CAB V/A J-BOX		X				RECP-T SUBSTA AREA			X	3/4"	#12	#12	#12	20	16		
17	20	#10	#10	#10	3/4"	X	0.5		BM LTG HOIST MAINT PLATS			X			SPARE									18		
19	20	#12	#12		3/4"	X			LTG-EXTEND PLATFORM 27LB		X				LTG-EMERG SUBSTA 811			X	3/4"	#12	#12	#12	20	20		
21	20	#12	#12		3/4"	X			LTG-EXTEND PLATFORM 25LB			X			SPARE									22		
23	20								SPARE			X			SPACE									24		
Notes:																										
NEC 220.51									100%			EST DEMAND LOAD HVAC (KVA):			0.0			PHASE A CONNECTED LOAD (KVA):			0.4					
NEC 220.42 for All others									100%			EST DEMAND LOAD LGTS (KVA):			0.5			PHASE B CONNECTED LOAD (KVA):			0.0					
NEC 220.44 (0-10KVA@100%, X>10KV A@50%)									100%			EST DEMAND LOAD RECP (KVA):			0.4			PHASE C CONNECTED LOAD (KVA):			0.5					
NEC 220.14									100%			EST DEMAND LOAD GEN (KVA):			0.0			TOTAL CONNECTED LOAD (KVA):			0.9					
												TOTAL ESTIMATED DEMAND LOAD (KVA):			0.9			TOTAL CONNECTED LOAD (AMPS):			2.4					

277/480 V: 3 PHASE SURFACE MOUNT 4 WIRE 200 AMP BUS 200 MCB (BOTTOM)										PANEL 36ELA AIC: 18,000A SQUARE D NF										LOCATION: TOWER E - 36TH FL FED FROM: USS-809 CKT 9B ENCLOSURE: NEMA 1									
CKT	TRIP	PHASE	NEUTRAL	GND	COND	HVAC LGTS	DEMAND RECP	GEN	KVA	NOTES	LOAD	A	B	C	LOAD	NOTES	KVA	HVAC LGTS	DEMAND RECP	GEN	COND	GND	NEUTRAL	PHASE	TRIP	CKT			
1	20	#12	#12	#12	3/4"	X					LTG-CATWALK, N & SE WALL, FL 37	X			LTG-FL 35&36 HOIST MAIN PLATS		1.1	X			3/4"	#10	#10	#10	20	2			
3	20	#12	#12	#12	1/2"	X					FLDT, E SLAB, FL 37	X			LTG-CORRIDOR 37TH FLOOR			X			1/2"	#12	#12	#12	20	4			
5	20										SPARE		X		LTG-CORR CATWALK-TWR B FL 40			X			1/2"	#12	#12	#12	20	6			
7	20	#12	#12	#12	1/2"	X					SPARE CKT-SUB ROOF	X			SPARE											20	8		
9	20	#12	#12	#12	1/2"	X					SPARE CKT-SUB ROOF	X			LTG-CORR 36TH FLOOR			X			1/2"	#12	#12	#12	20	10			
11	20										SPARE		X		SPARE											20	12		
13											SPACE	X			SPACE											14			
15											SPACE		X		SPACE											16			
17											SPACE			X	SPACE											18			
19											SPACE	X			SPACE											20			
21											SPACE		X		SPACE											22			
23											SPACE			X	SPACE											24			
25											SPACE	X			SPACE											26			
27											SPACE			X	SPACE											28			
29											SPACE		X		SPACE											30			
Notes:										NEC 220.51 100% EST DEMAND LOAD HVAC (KVA): 0.0 PHASE A CONNECTED LOAD (KVA): 1.1										NEC 220.42 for All others 100% EST DEMAND LOAD LGTS (KVA): 1.1 PHASE B CONNECTED LOAD (KVA): 0.0									
										NEC 220.44 (0-10KVA@100%, X=10KVA@50%) EST DEMAND LOAD RECP (KVA): 0.0 PHASE C CONNECTED LOAD (KVA): 0.0																			
										NEC 220.14 100% EST DEMAND LOAD GEN (KVA): 0.0 TOTAL CONNECTED LOAD (KVA): 1.1																			
										TOTAL ESTIMATED DEMAND LOAD (KVA): 1.1 TOTAL CONNECTED LOAD (AMPS): 1.3																			

PANEL INDEX	
36FPA	36EPA
32EEB	32FLA
32FLB	32FEB
34ELB	36ELA

WHEN PRINTED FULL SIZE, THIS SHEET IS 34"x44"
THIS COMPUTER DRAWING WAS
CREATED IN AUTOCAD AND
FILED UNDER THE DRAWING NUMBER

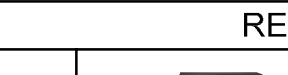
SYM	ZONE	DESCRIPTION	DATE	APPROVAL
<div style="text-align: center;"> REVISIONS </div>				
		<div style="display: flex; justify-content: space-between; align-items: center;"> <div style="text-align: center;">  </div> <div> Reynolds, Smith and Hills, Inc. 115 Alma Blvd, Suite 101 Merritt Island, Florida 32953-4101 (321) 453-0212 (321) 453-0223 FAX www.rsandh.com </div> </div>		
SIGNATURES		DATE		
DRAWN: JOSEPH HAUER		08-20-2013		
CHECKED: DANIEL VIGENT		08-20-2013		
SUBMITTED: ARCHIVING OF RECORD				
KEVIN HARRIS				
ST. OF LICENSEURE: FL				
LICENSE NO:				
APPROVED:				
JOHN KERCSMAR				
		<div style="display: flex; justify-content: space-between;"> <div> NATIONAL AERONAUTICS AND SPACE ADMINISTRATION JOHN F. KENNEDY SPACE CENTER, NASA KENNEDY SPACE CENTER, FLORIDA </div> <div> LAUNCH COMPLEX 39 VEHICLE ASSEMBLY BUILDING MODIFY VEHICLE ASSEMBLY BUILDING HIGH BAY 3 FOR SLS - HOISTS ELECTRICAL SCHEDULES </div> </div>		
		FILE NO	SIZE	DWG NO
		302-6058-043	E	79K39667
MIKE HARTNETT		PROJ. NO.	PCN	99000.5
		SHEET	42	OF

SPECIFIC NOTES:


A. ALL PANELS THIS SHEET ARE EXISTING. FOR EXISTING PANELS, LOADS BEING MODIFIED UNDER THIS EFFORT HAVE A CONNECTED LOAD VALUE IN THE KVA COLUMN, AS SHOWN IN THE SCHEDULES. ALL LOADS WITH KVA SHOW, REQUIRES THE INSTALLATION OF NEW BREAKERS, CONDUIT AND WIRING AS INDICATED.

A


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TYPICAL HOIST OPERATOR CONSOLELET LAYOUT
SCALE: NTS

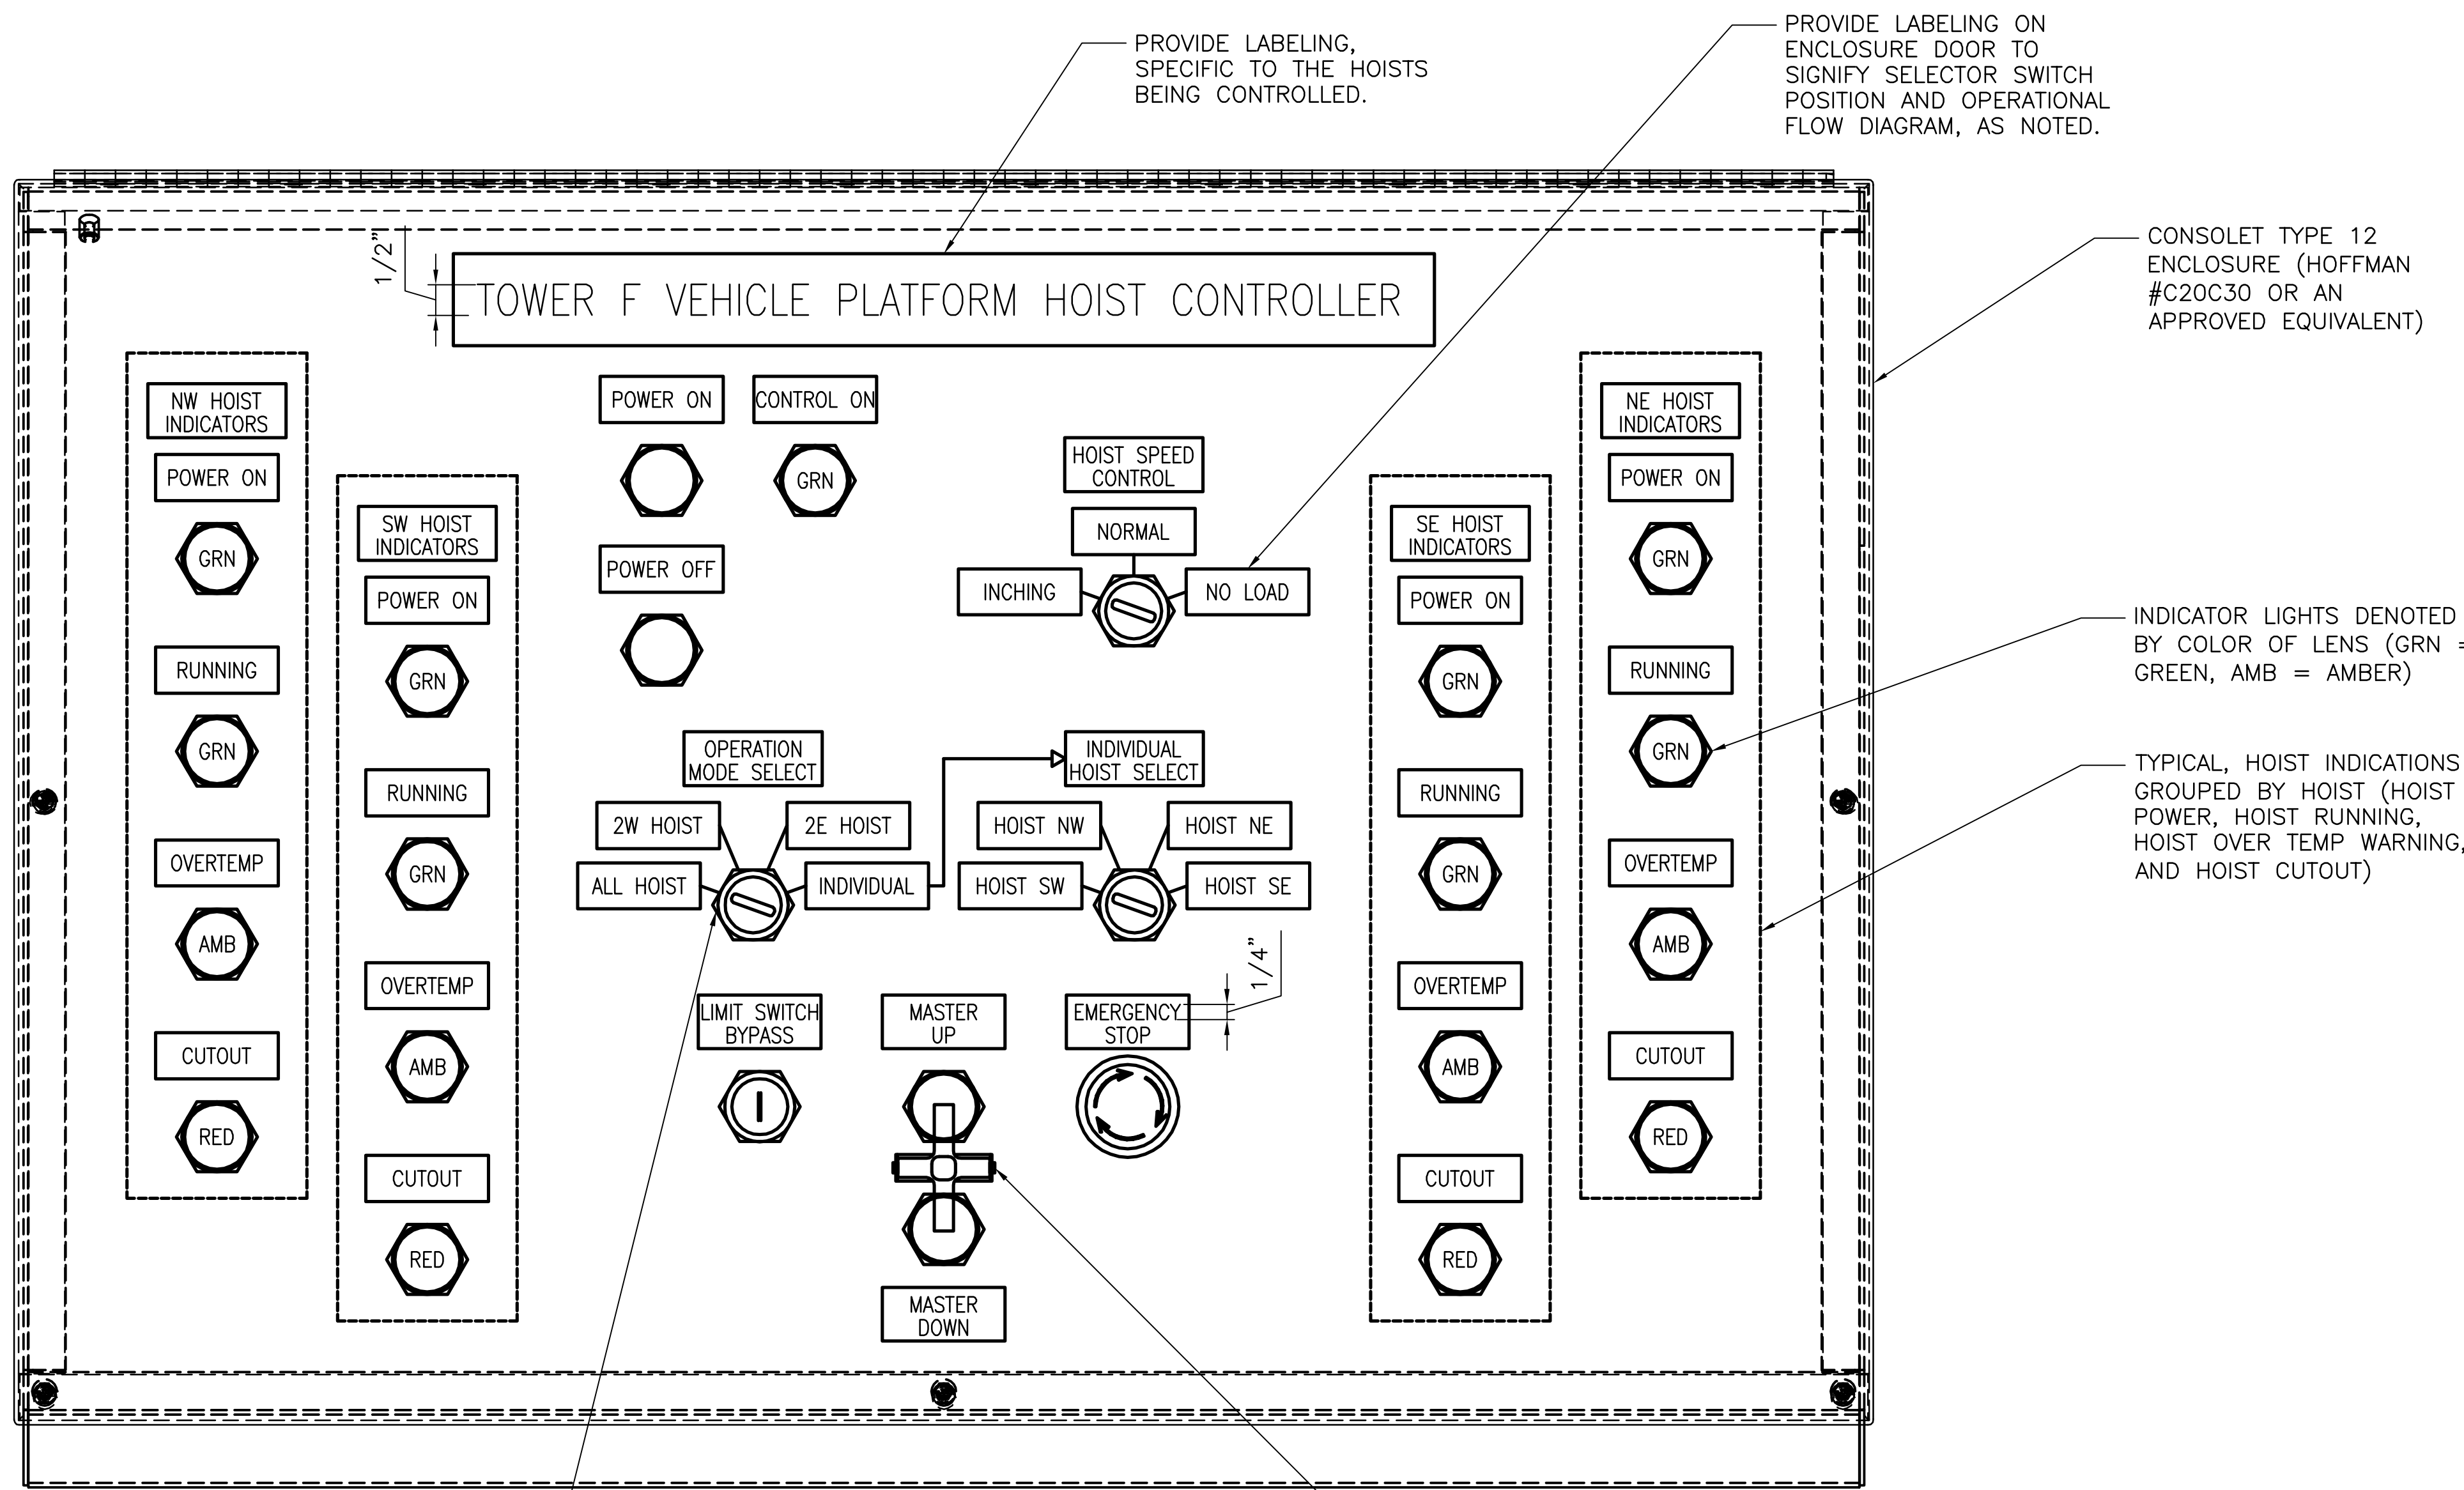

HOIST CONTROLLER ELEMENTARY BLOCK DIAGRAM
SCALE: NTS

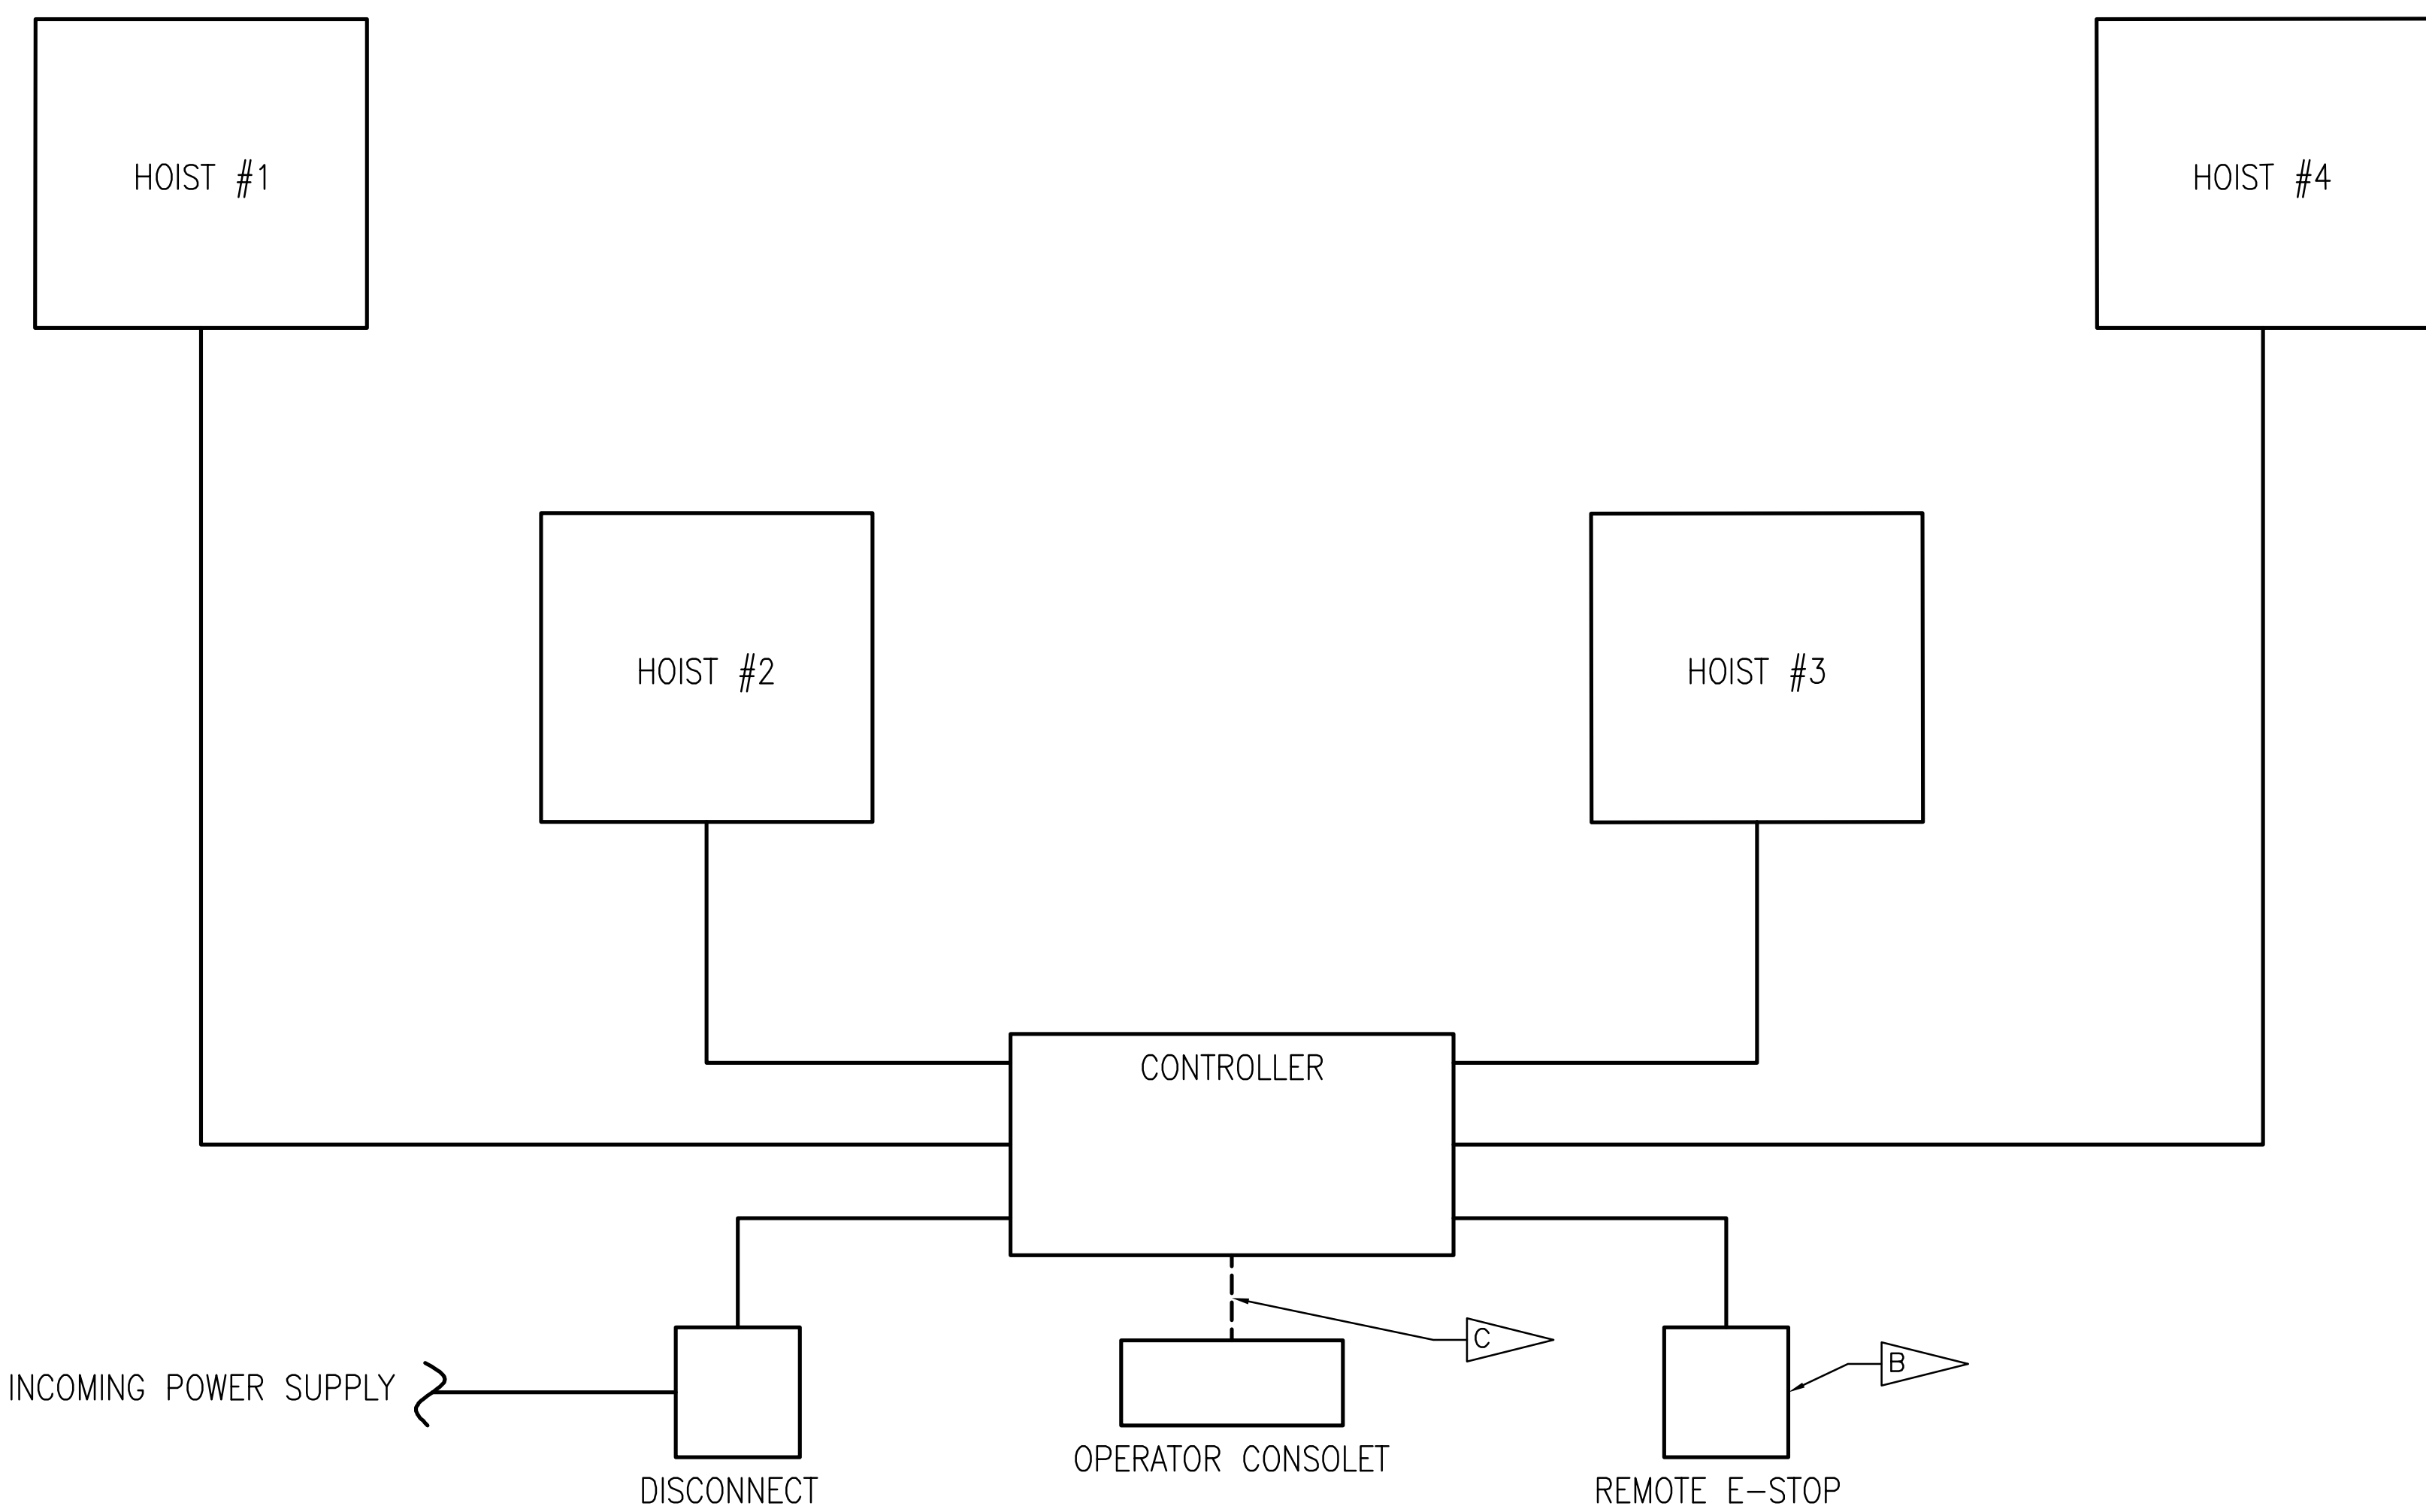

TYPICAL HOIST OPERATOR CONSOLELET SIDE VIEW
SCALE: NTS

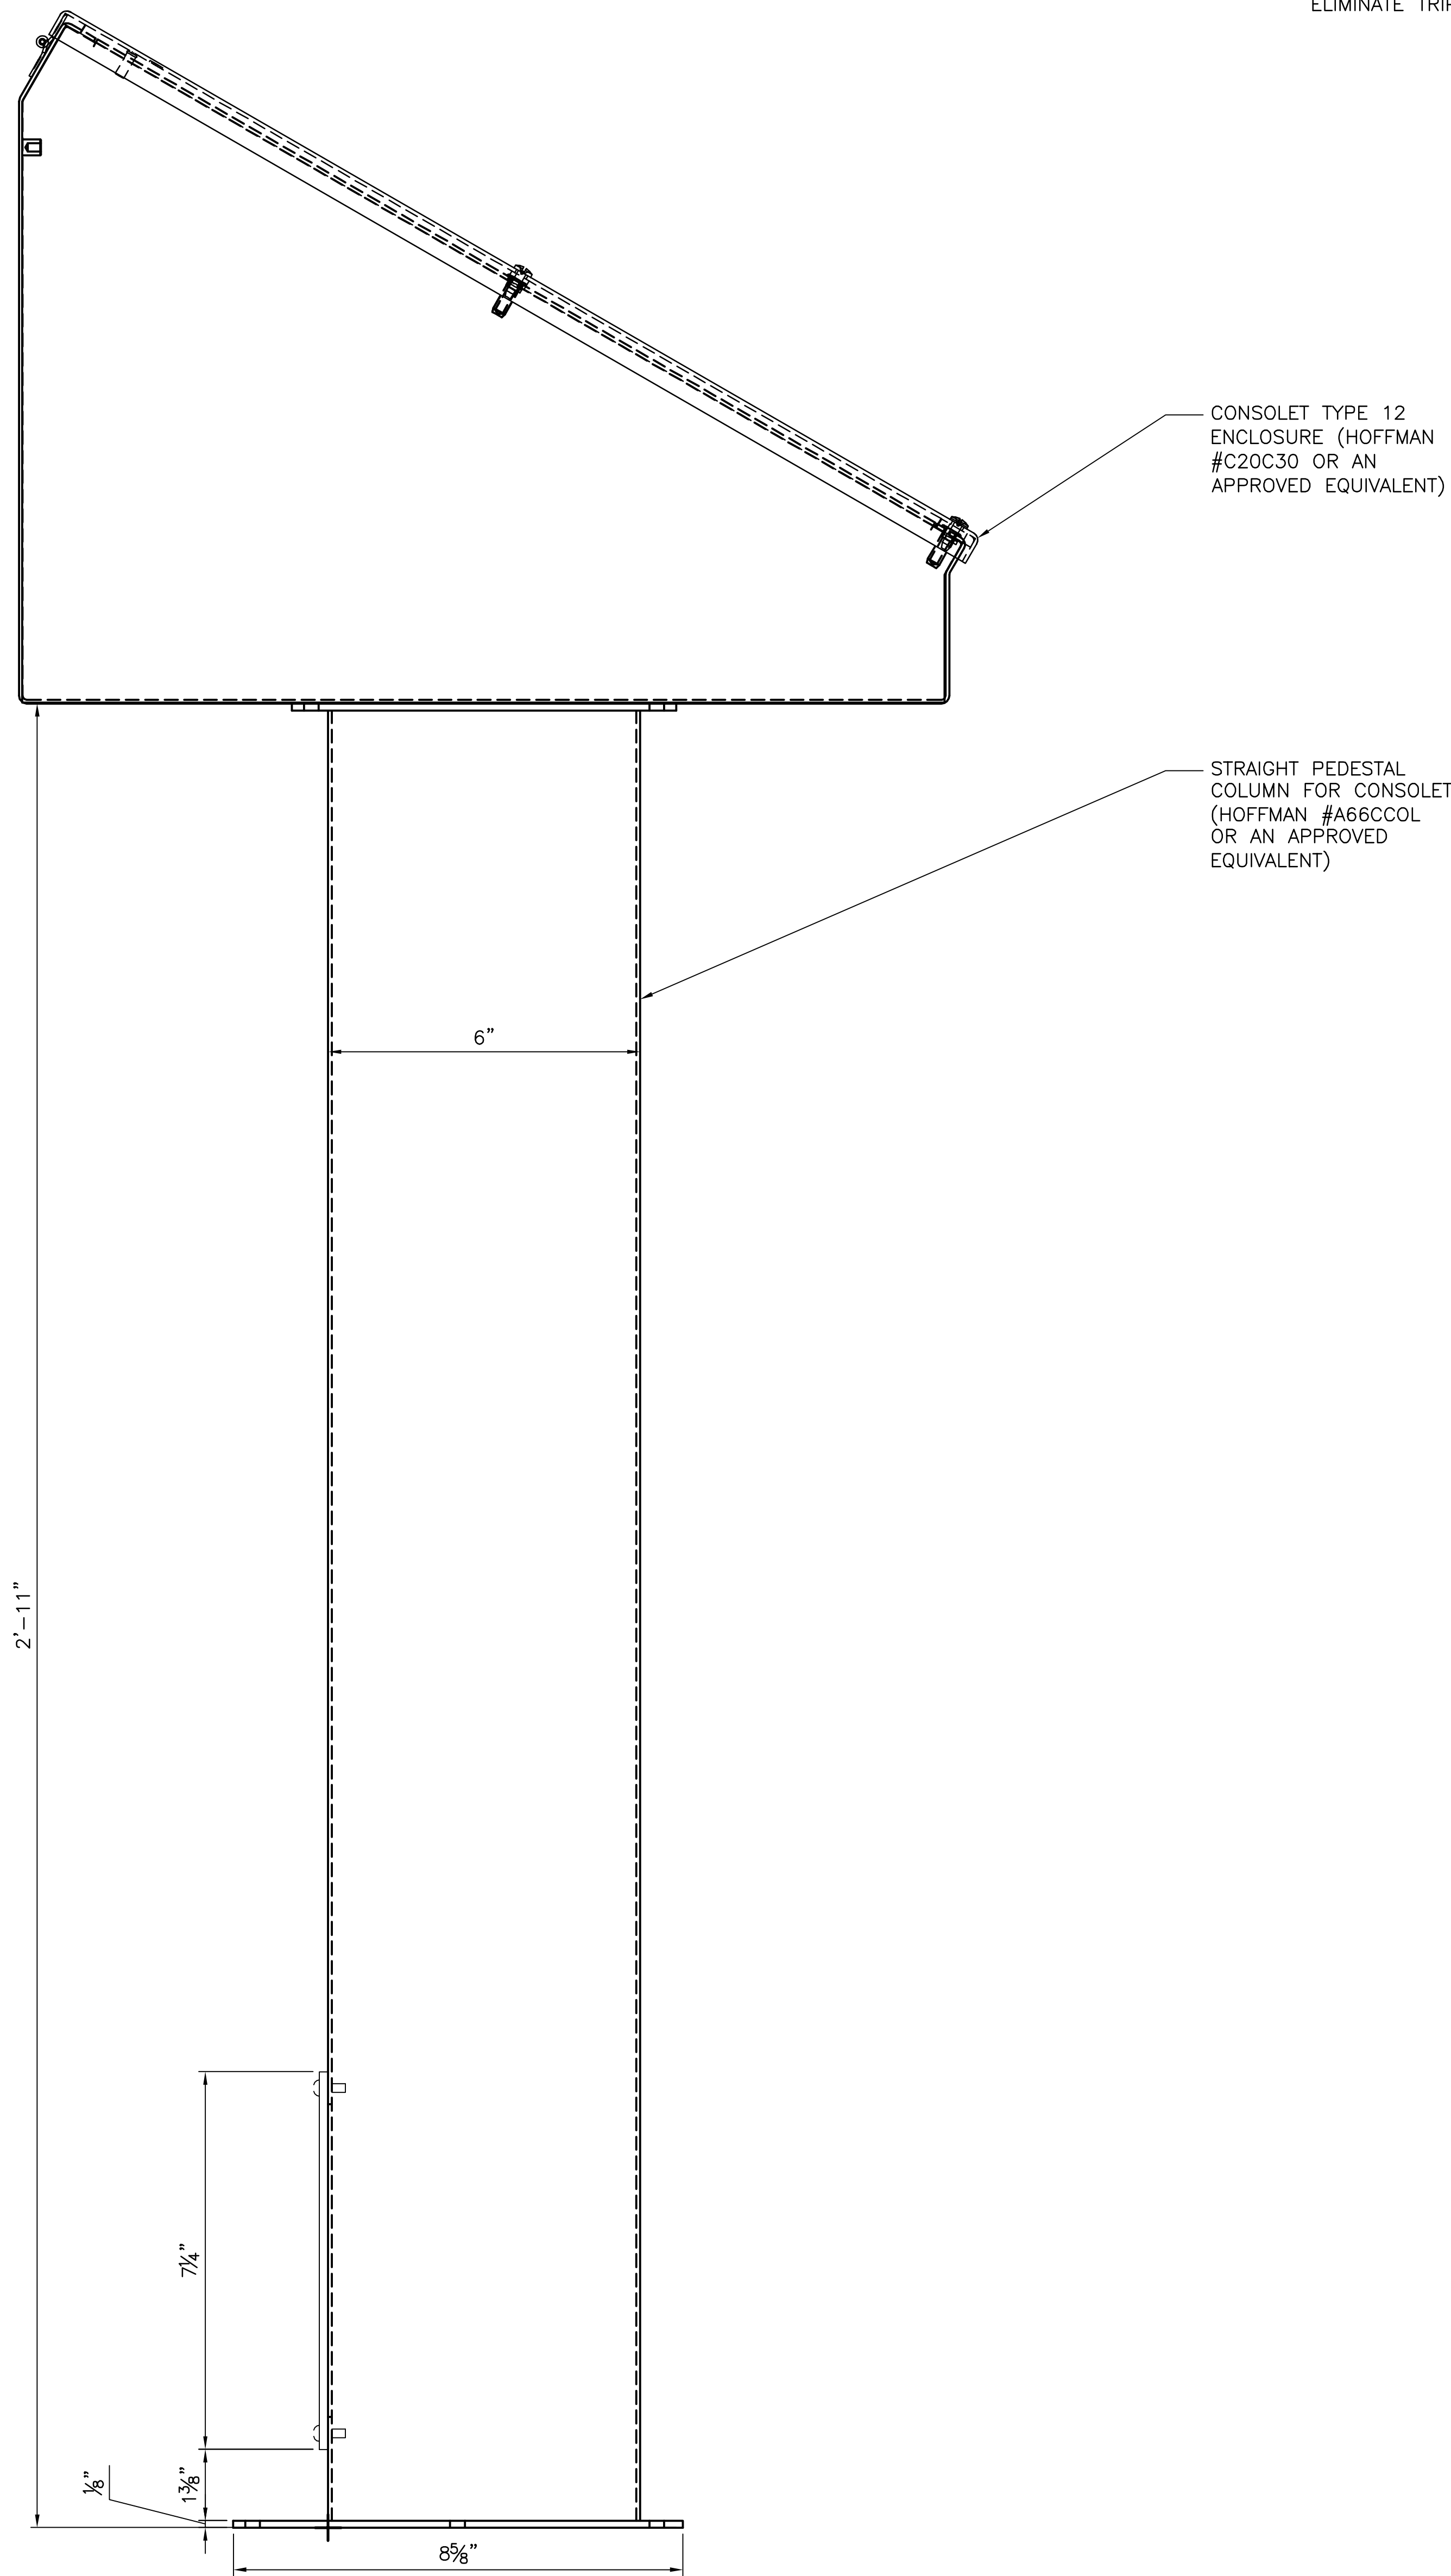SPECIFIC NOTES:

- A. THIS BLOCK DIAGRAM AND ELEVATION IS INTENDED TO DESCRIBE THE ELEMENTARY FUNCTION OF THE VEHICLE AND ELEVATOR HOIST CONTROLS. SEE SPECIFICATION 41 22 23.19 FOR REQUIRED EQUIPMENT PARAMETERS.
- B. PROVIDE EMERGENCY STOP INTERFACE JUNCTION BOX NEAR HOIST CONTROLLERS, FOR EXTENSION OF CIRCUITRY BY OTHERS.
- C. PROVIDED EXTENSION OF CONTROL CIRCUITRY TO OPERATOR CONSOLELET FOR A FULLY FUNCTIONING SYSTEM. ROUTE CONDUITS FROM THE HOIST CONTROLLER AND ENTER THE CONSOLELET PEDESTAL FROM BELOW TO ELIMINATE TRIPPING HAZARDS AROUND THE OPERATOR INTERFACE.

SYM	ZONE	DESCRIPTION	DATE	APPROVAL
REVISIONS				
SIGNATURES		DATE	NATIONAL AERONAUTICS AND SPACE ADMINISTRATION	
DRAWN: JOSEPH HAUER		08-20-2013	JOHN F. KENNEDY SPACE CENTER, NASA	
CHECKED: DANIEL VIGANT		08-20-2013	KENNEDY SPACE CENTER, FLORIDA	
SUBMITTED ARCHIVING OF RECORD:			LAUNCH COMPLEX 39	
KEVIN HARRIS			VEHICLE ASSEMBLY BUILDING	
ST OF LICENSURE: FL			MODIFY VEHICLE ASSEMBLY BUILDING	
LICENSE NO:			HIGH BAY 3 FOR SLS - HOISTS	
APPROVED:			HOIST CONTROLLER ELEVATION	
JOHN KERCSMAR			AND BLOCK DIAGRAM	
MIKE HARTNETT				
FILE NO. 302-6058-043	SIZE E	DWG. NO. 79K39667	REV	
PROJ. NO. PCN 99000.5	SHEET 43	OF 43		

WHEN PRINTED FULL SIZE, THIS SHEET IS 34"x44"
THIS COMPUTER DRAWING WAS
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E-641